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58 Princes Hwy, Dandenong

Proposed 5 storey 15 Apartment Building and Ground Level Carparking

Site Description Plan



The Locality -

1. Approx. within 700m from Dandenong Town Centre

Public Transport -

2. Bus service in Cleeland & Herbert St. (Bus stop within 250m of site)

- **3.** Dandenong train station 1klm South.
- **4.** Princes Hwy connection. Provides access to Sth

Gippsland Fwy & Monash Fwy. Public Open Space -

- **5.** Dandenong Park with, walking Trail & BBQ facilities 1.2klm South.
- 6. Mills Reserve, childs play equipment, Oval & Hockey
- fields 1.1klm North. **7.** John Hemmings Memorial Park 250m West.
- Shops -

Shops -

- 8. Dandenong Market 400m South/East of site.
- **9.** Dandenong Plaza 900m South/East of site.
- **10.** Lonsdale St shopping strip 500m South of site.

Schools -

- **11.** Market St. Child Care centre 500m east of site.
- **12.** Dandenong North primary school 600m North.
- **13.** Dandenong High School & Cleeland Secondary
- College 300m North.

Public Buildings -

- **14.** Dandenong & District Hospital 900m North of site.
- **15.** Dandenong Library 700m South/East of site.
- 16. Chisolm Institute of Tafe (Dandenong) 800m, North.
- **17.** Oasis Indoor Heated swimming pool 1.3Klm, North.
- **18.** Dandenong Basketball Stadium 2.3Klm North.

General -

19. The subject site has a slight fall from South/West street front

- high side to Rear North/East. Approximately 500mm.
- **20.** North orientation to the internal corner of the site.
- **21.** Existing crossover on the North/West corner of site.
- **22.** Minimal existing vegetation on site.
- 23. No vegetation to the the nature strip at the front of site.24. Some street front assets are located within nature strip
- which should be noted.
- **25.** Streetfront setback avergae is 8.6m.

26. Note location of existing fences generally in favour of existing title boundaries.



ADVERTISED PLAN

Amendment C: 23/10/23 - Car stacker platform depth 5.5m. Ground Floor eastern

setback reduced to 1.2m

TRE

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- Separate Entry to foyer from Carpark
- Internal windows to provide view lines along foyer corridor
 Additional communal open space to rear of the site
- Bed 1 of Apts 4,9,6,11 & 14 min. 3.4m deep
- Storage calculations for each Apt listed. 1 Bed - 10m3 with 6m3 min. internal.
- 2 Bed 14m3 with 9m3 min. internal
- Balcony balustrade to Princes Hwy frontage modified to be open metal vertical slat

- June 22 Shadow Diagrams included - Screening added to Level 3 N/W windows & communal

open space

Amendment B : 23/08/23

- Re-design building from 5 levels to 4 - Apartment reduced from 15 to 14
- Double car stacking design included to Ground Floor level parking

Amendment A : 28/02/23

Amended Ground Floor layout.
 Entry foyer widened to South/East boundary.
 Inclusion of windows to the GF facade to soften the interface.

- Storage sheds bought toward the front of the Carpark. Bin location moved internally. Dedicated pedestrian path along the internal driveway.
- Increased Communal Open Space to the rear - Increased variation to the facade including the use of dark
- timber cladding to front balustrades & colour tone variation to the side elevations
- Screening to the Bedroom windows to the North/West altered from opaque glass to fixed horizontal louvres fixed to the facade - Apts 1,2,5,6,9,10,14,15 modified to ensure Standard D18 Accessibility compliant
- Internal storage claculations nominatedCross flow ventilation paths demonstrated on floor plans

Drg No. PA TP1(C)

Project : Apartment Building

Proprietor :

Aaron Zhou


Job Location :

58 Princes Hwy, Dandenong

Drawn By. :	J.A.G, A.G	Date :	23/10/23
Mel. Ref. :	90 B6	Job No. :	22-000
Sheet No. :	1 OF 7(C)	Scale. :	1:150



OVERTI

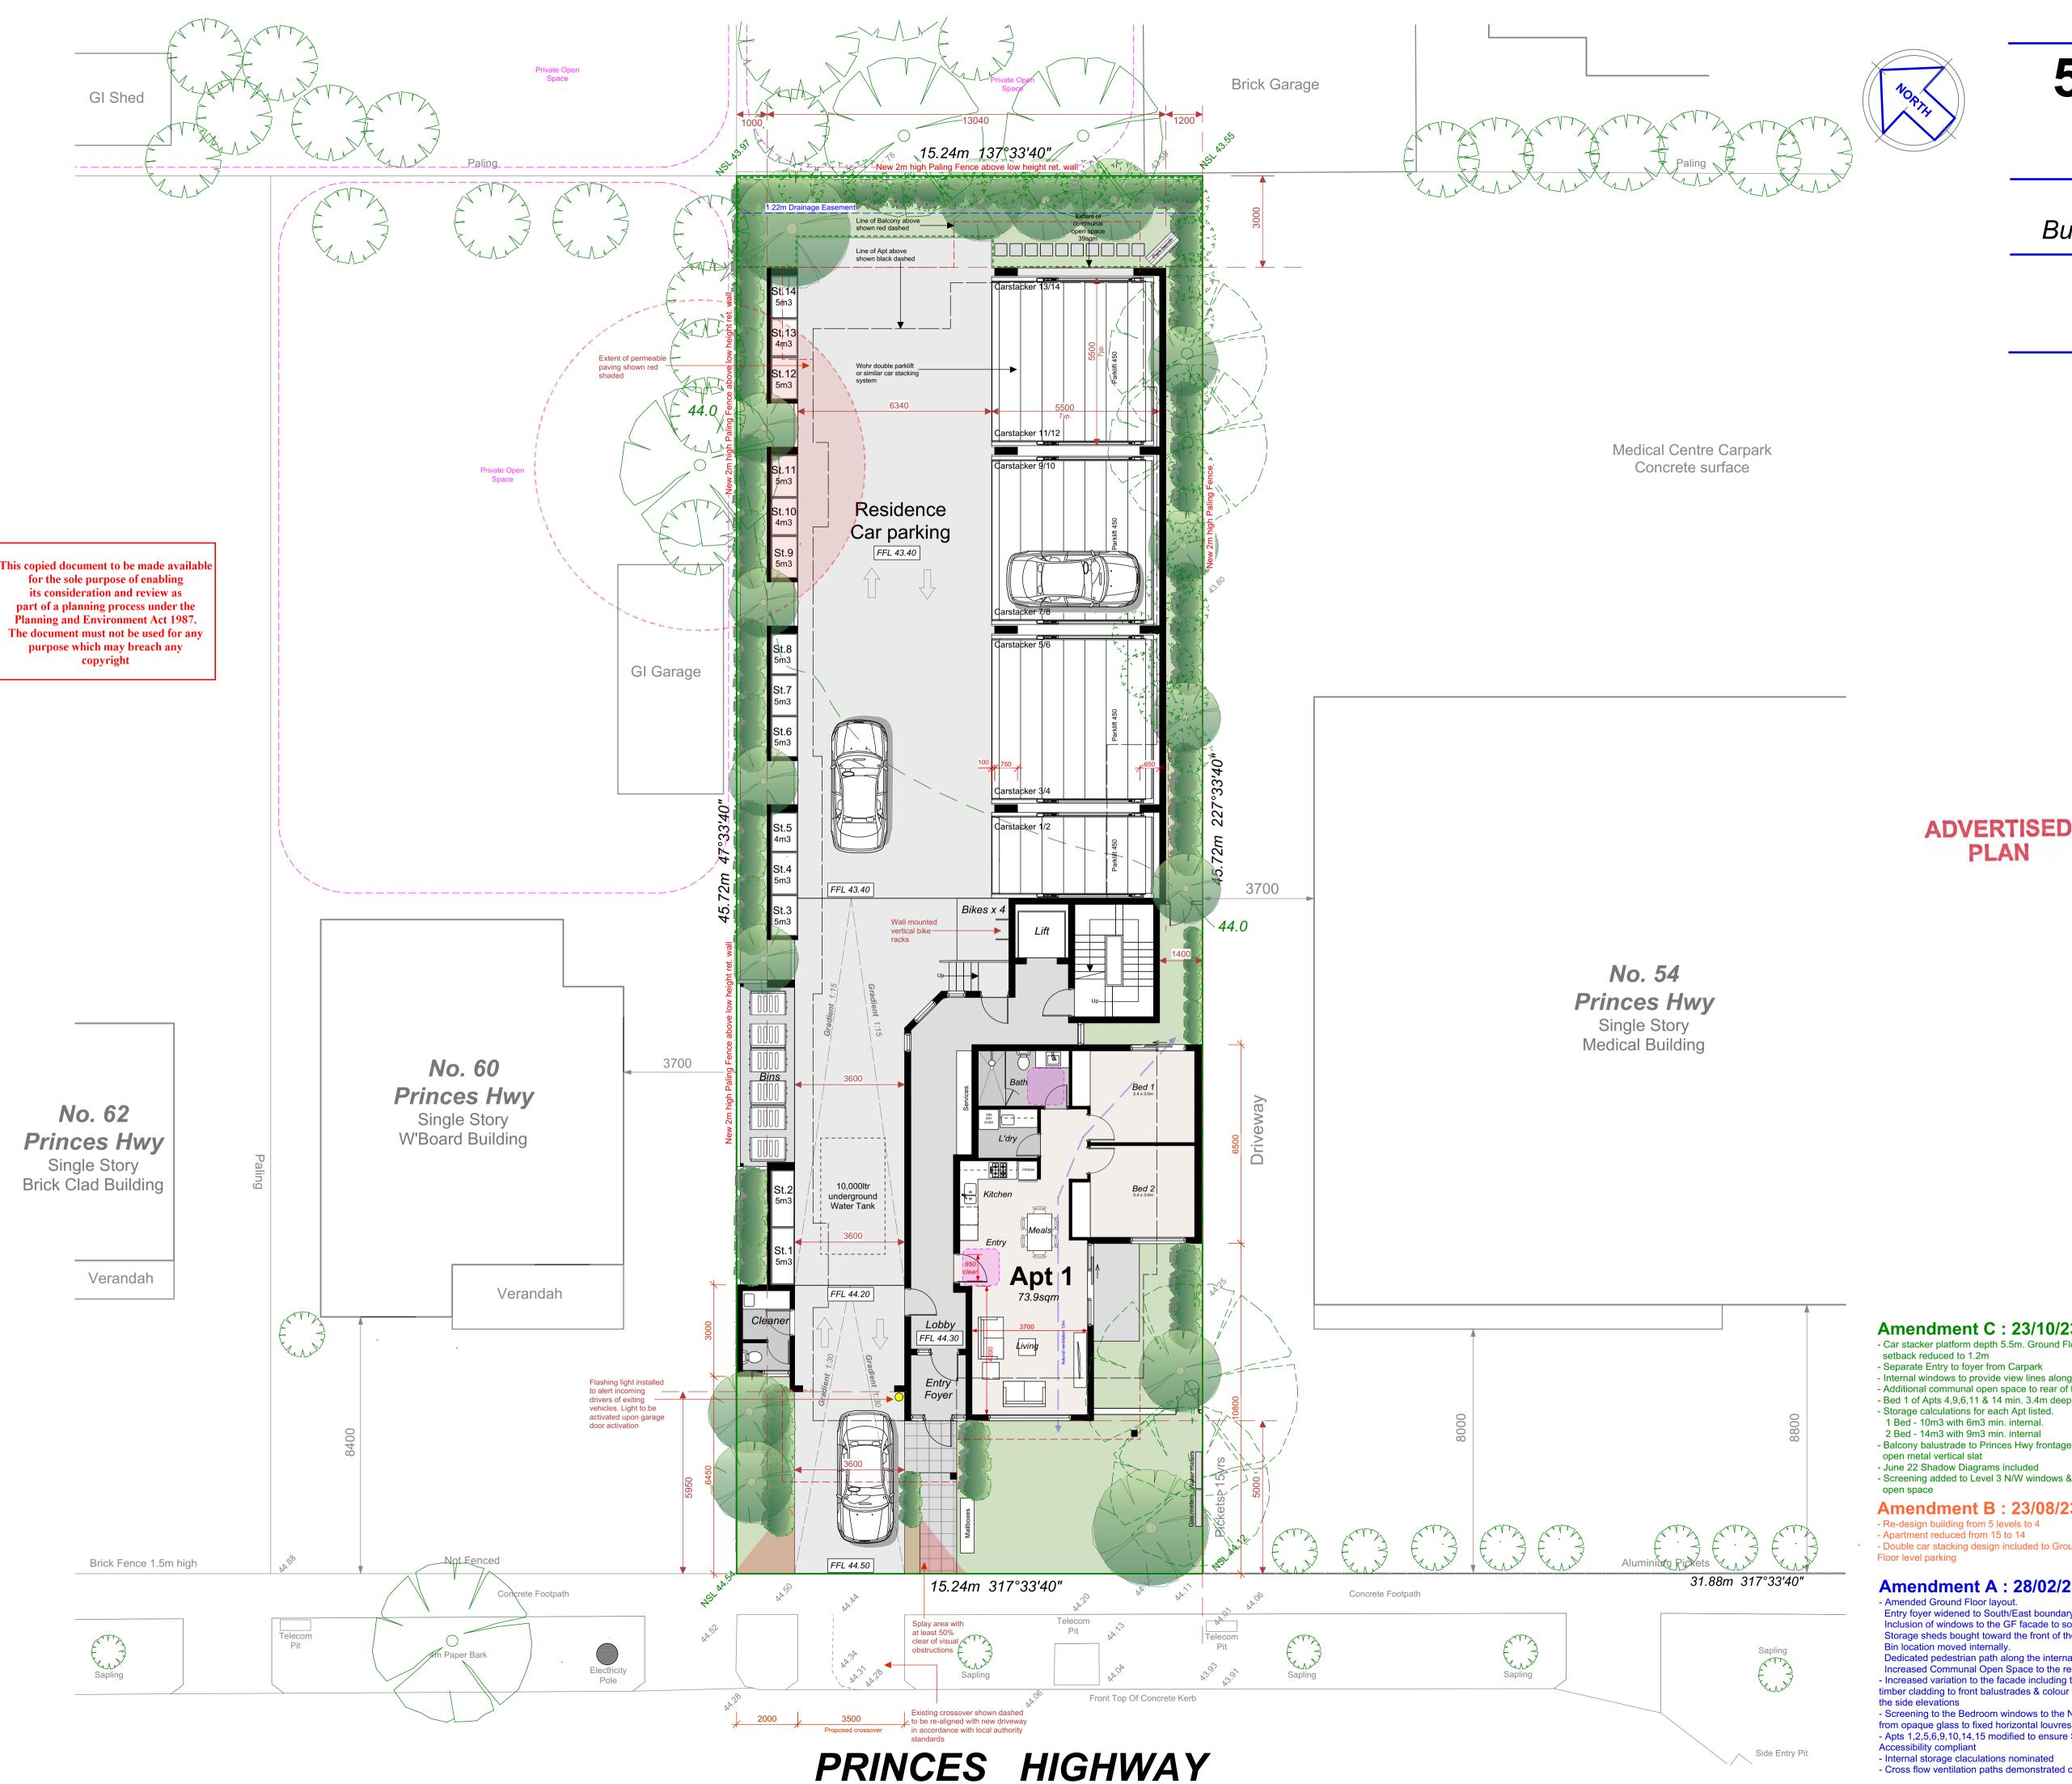

58 Princes Hwy, Dandenong

Proposed 4 Storey 14 Apartment Building & Ground Level Carparking



SITE STATISTICS

Site Area -	696.8 sqm
Building Area - (Ground Floor incl. Carpark)	488.1 sqm
Site Coverage % -	70.0%
Building & Hard Surface Area (Incls. Driveway & paths)	521.2 sqm
Site Coverage % -	74.8%
No. of Units -	14 x Apartments 11 x 2 Bed 3 x 1 Bed
Density -	1:49 sqm
No. of Carspaces -	14 Total 1 per Apt. carstacker No Visitors spaces
LEGE	ND



Proposed landscape layout shown indicative only Refer Landscape Designers drawings



Apt ' Kitche

Joquin	Renorm
9sqm	Bed Robes
<u>3sqm</u>	Bath/L'dry
2sqm	Total Int.
Dm3	Total Ext.

KEY ESD INITIATIVES

- Utility Meters for each Apartment
- Common areas to be sub-metered - All external area lighting to be controlled
- through motion/daylight sensor - 10,000ltr rainwater tank for toilet flushing & irrigation
- Water efficient fittings
- Toilets min. 4 star WELS rated
- Taps min. 5 star WELS rated
- Shrs min. 4 star WELS rated (max. 7.5ltr/min) - Water efficient appliances (3 star D/washer)
- 7.5 star average energy rating
- 15kW Solar PV system
- Heat pump hot water system
- High efficiency air conditioning systems (Heating 4 star. Cooling 4 star)
- Efficient lighting (LED) 4w/sqm to all habitable areas
- High performance glazing to all windows (Double glazing) - Natural ventilation to dwellings
- (Refer to cross flow diagrams)
- Excellent daylight to habitable spaces - Low VOC paints to improve indoor environment quality for residents
- Sustainable timber
- Water efficient landscaping - 5 Electric car charging point within carpark (32amp Min.) - 4 Bicycle spaces

Drg No. PA TP2(C)

Project :

Apartment Building


Proprietor :

Aaron Zhou

Job Location :

58 Princes Hwy, Dandenong

Drawn By. :	J.A.G, A.G	Date :	23/10/23
Mel. Ref. :	90 B6	Job No. :	22-000
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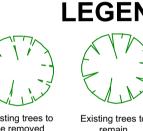


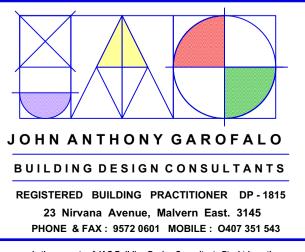
PLAN

Amendment C : 23/10/23


- Car stacker platform depth 5.5m. Ground Floor eastern

- Separate Entry to foyer from Carpark
- Internal windows to provide view lines along foyer corridor
- Additional communal open space to rear of the site
- Bed 1 of Apts 4,9,6,11 & 14 min. 3.4m deep - Storage calculations for each Apt listed.
- 1 Bed 10m3 with 6m3 min. internal.
- 2 Bed 14m3 with 9m3 min. internal
- Balcony balustrade to Princes Hwy frontage modified to be
- open metal vertical slat - June 22 Shadow Diagrams included - Screening added to Level 3 N/W windows & communal
- **Amendment B : 23/08/23** - Re-design building from 5 levels to 4
- Apartment reduced from 15 to 14 - Double car stacking design included to Ground
- **Amendment A : 28/02/23**
- Amended Ground Floor layout. Entry foyer widened to South/East boundary.
- Inclusion of windows to the GF facade to soften the interface. Storage sheds bought toward the front of the Carpark.
- Bin location moved internally. Dedicated pedestrian path along the internal driveway.
- Increased Communal Open Space to the rear - Increased variation to the facade including the use of dark timber cladding to front balustrades & colour tone variation to
- Screening to the Bedroom windows to the North/West altered from opaque glass to fixed horizontal louvres fixed to the facade - Apts 1,2,5,6,9,10,14,15 modified to ensure Standard D18
- Internal storage claculations nominated - Cross flow ventilation paths demonstrated on floor plans



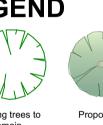



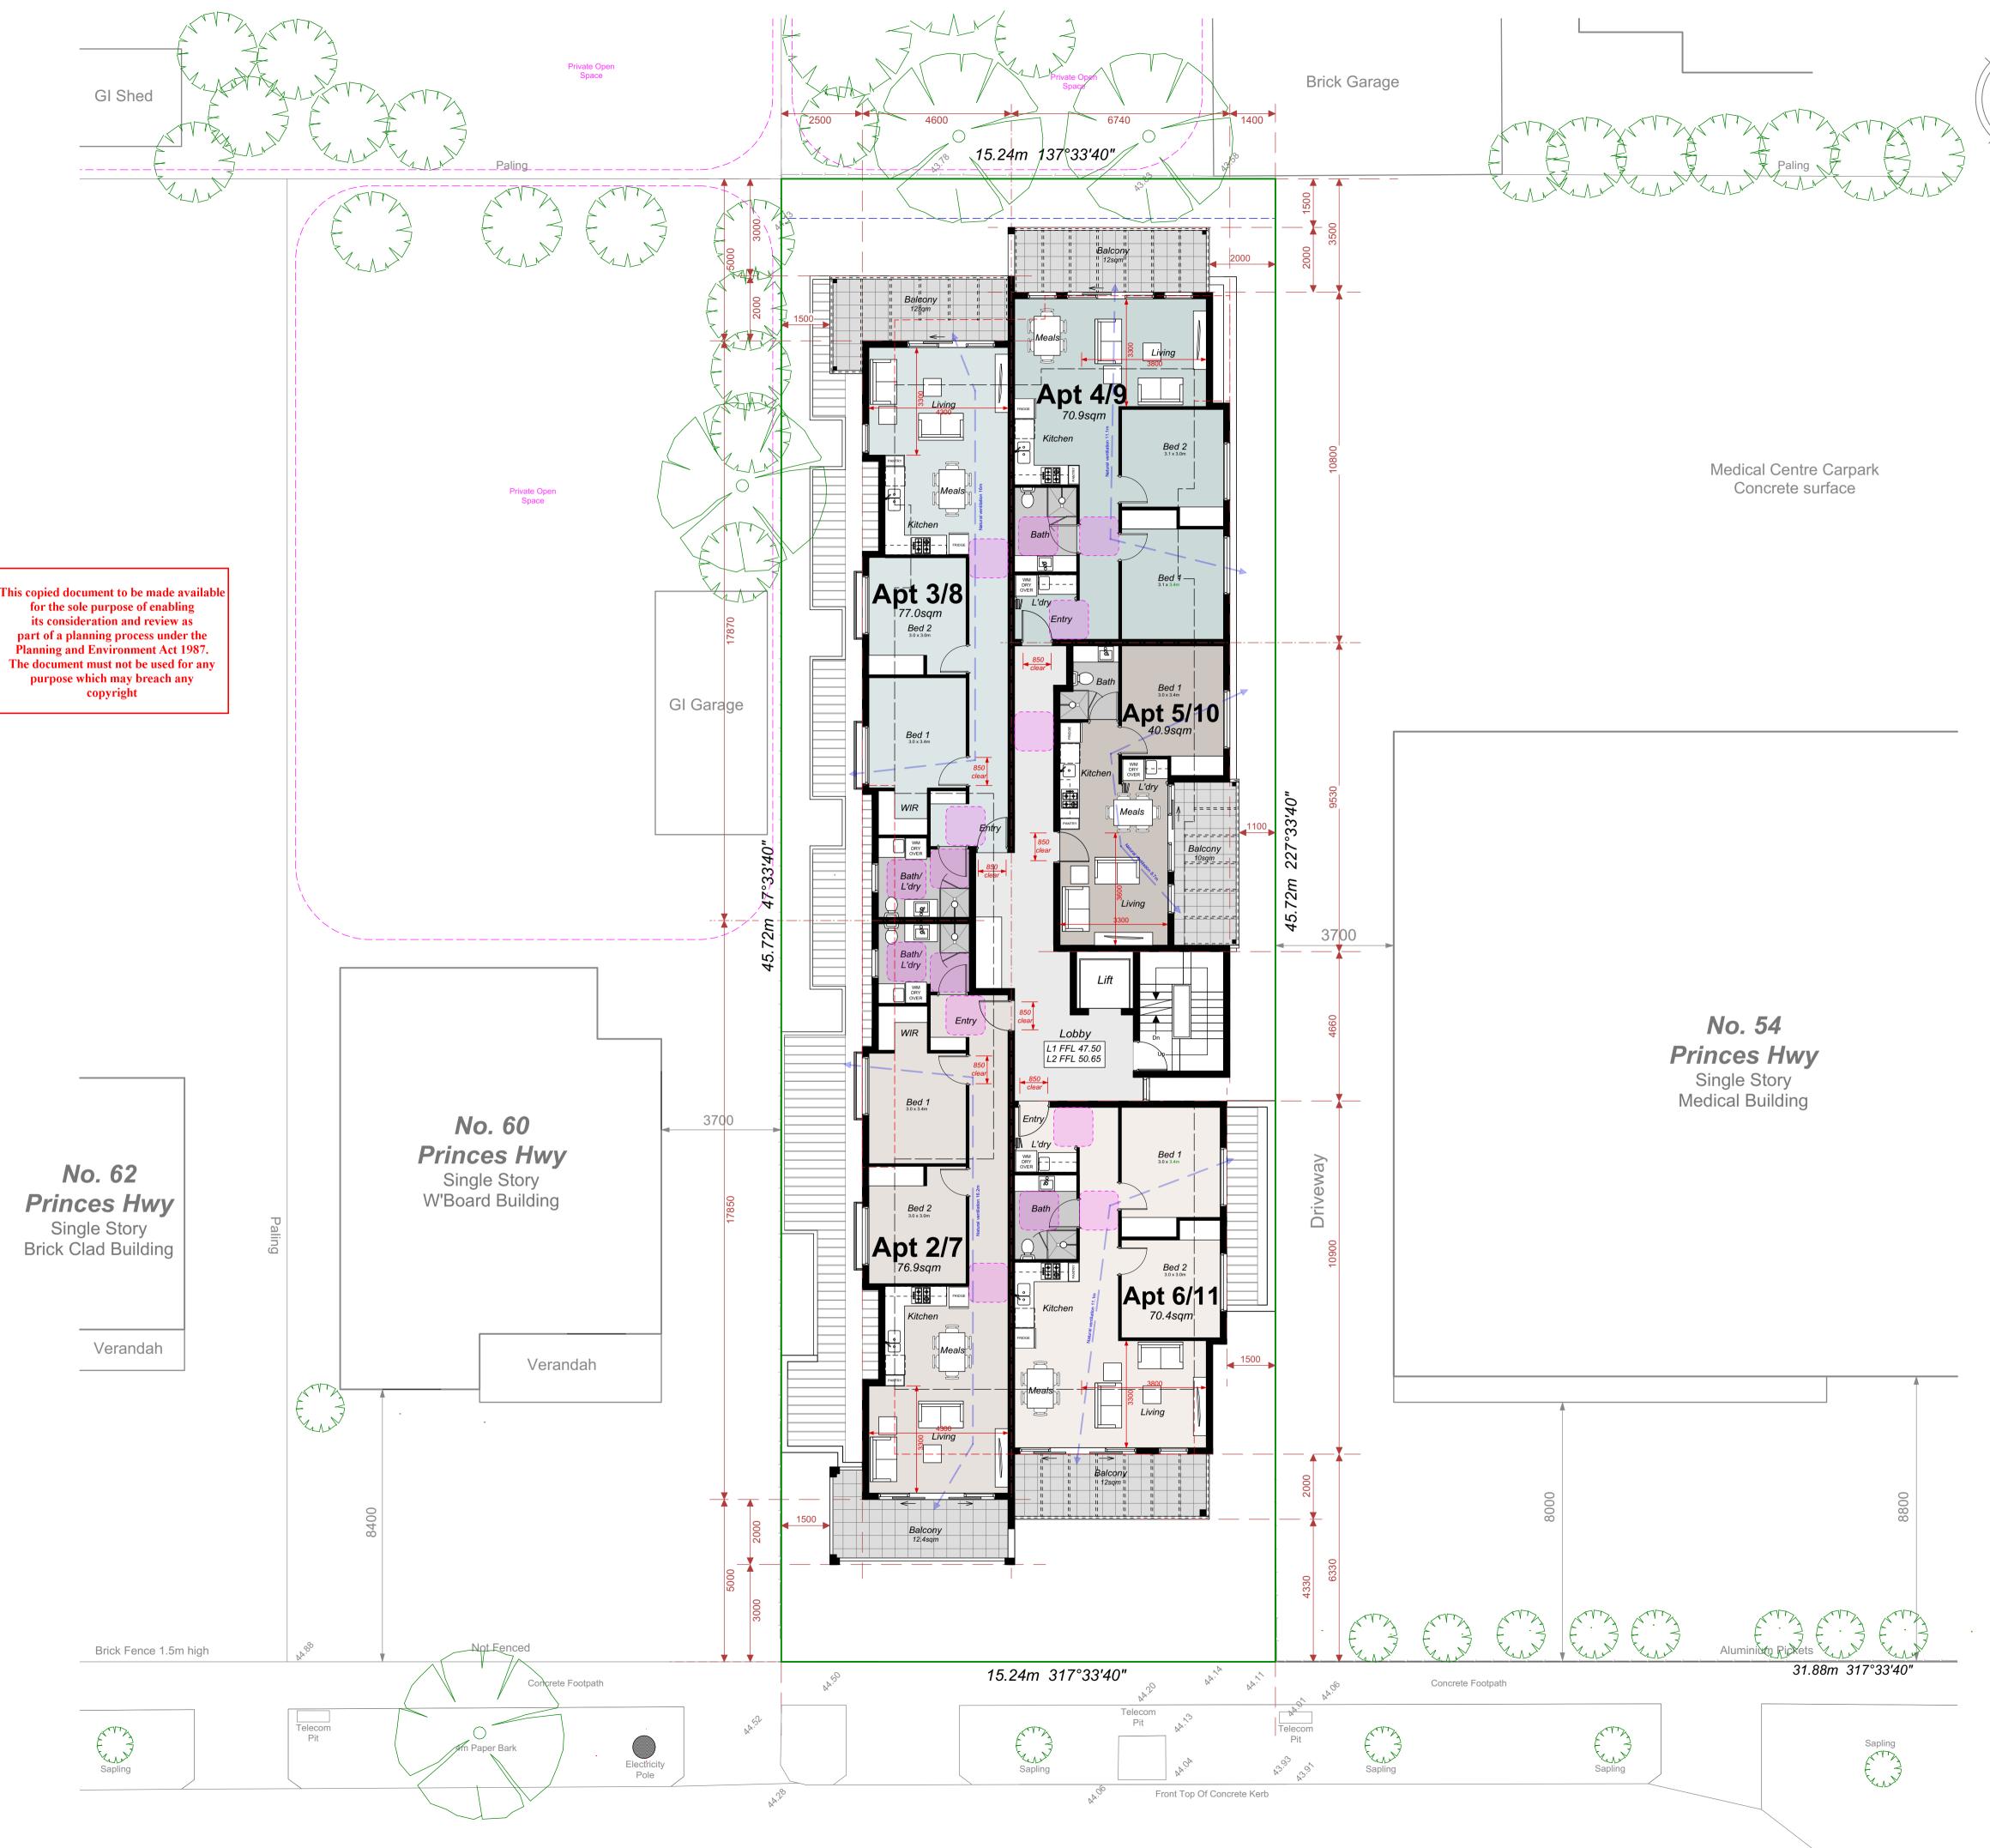

PRINCES HIGHWAY

Side Entry Pit



58 Princes Hwy, Dandenong

Proposed 4 Storey 14 Apartment Building & Ground Level Carparking



LEGEND

Denotes 1.2 x 1.2m circulation space (Any door within this space to have readily removable hinges)

Denotes Natural cross flow ventilation path

APT. STORAGE

Apts 2/7	7
2.1sqm	Kitchen
5.7sqm	Bed Robes/WIR
1.2sqm	Linen
0.65sqm	Bath/L'dry
9.65sqm	Total Int.
5.0m3	Total Ext.

Apts 3/8

2.1sqmKitchen5.7sqmBed Robes/WIR1.2sqmLinen0.65sqmBath/L'dry9.65sqmTotal Int.5.0m3Total Ext.

Apts 4/9

2.4sqm Kitchen 4.9sqm Bed Robes <u>1.8sqm</u> Bath/L'dry 9.1sqm Total Int. 5.0m3 Total Ext.

Apts 5/10

.3sqm	Kitchen
6sqm	Bed Robe
2sqm	Bath/L'dry
1sqm	Total Int.
0m3	Total Ext.

Apts 6/11

2.4sqm Kitchen 4.9sqm Bed Robes <u>1.8sqm</u> Bath/L'dry 9.1sqm Total Int. 5.0m3 Total Ext.

Amendment C : 23/10/23 - Car stacker platform depth 5.5m. Ground Floor eastern

- setback reduced to 1.2m
- Separate Entry to foyer from Carpark - Internal windows to provide view lines along foyer corridor
- Additional communal open space to rear of the site
- Bed 1 of Apts 4,9,6,11 & 14 min. 3.4m deep - Storage calculations for each Apt listed.
- 1 Bed 10m3 with 6m3 min. internal.
- 2 Bed 14m3 with 9m3 min. internal
- Balcony balustrade to Princes Hwy frontage modified to be open metal vertical slat
- June 22 Shadow Diagrams included - Screening added to Level 3 N/W windows & communal open space

Amendment B : 23/08/23 - Re-design building from 5 levels to 4

- Apartment reduced from 15 to 14 - Double car stacking design included to Ground Floor level parking

Amendment A : 28/02/23

- Amended Ground Floor layout. Entry foyer widened to South/East boundary. Inclusion of windows to the GF facade to soften the interface. Storage sheds bought toward the front of the Carpark. Bin location moved internally.

- Dedicated pedestrian path along the internal driveway.
- Increased Communal Open Space to the rear - Increased variation to the facade including the use of dark

timber cladding to front balustrades & colour tone variation to the side elevations - Screening to the Bedroom windows to the North/West altered

from opaque glass to fixed horizontal louvres fixed to the facade - Apts 1,2,5,6,9,10,14,15 modified to ensure Standard D18 Accessibility compliant

- Internal storage claculations nominated
- Cross flow ventilation paths demonstrated on floor plans

Drg No. PA TP3(C)

Project :

Apartment Building


Proprietor :

Aaron Zhou

Job Location :


58 Princes Hwy, Dandenong

Drawn By. :	J.A.G, A.G	Date :	23/10/23
Mel. Ref. :	90 B6	Job No. :	22-000
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ADVERTISED PLAN

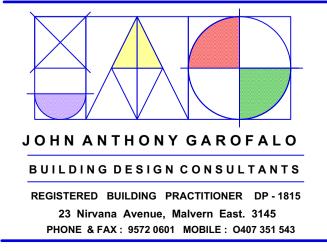

PRINCES HIGHWAY

Side Entry Pit

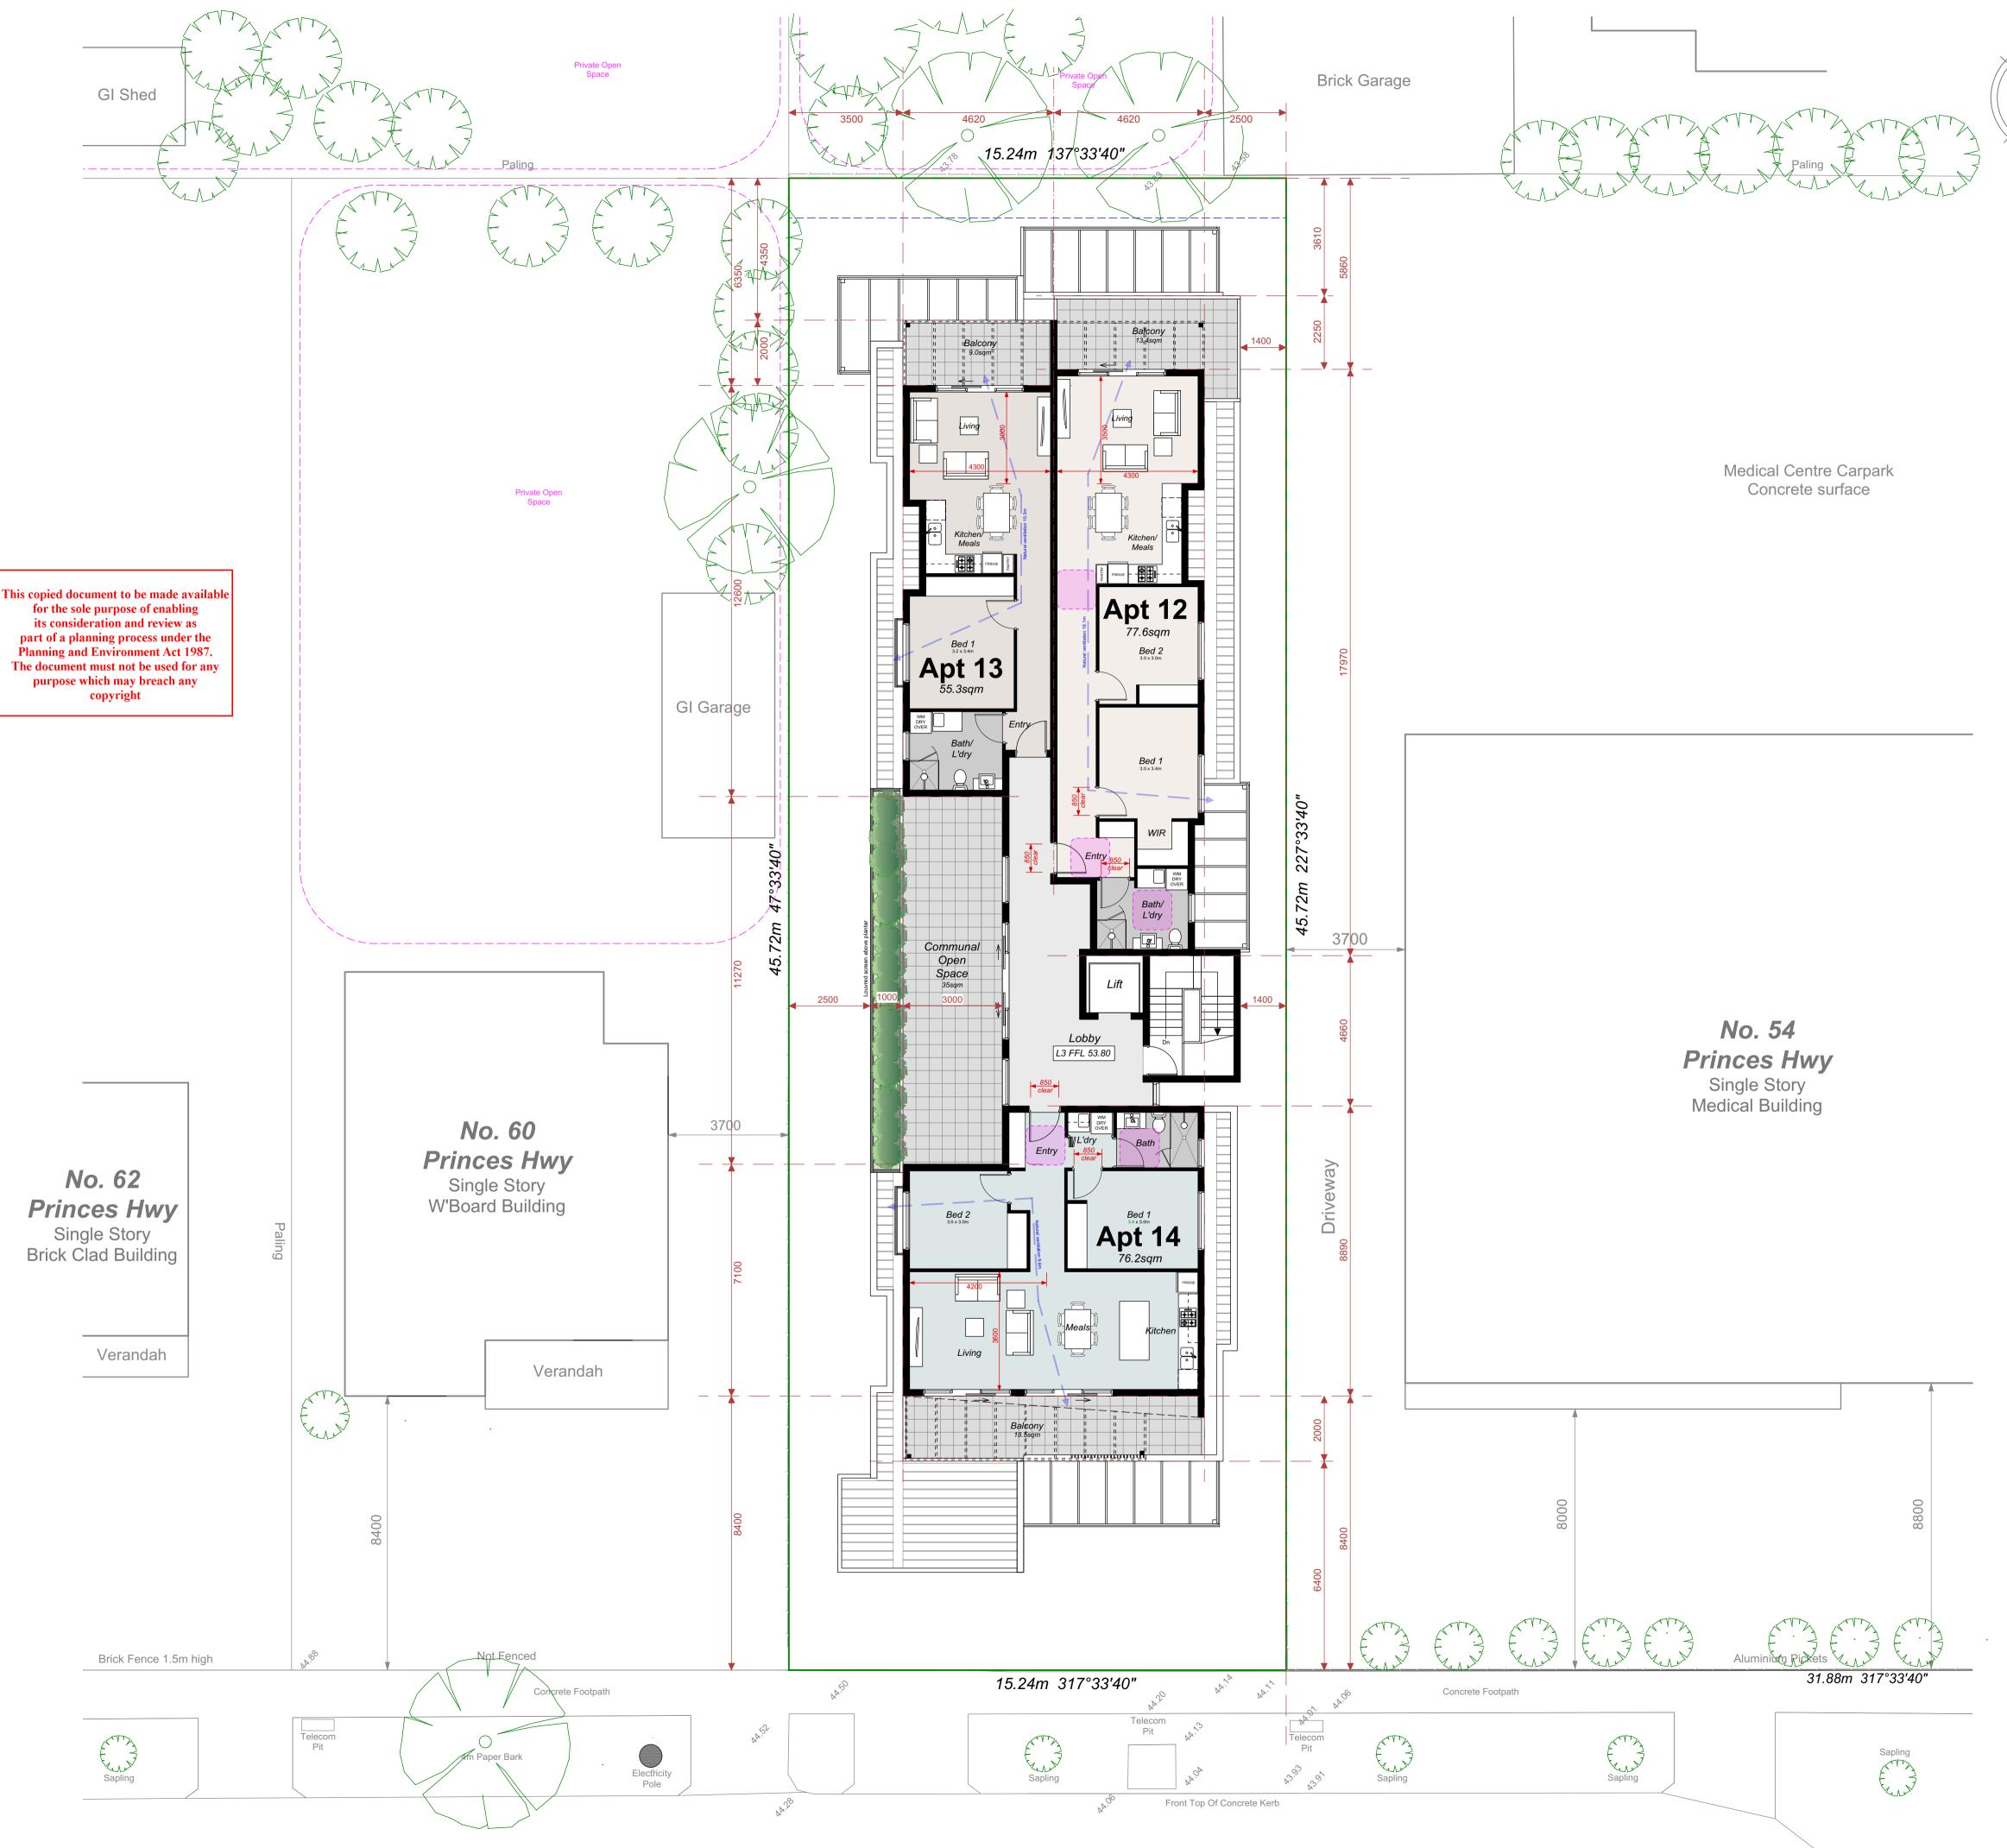

58 Princes Hwy, Dandenong

Proposed 4 Storey 14 Apartment Building & Ground Level Carparking



LEGEND

Denotes 1.2 x 1.2m circulation space (Any door within this space to have readily removable hinges)

Denotes Natural cross flow ventilation path

APT. STORAGE

Apt 12

2.1sqm Kitchen 5.6sqm Bed Robes/WIR 1.2sqm Linen

0.65sqm Bath/L'dry 9.55sqm Total Int. 5.0m3 Total Ext.

Apt 13

1.8sqm Kitchen 4.0sqm Bed Robe 0.5sqm Bath/L'dry 6.3sqm Total Int. 4.0m3 Total Ext.

Apt 14

2.2sqm Kitchen 5.9sqm Bed Robes 3.1sqm Bath/L'dry/Entry 11.2sqm Total Int. 5.0m3 Total Ext.

Amendment C : 23/10/23

- Car stacker platform depth 5.5m. Ground Floor eastern setback reduced to 1.2m

- Separate Entry to foyer from Carpark - Internal windows to provide view lines along foyer corridor
- Additional communal open space to rear of the site - Bed 1 of Apts 4,9,6,11 & 14 min. 3.4m deep - Storage calculations for each Apt listed.
- 1 Bed 10m3 with 6m3 min. internal 2 Bed - 14m3 with 9m3 min. internal
- Balcony balustrade to Princes Hwy frontage modified to be open metal vertical slat
- June 22 Shadow Diagrams included - Screening added to Level 3 N/W windows & communal open space

Amendment B : 23/08/23

Re-design building from 5 levels to 4
Apartment reduced from 15 to 14

- Double car stacking design included to Ground Floor level parking

Amendment A : 28/02/23

- Amended Ground Floor layout. Entry foyer widened to South/East boundary. Inclusion of windows to the GF facade to soften the interface. Storage sheds bought toward the front of the Carpark.

- Bin location moved internally. Dedicated pedestrian path along the internal driveway.
- Increased Communal Open Space to the rear - Increased variation to the facade including the use of dark
- timber cladding to front balustrades & colour tone variation to the side elevations

- Screening to the Bedroom windows to the North/West altered from opaque glass to fixed horizontal louvres fixed to the facade - Apts 1,2,5,6,9,10,14,15 modified to ensure Standard D18

- Accessibility compliant - Internal storage claculations nominated
- Cross flow ventilation paths demonstrated on floor plans

Drg No. PA TP4(C)

Project :

Apartment Building

Proprietor :

Aaron Zhou

Job Location :


58 Princes Hwy, Dandenong

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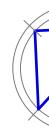


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ADVERTISED PLAN



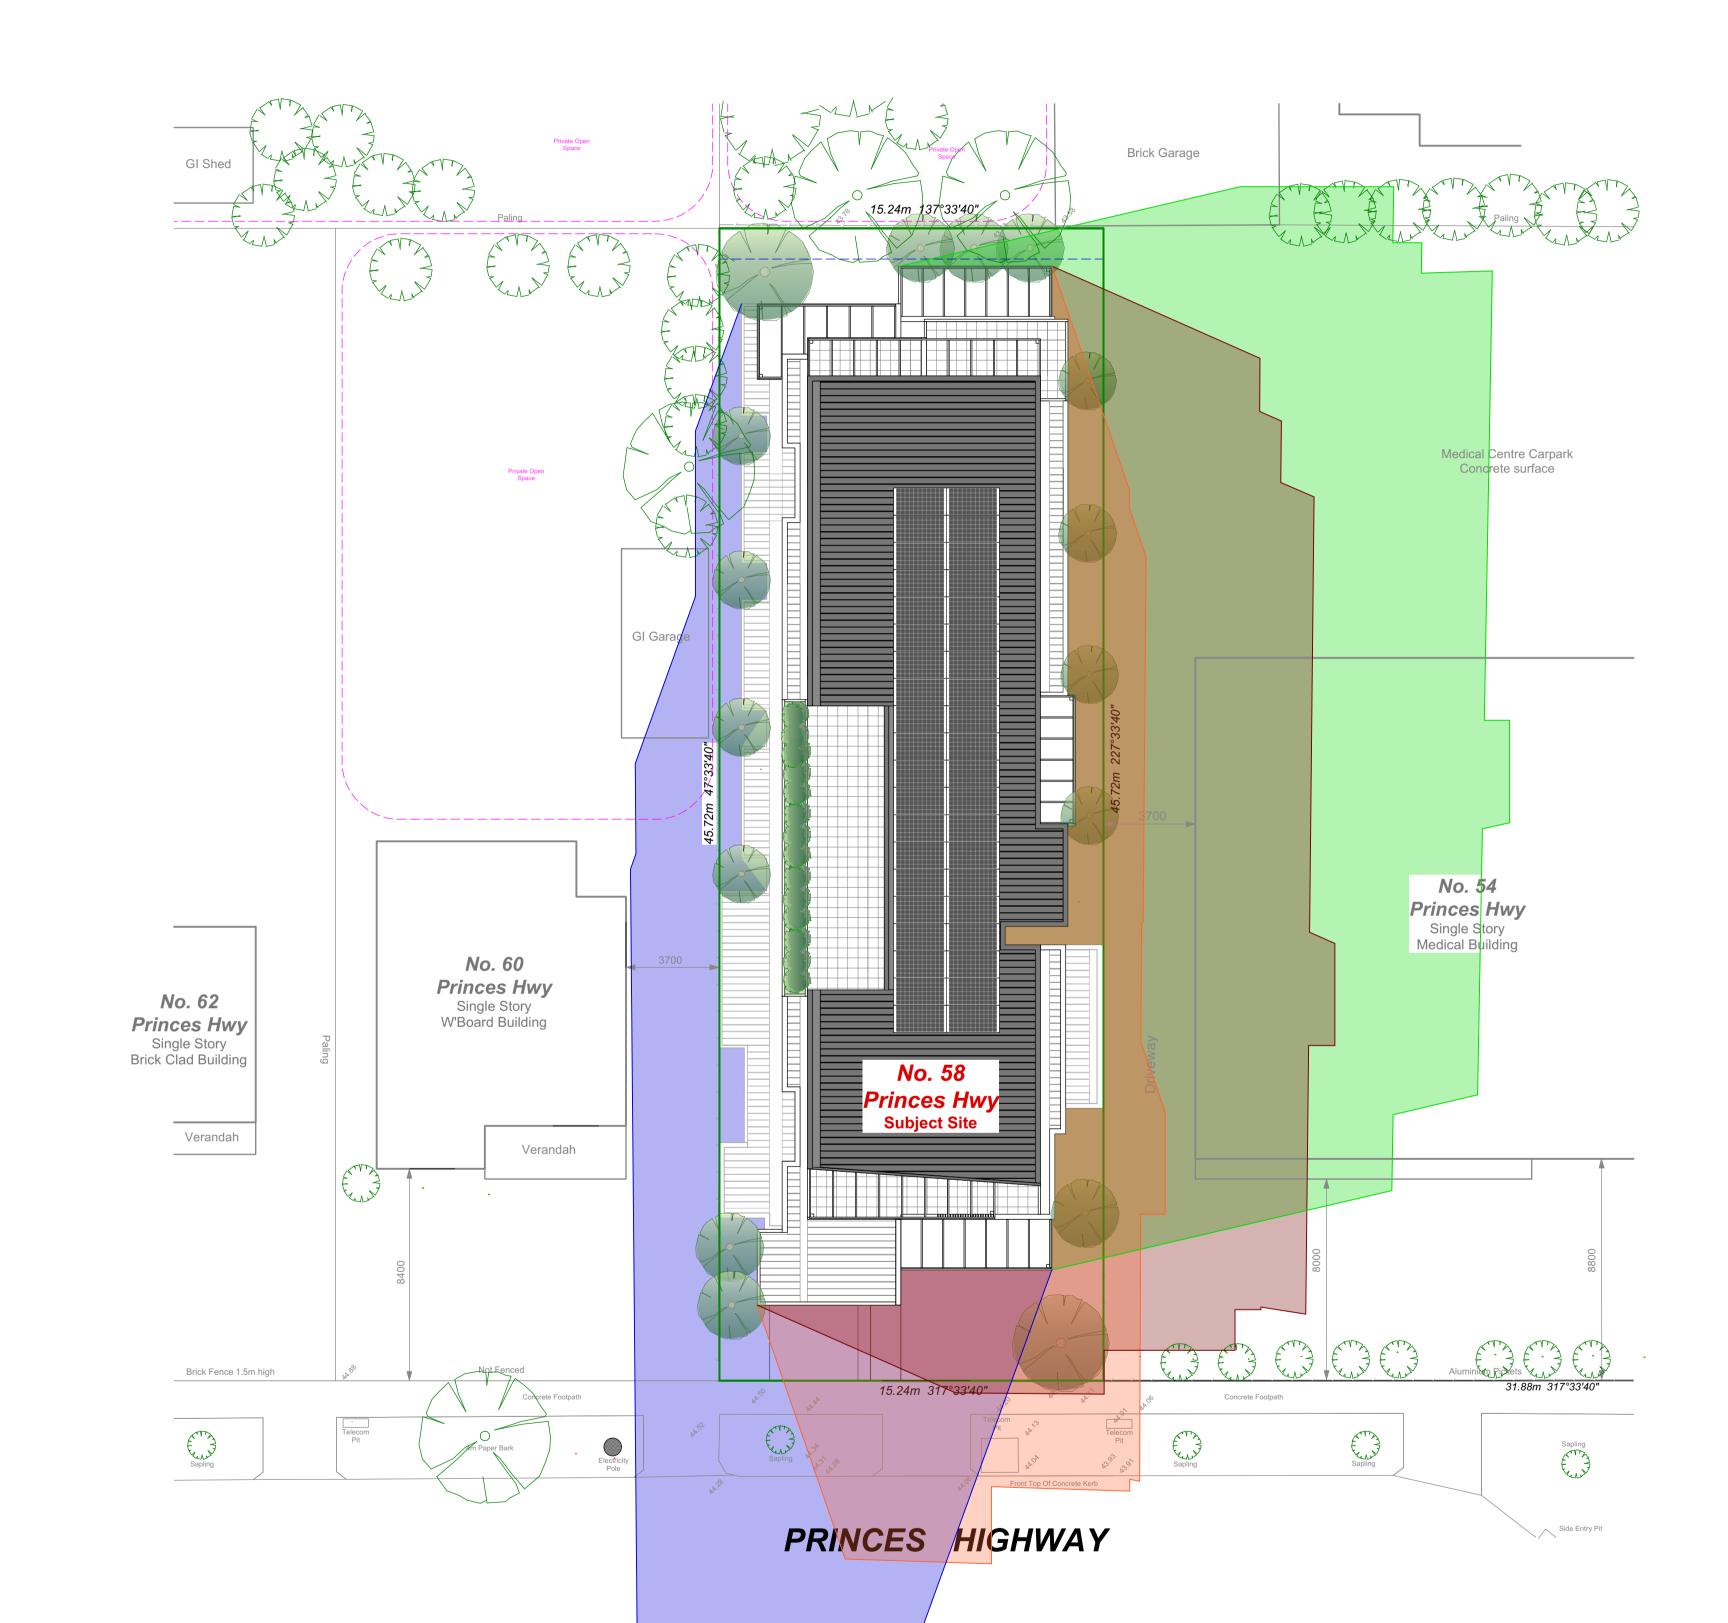

58 Princes Hwy, Dandenong

Proposed 4 Storey 14 Apartment Building & Ground Level Carparking



SHADOW DIAGRAM 9am Shadow Diagram for Sept 22nd Equinox.

Shaded area denotes extent of overshadowing on; Sept. 22nd. at 9:00 am.

SHADOW DIAGRAM 11am Shadow Diagram for Sept 22nd Equinox.

Shaded area denotes extent of overshadowing on; Sept. 22nd. at 11:00 am.

SHADOW DIAGRAM 1pm Shadow Diagram for Sept 22nd Equinox.

Shaded area denotes extent of overshadowing on; Sept. 22nd. at 1:00 pm.

SHADOW DIAGRAM 3pm Shadow Diagram for Sept 22nd Equinox.

Shaded area denotes extent of overshadowing on; Sept. 22nd. at 3:00 pm.

(Source shadowdraw 2D shadow calculation)

Denotes Photovoltaic Panel

Amendment C : 23/10/23 - Car stacker platform depth 5.5m. Ground Floor eastern

- setback reduced to 1.2m
- Separate Entry to foyer from Carpark - Internal windows to provide view lines along foyer corridor - Additional communal open space to rear of the site
- Bed 1 of Apts 4,9,6,11 & 14 min. 3.4m deep
- Storage calculations for each Apt listed. 1 Bed - 10m3 with 6m3 min. internal
- 2 Bed 14m3 with 9m3 min. internal
- Balcony balustrade to Princes Hwy frontage modified to be open metal vertical slat
- June 22 Shadow Diagrams included - Screening added to Level 3 N/W windows & communal
- open space
- **Amendment B : 23/08/23**
- Re-design building from 5 levels to 4 Apartment reduced from 15 to 14

- Double car stacking design included to Ground Floor level parking

Amendment A : 28/02/23

- Amended Ground Floor layout. Entry foyer widened to South/East boundary. Inclusion of windows to the GF facade to soften the interface. Storage sheds bought toward the front of the Carpark.

- Bin location moved internally. Dedicated pedestrian path along the internal driveway.
- Increased Communal Open Space to the rear - Increased variation to the facade including the use of dark
- timber cladding to front balustrades & colour tone variation to the side elevations - Screening to the Bedroom windows to the North/West altered

from opaque glass to fixed horizontal louvres fixed to the facade - Apts 1,2,5,6,9,10,14,15 modified to ensure Standard D18 Accessibility compliant

- Internal storage claculations nominated
- Cross flow ventilation paths demonstrated on floor plans

Drg No. PA TP5(C)

Project :

Apartment Building

- Proprietor :
- Aaron Zhou
- Job Location :


58 Princes Hwy, Dandenong

Drawn By. :	J.A.G, A.G	Date :	23/10/23
Mel. Ref. :	90 B6	Job No. :	22-000
Sheet No. :	5 OF 7(C)	Scale. :	1:150



REGISTERED BUILDING PRACTITIONER DP-1815 23 Nirvana Avenue, Malvern East. 3145 PHONE & FAX : 9572 0601 MOBILE : 0407 351 543

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58 Princes Hwy, Dandenong

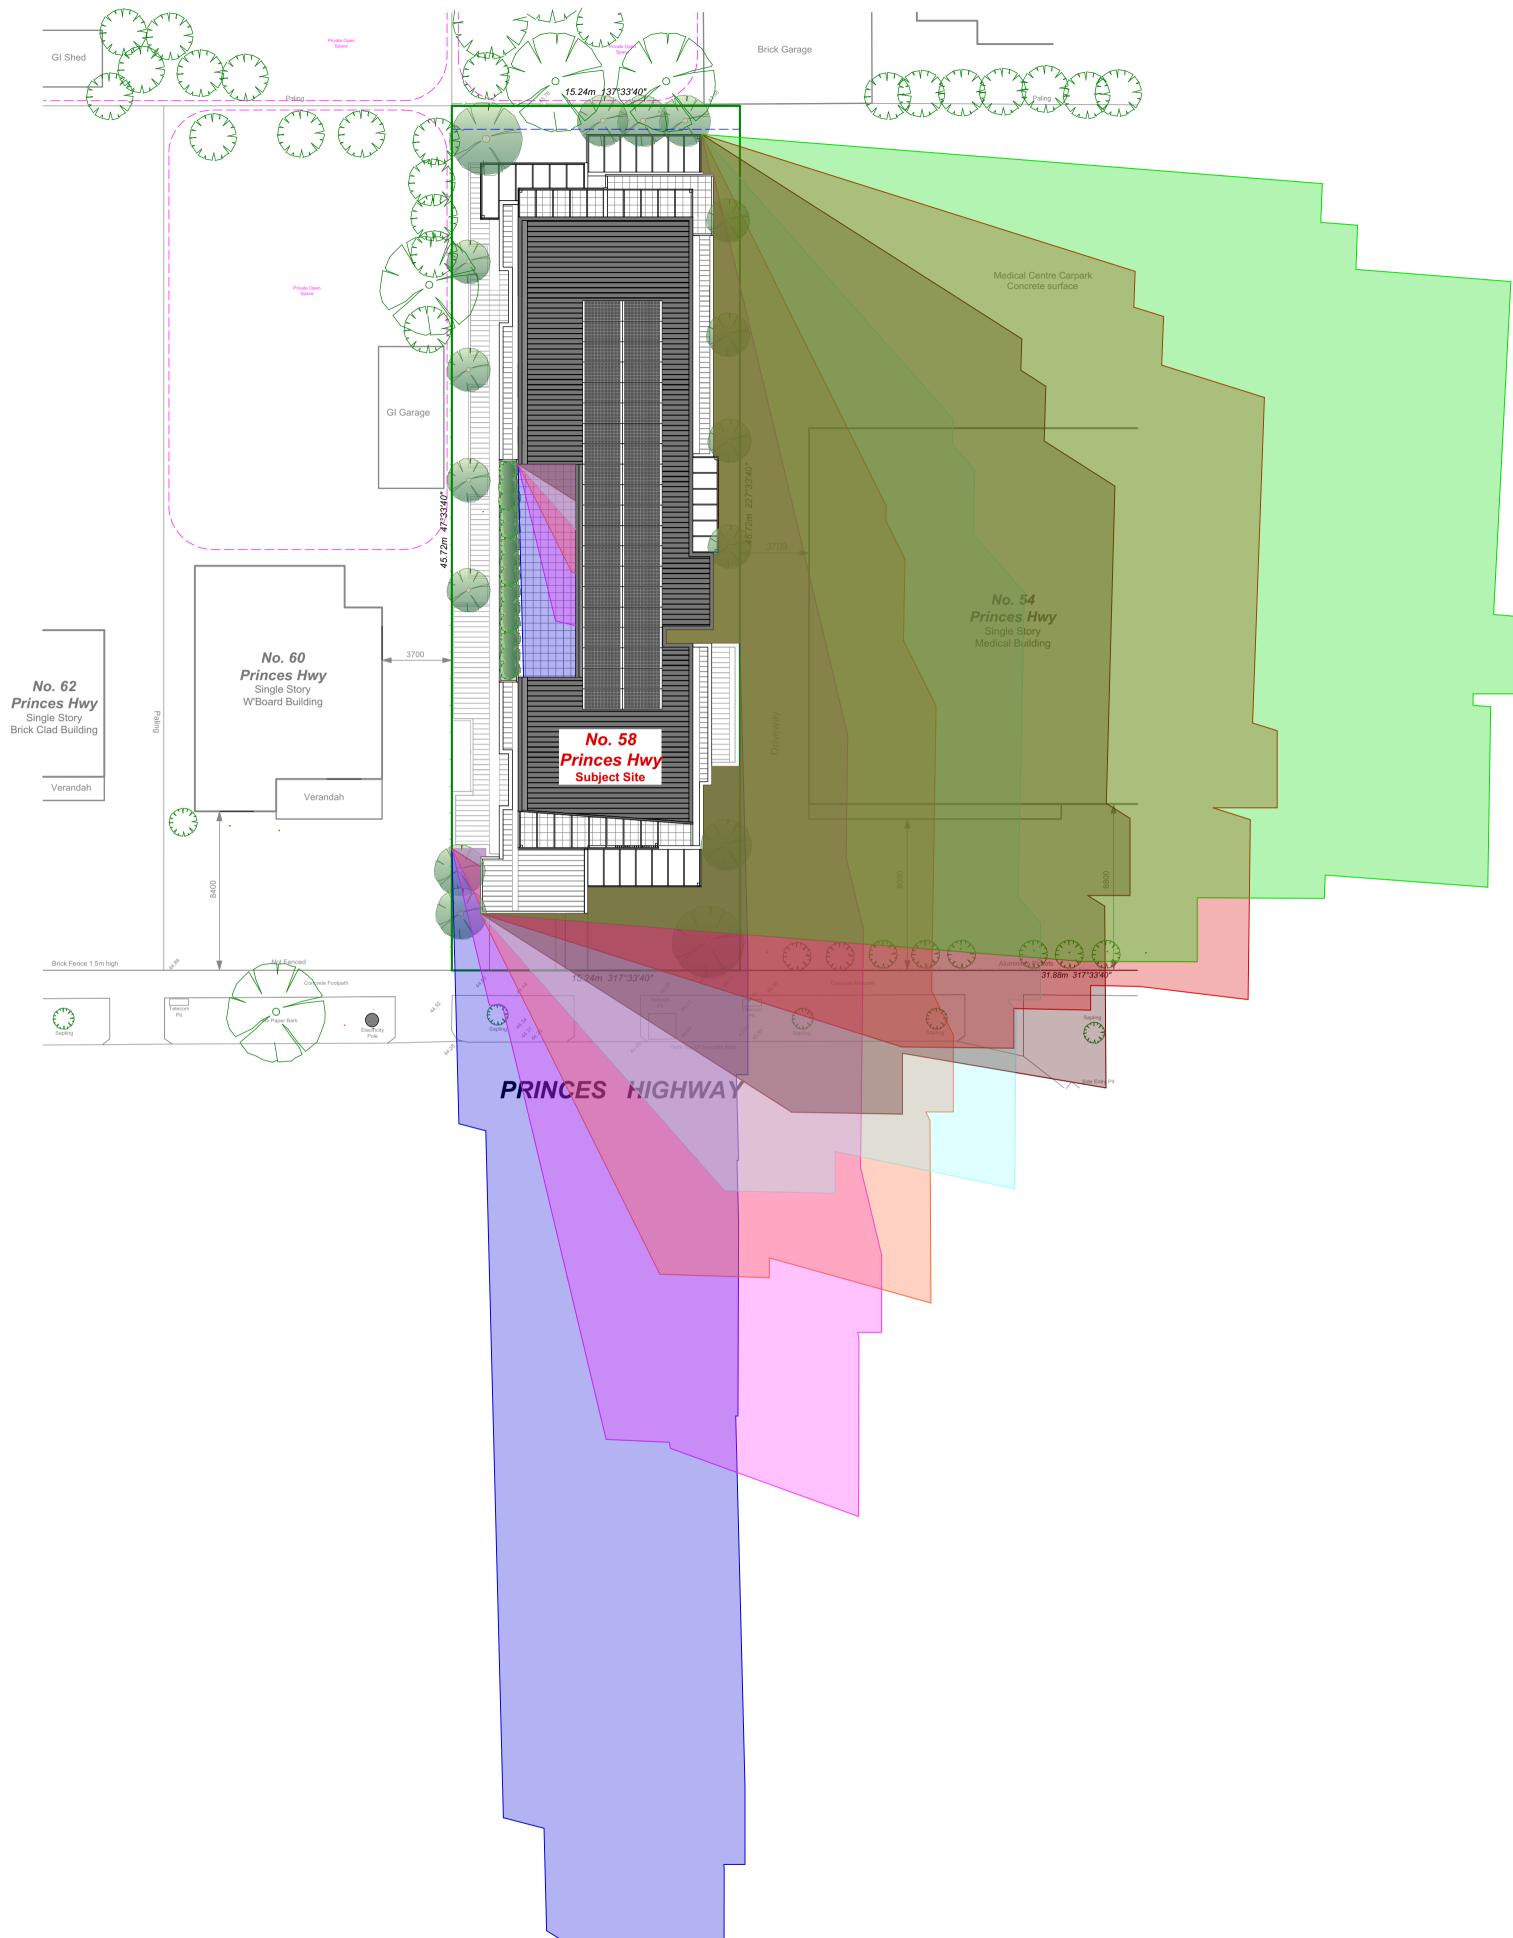Proposed 4 Storey 14 Apartment Building & Ground Level Carparking



SHADOW DIAGRAM 9am Shadow Diagram for June 22nd Equinox.

Shaded area denotes extent of overshadowing on; June. 22nd. at 9:00 am.

SHADOW DIAGRAM 10am Shadow Diagram for June 22nd Equinox. Shaded area denotes extent of overshadowing on; June. 22nd. at 11:00 am.

SHADOW DIAGRAM 11am Shadow Diagram for June 22nd Equinox.

Shaded area denotes extent of overshadowing on; June. 22nd. at 11:00 am.

SHADOW DIAGRAM 12noon Shadow Diagram for June 22nd Equinox.

Shaded area denotes extent of overshadowing on; June. 22nd. at 12:00 noon.

SHADOW DIAGRAM 1pm Shadow Diagram for June 22nd Equinox. Shaded area denotes extent of overshadowing on; June. 22nd. at 1:00 pm.

SHADOW DIAGRAM 2pm Shadow Diagram for June 22nd Equinox. Shaded area denotes extent of overshadowing on; June. 22nd. at 2:00 pm.

SHADOW DIAGRAM 3pm Shadow Diagram for June 22nd Equinox. Shaded area denotes extent of overshadowing on; June. 22nd. at 3:00 pm.

(Source shadowdraw 2D shadow calculation)

Denotes Photovoltaic Panel

Amendment C : 23/10/23 - Car stacker platform depth 5.5m. Ground Floor eastern

- setback reduced to 1.2m
- Separate Entry to foyer from Carpark
- Internal windows to provide view lines along foyer corridor - Additional communal open space to rear of the site
- Bed 1 of Apts 4,9,6,11 & 14 min. 3.4m deep
- Storage calculations for each Apt listed.
- 1 Bed 10m3 with 6m3 min. internal. 2 Bed - 14m3 with 9m3 min. internal
- Balcony balustrade to Princes Hwy frontage modified to be
- open metal vertical slat
- June 22 Shadow Diagrams included - Screening added to Level 3 N/W windows & communal open space
- **Amendment B : 23/08/23**
- Re-design building from 5 levels to 4
- Apartment reduced from 15 to 14 - Double car stacking design included to Ground Floor level parking
- Amendment A : 28/02/23
- Amended Ground Floor layout. Entry foyer widened to South/East boundary.
- Inclusion of windows to the GF facade to soften the interface. Storage sheds bought toward the front of the Carpark.
- Bin location moved internally. Dedicated pedestrian path along the internal driveway.
- Increased Communal Open Space to the rear - Increased variation to the facade including the use of dark timber cladding to front balustrades & colour tone variation to
- the side elevations - Screening to the Bedroom windows to the North/West altered from opaque glass to fixed horizontal louvres fixed to the facade - Apts 1,2,5,6,9,10,14,15 modified to ensure Standard D18 Accessibility compliant
- Internal storage claculations nominated - Cross flow ventilation paths demonstrated on floor plans

Drg No. PA TP6(C)

Project : **Apartment Building**

Proprietor :

Aaron Zhou

Job Location :

58 Princes Hwy, Dandenong

Drawn By. :	J.A.G, A.G	Date :	23/10/23
Mel. Ref. :	90 B6	Job No. :	22-000
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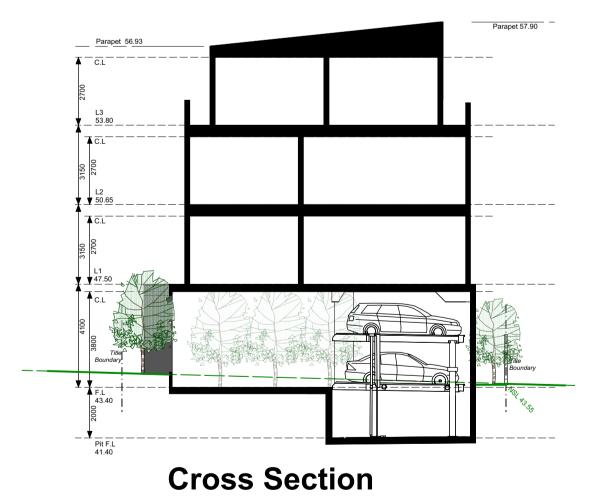
South/West Elevation Princes Hwy Streetscape





South/East Elevation

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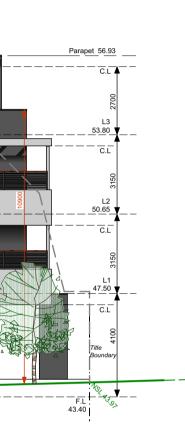


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58 Princes Hwy, Dandenong


Proposed 4 Storey 14 Apartment Building & Ground Level Carparking

Streetscapes & Elevations



Amendment C : 23/10/23

- Car stacker platform depth 5.5m. Ground Floor eastern setback reduced to 1.2m
- Separate Entry to foyer from Carpark
- Internal windows to provide view lines along foyer corridor - Additional communal open space to rear of the site
- Bed 1 of Apts 4,9,6,11 & 14 min. 3.4m deep - Storage calculations for each Apt listed.
- 1 Bed 10m3 with 6m3 min. internal.
- 2 Bed 14m3 with 9m3 min. internal - Balcony balustrade to Princes Hwy frontage modified to be
- open metal vertical slat - June 22 Shadow Diagrams included
- Screening added to Level 3 N/W windows & communal open space

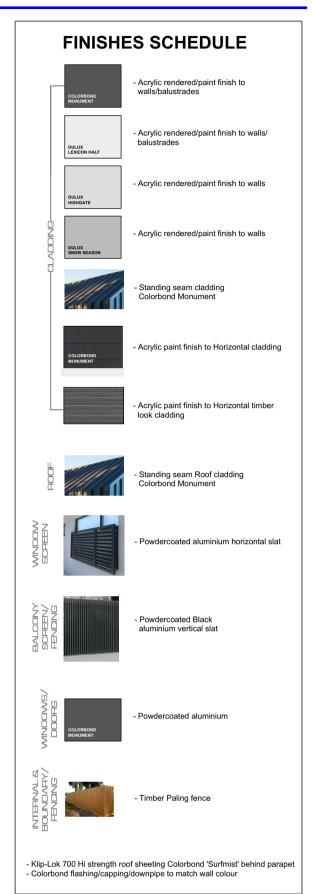

Amendment B : 23/08/23

- Re-design building from 5 levels to 4 Apartment reduced from 15 to 14
- Double car stacking design included to Ground Floor level parking

Amendment A : 28/02/23

- Amended Ground Floor layout. Entry foyer widened to South/East boundary. Inclusion of windows to the GF facade to soften the interface. Storage sheds bought toward the front of the Carpark.
- Bin location moved internally. Dedicated pedestrian path along the internal driveway.
- Increased Communal Open Space to the rear - Increased variation to the facade including the use of dark
- timber cladding to front balustrades & colour tone variation to the side elevations - Screening to the Bedroom windows to the North/West altered
- from opaque glass to fixed horizontal louvres fixed to the facade - Apts 1,2,5,6,9,10,14,15 modified to ensure Standard D18 Accessibility compliant
- Internal storage claculations nominated - Cross flow ventilation paths demonstrated on floor plans

Drg No. PA TP7(C)


Project :


Apartment Building


- Proprietor :
- Aaron Zhou
- Job Location :

58 Princes Hwy, Dandenong

Drawn By. :	J.A.G, A.G	Date :	23/10/23
Mel. Ref. :	90 B6	Job No. :	22-000
Sheet No. :	7 OF 7(C)	Scale. :	1:150

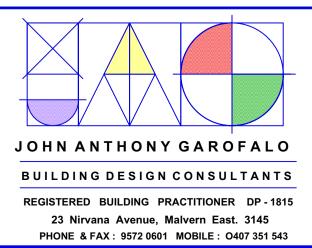

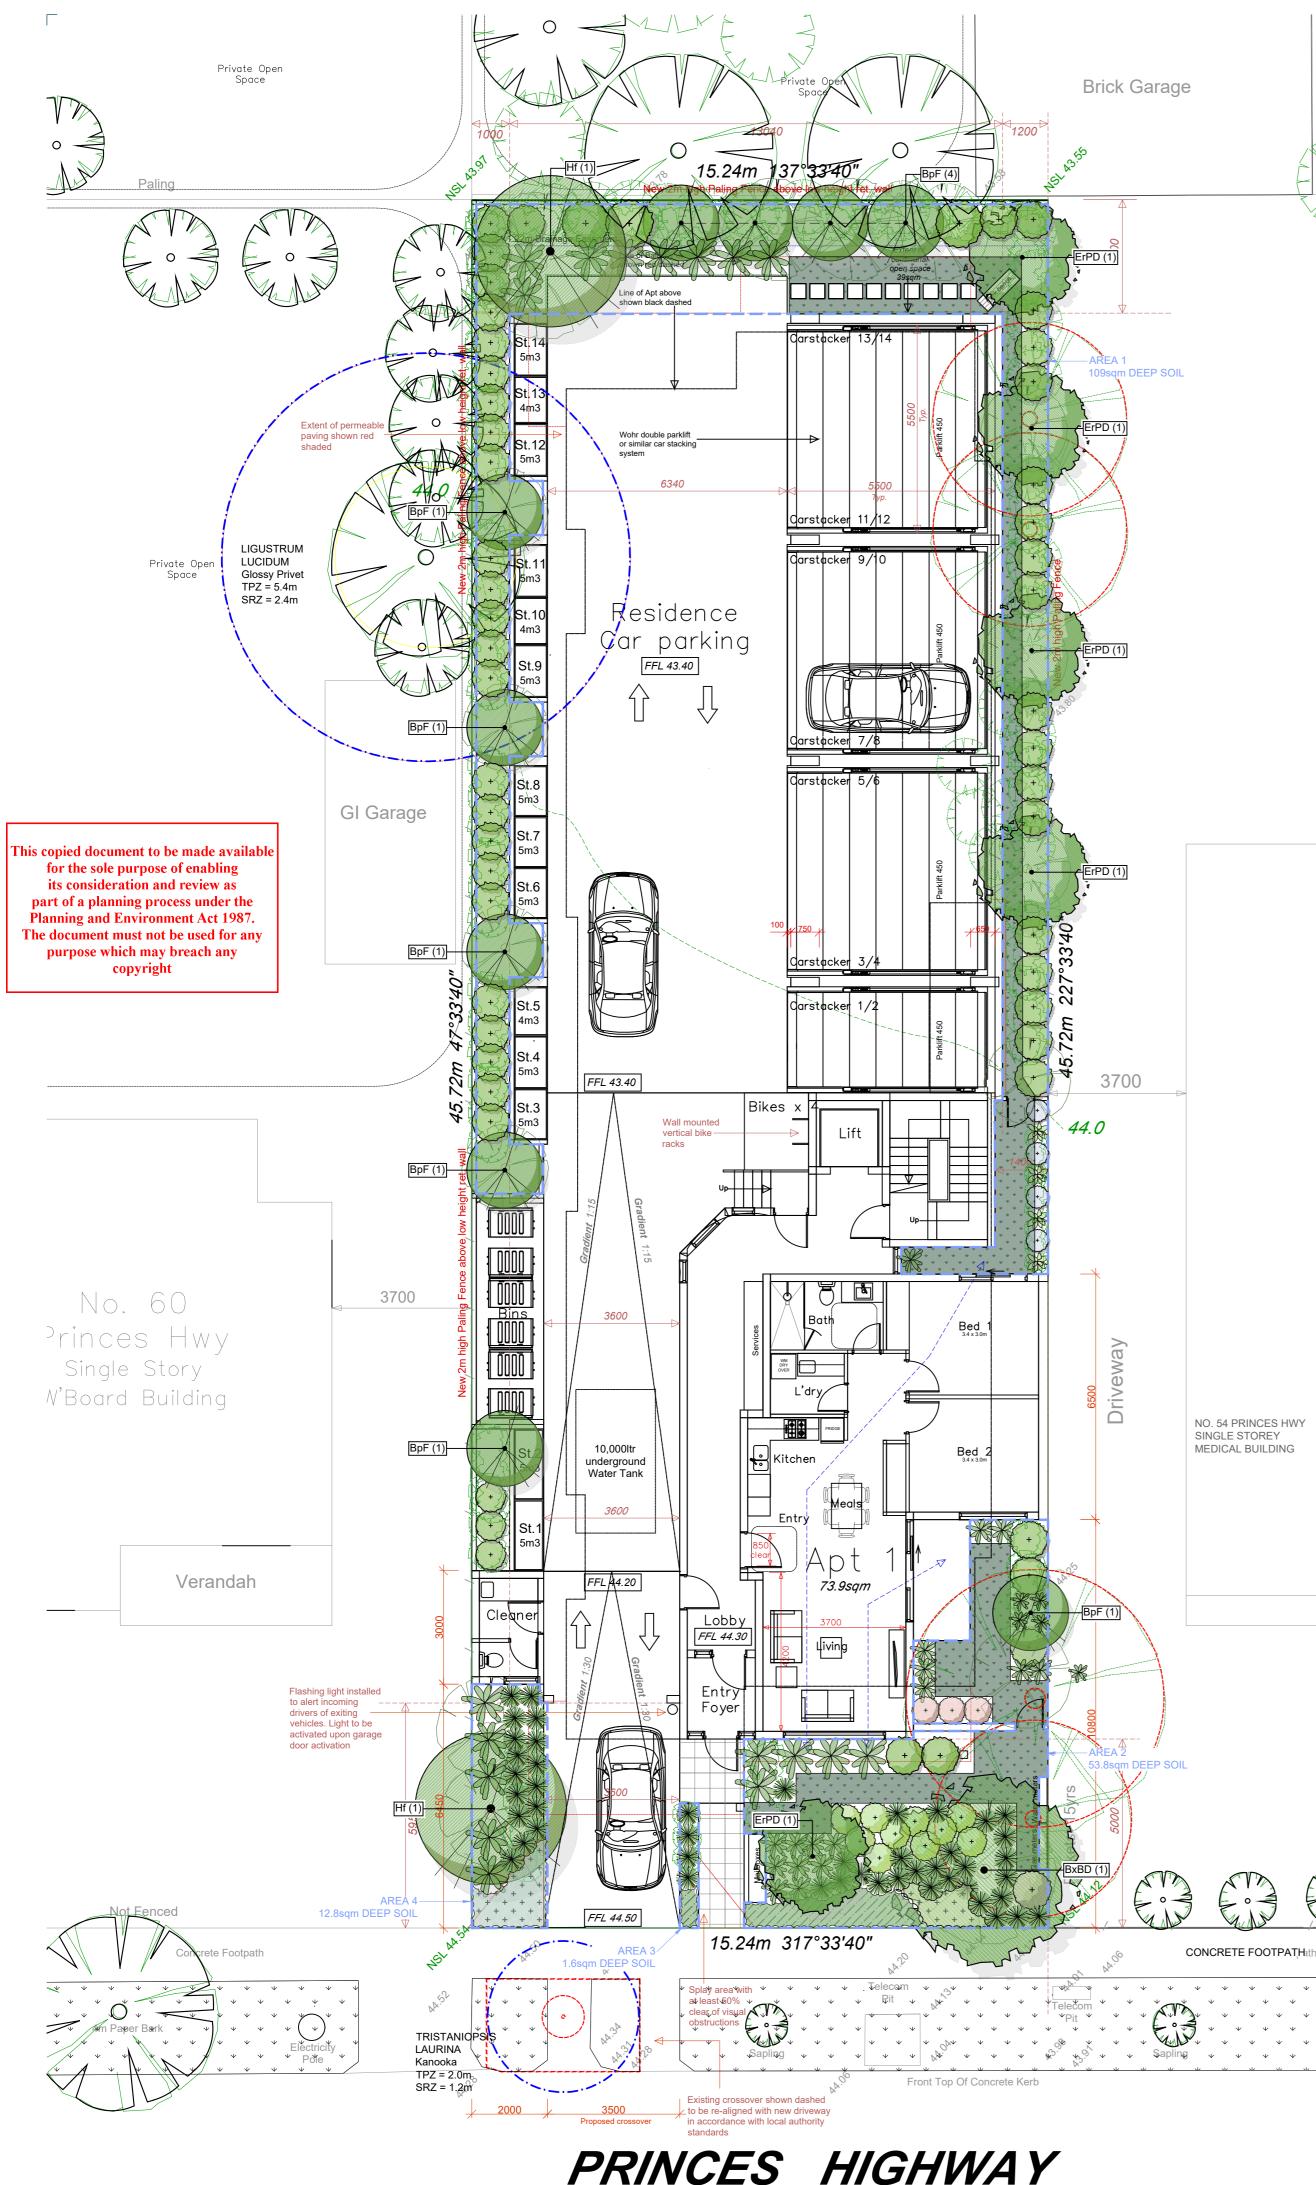

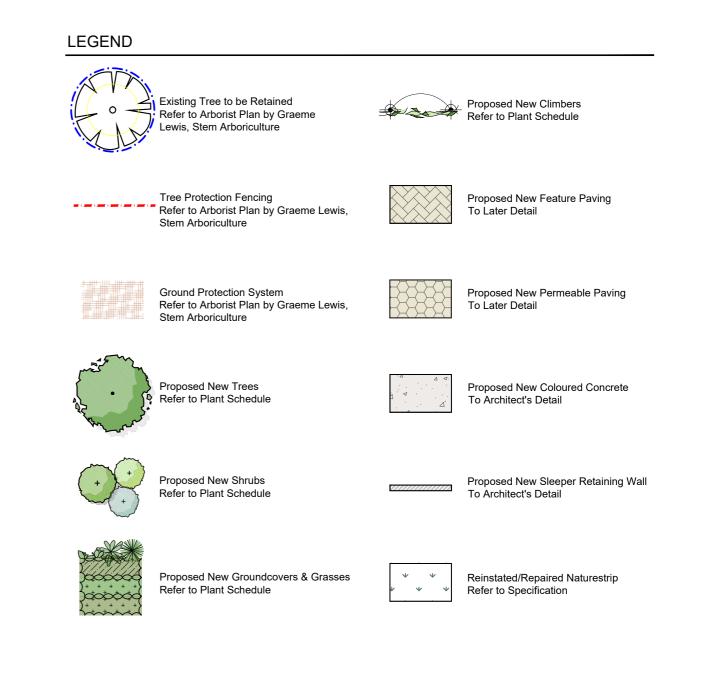

DEEP SOIL AREAS FOR TREE PLANTING

AREA #	DEEP SOIL SQM	TREE SPECIES	SIZE	SMALL / MED / LARGE	QTY
AREA 1	109m2	Elaeocarpus reticulatus 'Prima Donna'	6 x 3m	Small	4
		Betula pendula 'Fastigiata'	7 x 2m	Small	9
		Hymenosporum flavum	8 x 4m	Medium	1
AREA 2	53.8m2	Brachychiton acerifolius x populneus 'Bella Donna'	6 x 4m	Small	1
		Elaeocarpus reticulatus 'Prima Donna'	6 x 3m	Small	1
		Betula pendula 'Fastigiata'	7 x 2m	Small	1
AREA 3	1.6m2				0
AREA 4	12.8m2	Hymenosporum flavum	8 x 4m	Medium	1
TOTAL	177.2m 2				18

PLANT SCHEDULE

SYM	BOTANICAL NAME	COMMONNAME	D/E N/Ex*	HEIGHT X WIDTH AT MATURITY	MIN SUPPLY SIZE	QTY
TREES						
Bx BD	Brachychiton acerifolius x populneus 'Bella Donna	Bella Donna Brachychiton	E/N	6 x 4m	50cm/2.0mH	1
BpF	Betula pendula 'Fastigiata'	Cut-Leaf Birch	D/Ex	7 x 2m	50cm/2.0mH	10
ErPD	Elaeocarpus reticulatus 'Prima Donna'	Pink Flow ering Blueberry As	E/N	6 x 3m	50cm/2.0mH	5
Hf	Hymenosporum flavum	Native Frangipani	E/N	8 x 4m	50cm/2.0mH	2
					TOTAL	18
SHRUBS						
De	Doryanthes excelsa	Gymea Lily	E/N	2.5 x 1.5m	200mm pot	
ROP	Rhaphiolepis indica 'Oriental Pearl'	Oriental Pearl Indian Haw tho	E/Ex	1 x 1m	200mm pot	
NdMB	Nandina domestica 'Moon Bay'	Moon Bay Sacred Bamboo	E/Ex	0.75 x 0.75m	200mm pot	
SaBC	Syzygium australe 'Bush Christmas'	Bush Christmas Lilly-pilly	E/N	2 x 1m clipped	200mm pot	
					TOTAL	
GROUNDC	OVERS					
AcMB	Arthropodium cirratum 'Matapouri Bay'	Renga Lily	E/Ex	0.6 x 0.6m	140mm pot	1
Bn	Blechnum nudum	Fishbone Water-fern	E/N	0.6 x 0.6m	140mm pot	To Later Detail
Cm	Clivia miniata	Clivia	E/Ex	0.6 x 0.6m	140mm pot	ter
LmA	Liriope muscari 'Amethyst'	Amethyst Lily-turf	E/Ex	0.4 x 0.4m	140mm pot	La
LIT	Lomandra longifolia 'Tanika'	Tanika Mat-rush	E/N	0.6 x 0.6m	140mm pot	Ĕ
Rh	Ruscus hypoglossum	Butcher's Broom	E/Ex	0.5 x 0.6m	140mm pot	
TaFM	Trachelospermum asiaticum 'Flat Mat'	Yellow Star Jasmine	E/Ex	0.4 x 3m	140mm pot	
					TOTAL	
CLIM BERS						
Fp	Ficus pumila	Climbing Fig	E/Ex	Self-clinging Climber	140mm pot	
Tj	Trachelospermum jasminoides	Star Jasmine	E/Ex	Tw ining Climber	140mm pot	
					TOTAL	
	*D/E = Deciduous/Evergree	en	N/Ex = Nati	ve/Exotic		

SPECIFICATION NOTES

Soil Preparation

Crushed rock, concrete spillage and any other material restrictive to plant growth (e.g. large rocks) shall be removed from the site of any planting beds and semi-advanced trees. All trees to be removed shall be stump ground and all rubbish/vegetative spoil is to be removed from site. Existing top soil in planting areas is to be preserved so that it does not receive additional compaction from site machinery and so that no rubble or building supplies are stored in these areas.

No imported top soil is to be used within the root zones of trees to be protected. Any preparation of existing soil for planting within these areas is to be done by <u>hand only</u>. Holes (e.g. as the result of plant removal) and uneven soil levels may be patched using topsoil as specified below.

Any imported topsoil is to be free of weeds, rubble and other materials damaging to plant growth and is to be of a medium texture (sandy loam) with a pH of 6.0-7.0. Top soil is to be laid over a prepared sub-base which has had any materials damaging to plant growth (e.g. rubble and large rocks) removed, spread to the appropriate depth and cultivated into the existing site soil to a minimum depth of 150mm.

Imported top soil is to be lightly and uniformly compacted in 150mm layers to a minimum depth of 100mm on lawn areas and 300mm on excavated planting beds.

Weed Removal

All weeds shall be thoroughly removed. All vegetative material, including roots and rhizomes of non-woody perennials and woody suckering weeds, is to be removed or appropriately controlled using chemical means. The stumps of non-suckering woody perennials are to be stump ground. All vegetative material shall be appropriately disposed of off site in a manner which will not allow their re-establishment elsewhere. Any chemical controls are to be used in accordance with manufacturer's instructions and standard occupational health and safety procedures.

Care must be taken to ensure that all trees to be retained are not damaged during weed removal. This also implies that any herbicides used are suitable for use around the vegetation to be retained.

Planting

ADVERTISED

PLAN

Planting shall be carried out using accepted horticultural practices with all plants conforming to the species, size and quantities indicated on the Landscape Plan and Plant Schedule. Plants shall be thoroughly soaked through immersion in water prior to planting and if the planting soil is very dry then the planting hole is also to be filled with water and allowed to drain completely.

All plants shall be appropriately hardened off in the nursery. Use plants with the following characteristics: Large healthy root systems with no evidence of root curl or pot bound restriction or damage, vigorous, well established, free from disease and pests and of good form, consistent with the species or variety.


Planting holes for shrubs and groundcovers are to be of minimum size 75mm larger than the planting pot in all directions. Semi-advanced tree planting holes are to be the same depth as the rootball and 2-3 times its diameter, with the top of the rootball being at grade. A 75mm high berm is to be constructed at edge of root-ball to hold water. All plants are to be thoroughly watered after planting and slow release fertiliser added at the quantities specified by the manufacturer

Wire Vine Support

The landscape contractor shall supply and install stainless steel wire cable support for Botanical Name & Botanical Name on the boundary fences as indicated on the Landscape Plan.



Scale N.T.S.

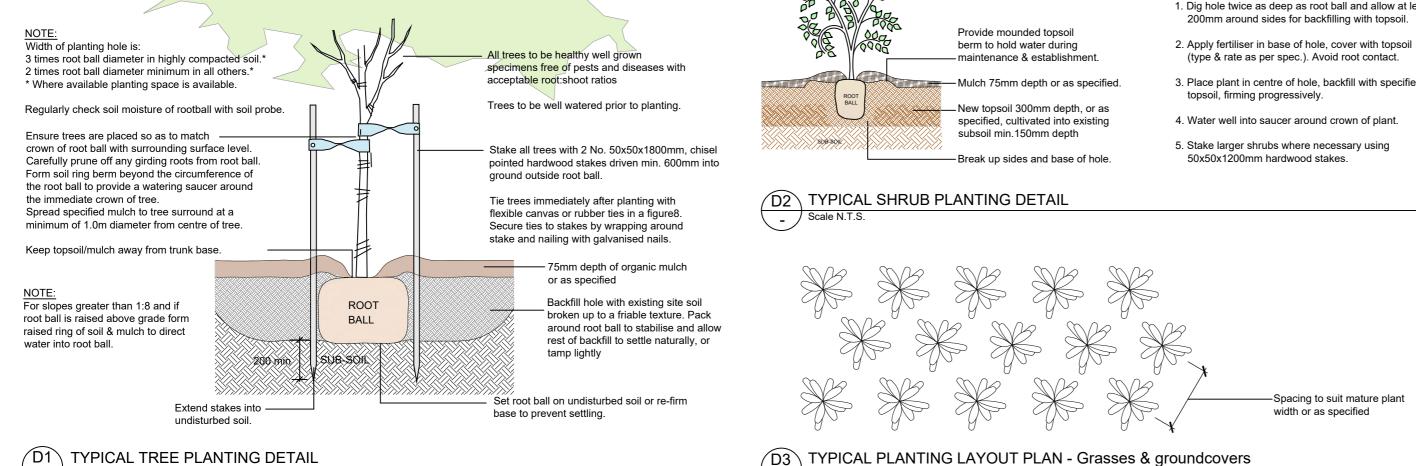

Scale 1:50

200mm around sides for backfilling with topsoil.

2. Apply fertiliser in base of hole, cover with topsoil (type & rate as per spec.). Avoid root contact.

NOTE:

- 3. Place plant in centre of hole, backfill with specified
- 4. Water well into saucer around crown of plant.
- 5. Stake larger shrubs where necessary using 50x50x1200mm hardwood stakes.

Run the cable horizontally along the length of the paling fence for the required length as indicated on the Landscape Plan. Space the cable evenly at 400mm centres - attach with galvanised or s/s eyelits - tension cable with stainless steel turnbuckles to achieve the required tension.

Mulch

Mulch is to be supplied to all garden beds and is to be an organic type laid to a minimum depth of 75mm, consisting of fine dark coloured chipped or shredded pine bark or hardwood with not more than 5% fines content by volume (preferably zero fines). The average size of the woodchip must be approximately 10mm x 20mm x 5mm and the maximum length is not to exceed 30mm. Mulch shall be free of damaging matter such as soil, weeds and sticks and is to be stockpiled and thoroughly weathered prior to delivery. Mulch is to be kept back 100mm from the stems of all plants to prevent collar rot.

Irrigation

An approved drip irrigation system is to be supplied to all planter boxes & garden beds. An approved pop-up spray system is to be supplied to all lawn areas. It is the responsibility of the contractor to ensure that all irrigation meets manufacturers specifications. The system is to be connected to mains supply and include a rain-shut off device. All dripline is to be buried with approx. 50mm of topsoil cover and shall be anchored at regular intervals to ensure the tubing cannot be dislodged.

Repair/Restoration of damaged Nature-strips


Nature strips are to be restored to current grades with any depressions filled with topsoil to specifications above and lightly compacted in 150mm layers. Areas are then to be re-seeded using an appropriate and matching turf type and the area fenced off to allow the re-establishment of lawn. Re-seeded areas are to be well irrigated and the area supplied with a slow release fertiliser at the quantities recommended by the manufacturer.

Any areas of lawn which have failed to germinate (achieve an evenly green 95% covering of a consistent height) are to be re-seeded within one month of original sowing date.

Plant Establishment Period

There shall be a 13 weeks Plant Establishment Period following the approval of Practical Completion by the responsible authority. During this period the landscape contractor shall make good all defects in his/her scope of works. Maintenance and Establishment means the care and maintenance of the contract area by accepted horticultural practices, as well as rectifying any defects that become apparent in the work under normal use. This shall include, but shall not be limited to watering, fertilising, weeding, pruning, pest and disease control, cultivation, re-staking and replacement of any plants that fail with plants of the same species and size.

		REVISION	DATE BY	CLIENT	DRAWING	SCALE	1:100
JOHN JOHN PATRICK	C	A To Council Request	01.03.2023 DG	Aaron Zhou	Landscape Plan (Ground Floor)	DATE	NOV
LANDSCAPE ARCHITECTS PTY LTD		B To Revised Architect's Plan	27.07.2023 BM		for Town Planning	DRAWN	DG
324 Victoria Street, Richmond, VIC, 3121		C To Revised Architect's Plan	25.08.2023 BM	PROJECT		CHECKED	KD
R	without the consent of John Patrick Landscape	D To Revised Architect's Plan	18.10.2023 BM	Residential Development	\land	JOB NO	22-64
T +61 3 942 94855 F +61 3 9429 8211	Architects Pty Ltd Do not scale off drawings					DWG NO	TP01
www.johnpatrick.com.au	NOT FOR CONSTRUCTION			58 Princes Highway, Dandenong		CAD FILE	

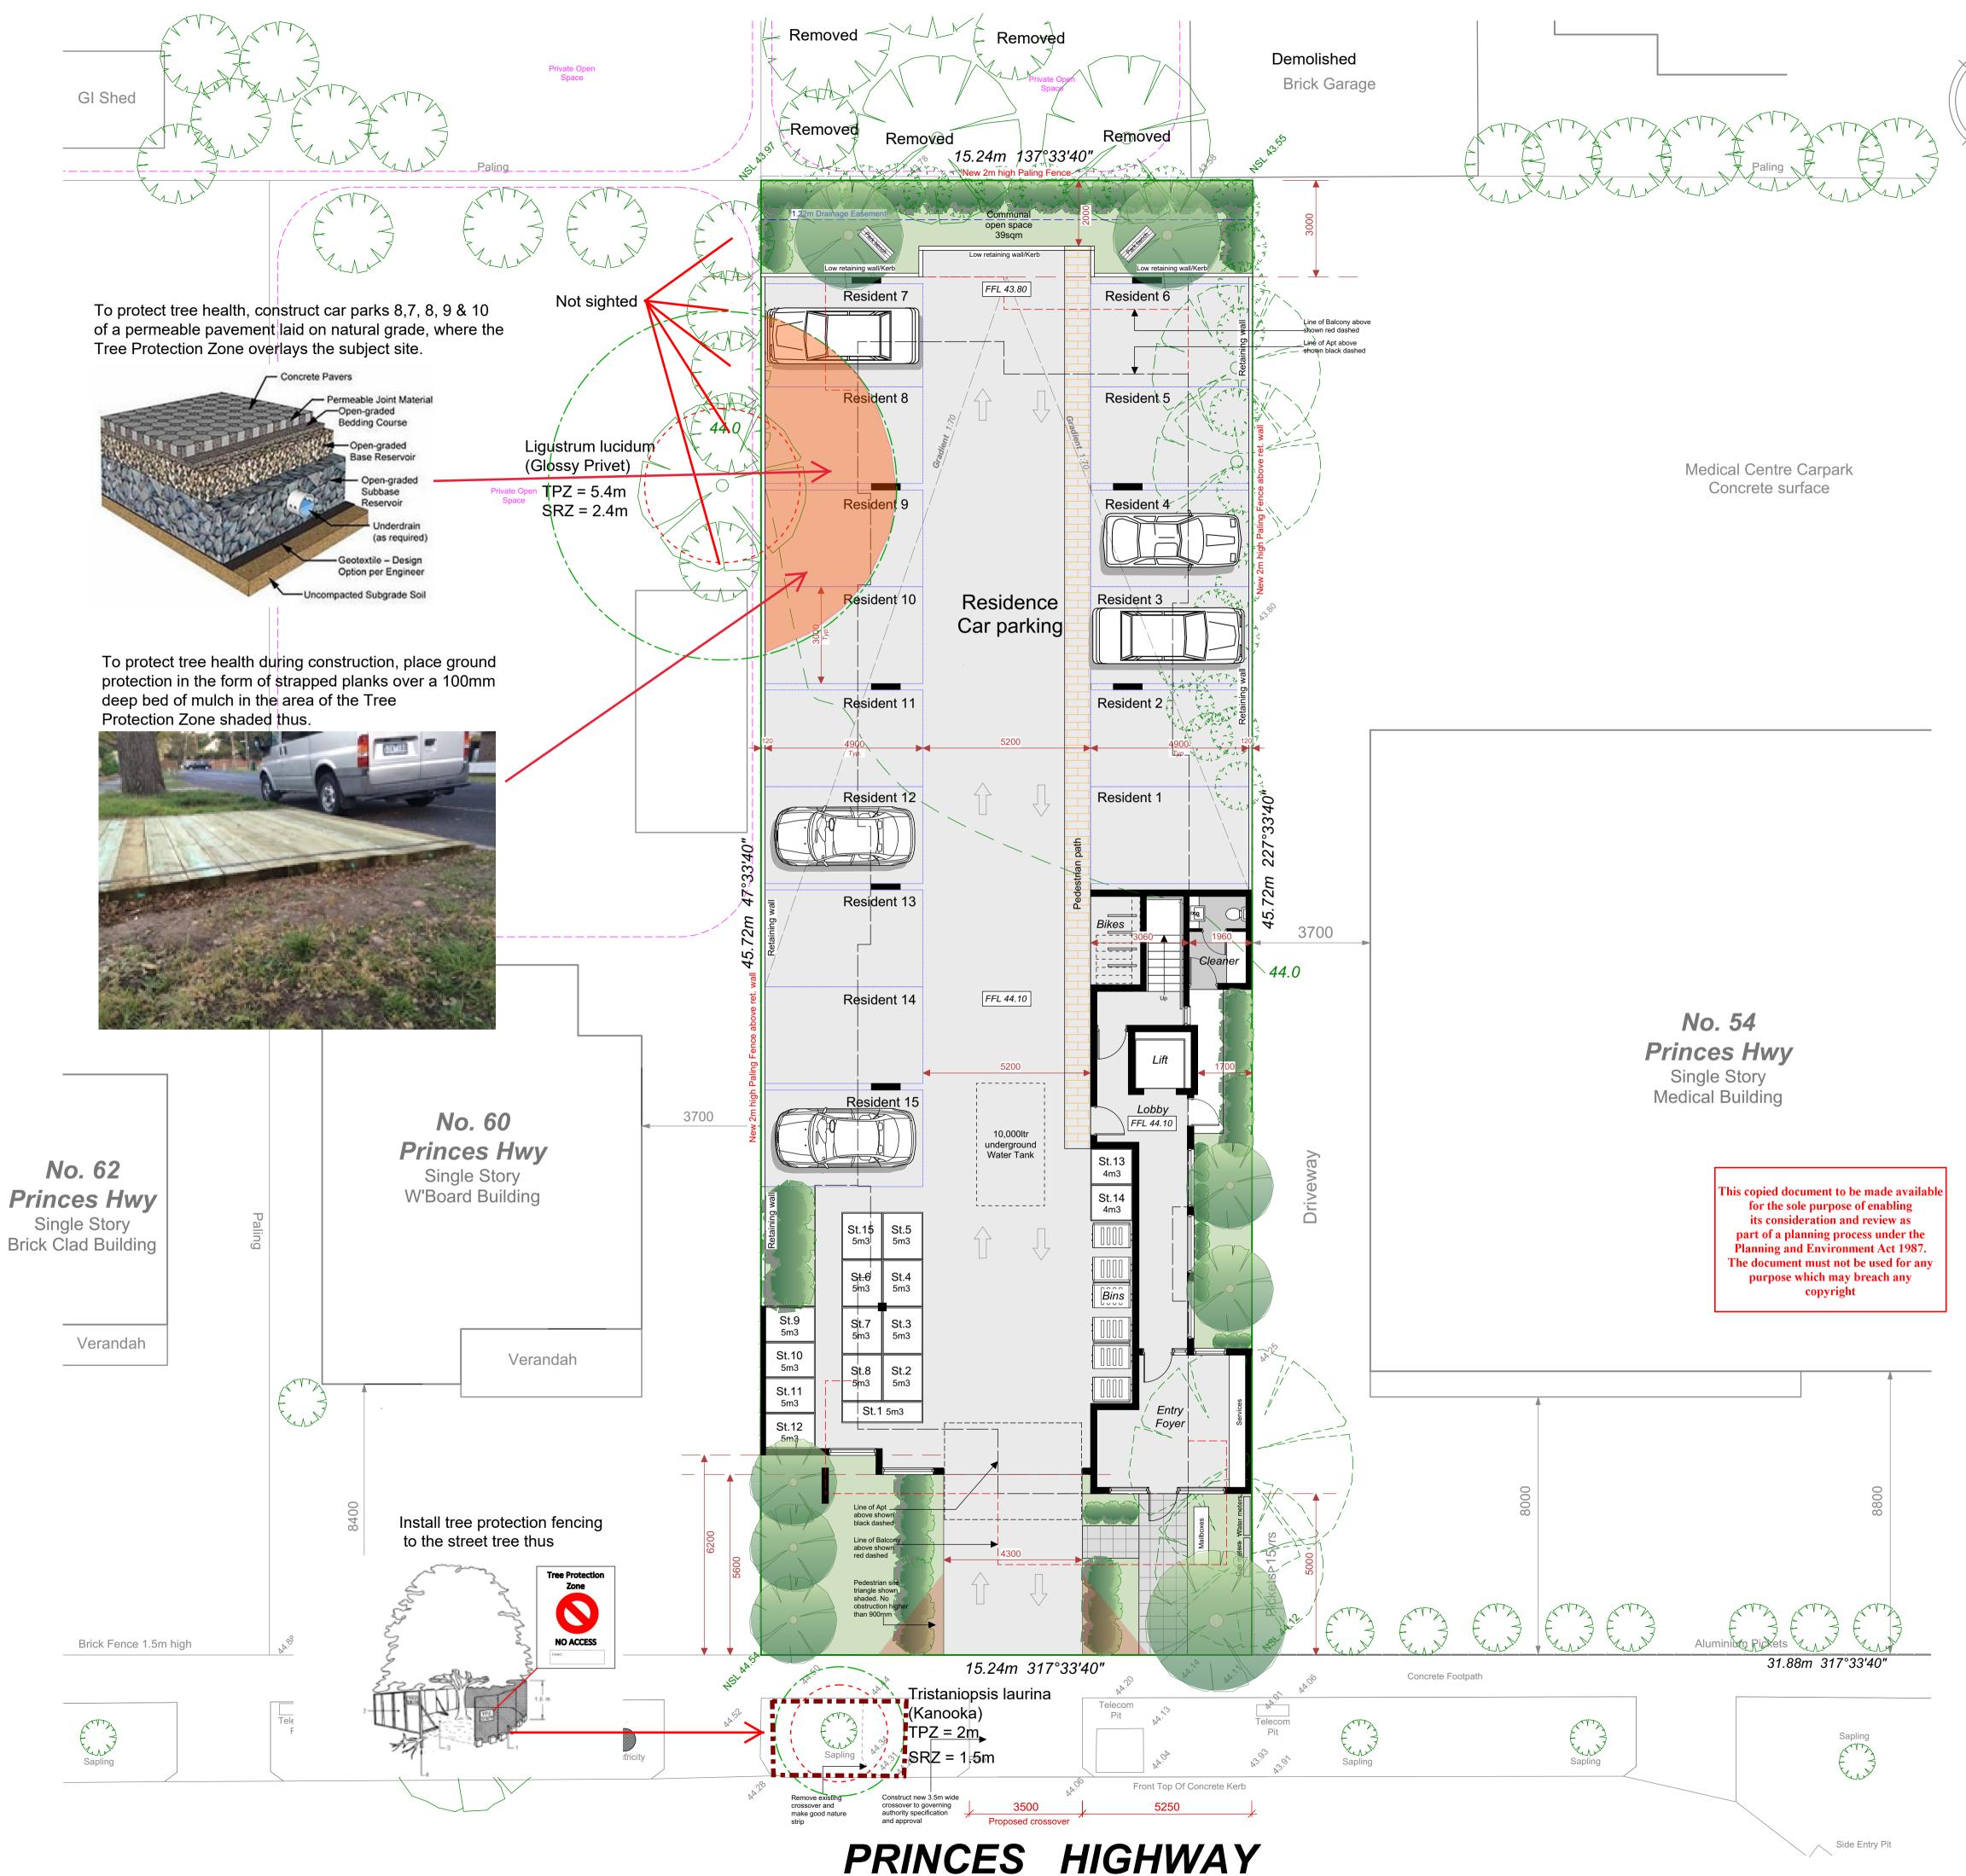

- Screening to the Bedroom windows to the North/West altered from opaque glass to fixed horizontal louvres fixed to the facade - Apts 1,2,5,6,9,10,14,15 modified to ensure Standard D18 Accessibility compliant - Internal storage claculations nominated - Cross flow ventilation paths demonstrated on floor plans



58 Princes Hwy, Dandenong

Proposed 5 Storey 15 Apartment Building & Ground Level Carparking




SITE STATISTICS

Site Area - 696.8sqm Building Area - 438.2sqm (Ground Floor) Site Coverage % - 62.9% Building & Hard Surface Area 583.8sgm (Incls. Driveway & paths) Site Coverage % - 83.8%

> No. of Units - 15 x Apartments 13 x 2 Bed 2 x 1 Bed Density - 1:46sqm

No. of Carspaces - 15 Total 1 per Apt. No Visitors spaces

LEGEND

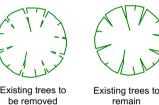



remair Proposed landscape layout shown indicative only. Refer Landscape Designers drawings

KEY ESD INITIATIVES

- Utility Meters for each Apartment - Common areas to be sub-metered
- All external area lighting to be controlled
- through motion/daylight sensor
- 10,000ltr rainwater tank for toilet flushing & irrigation - Water efficient fittings
- Toilets min. 4 star WELS rated Taps min. 5 star WELS rated
- Shrs min. 4 star WELS rated (max. 7.5ltr/min)
- Water efficient appliances (3 star D/washer)
- 7.3 star average energy rating
- 15kW Solar PV system
- Heat pump hot water system - High efficiency air conditioning systems
- (Heating 4 star. Cooling 4 star)
- Efficient lighting (LED) 4w/sqm to all habitable areas - High performance glazing to all windows (Double glazing)
- Natural ventilation to dwellings
- (Refer to cross flow diagrams) - Excellent daylight to habitable spaces
- Low VOC paints to improve indoor environment quality
- for residents
- Sustainable timber - Water efficient landscaping
- 5 Electric car charging point within carpark (32amp Min.)
- 4 Bicycle spaces

Drg No. PA TP2(A) Project :


Apartment Building

Proprietor : Aaron Zhou

Job Location :

58 Princes Hwy, Dandenong

Drawn By. :	J.A.G, A.G	Date :	28/02/23
Mel. Ref. :	90 B6	Job No. :	22-000
Sheet No. :	2 OF 6(A)	Scale. :	1:100

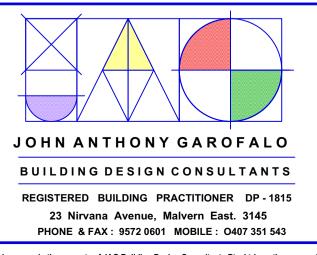

ADVERTISED PLAN

Amendment A : 28/02/23

- Amended Ground Floor layout. Entry foyer widened to South/East boundary.

Inclusion of windows to the GF facade to soften the interface. Storage sheds bought toward the front of the Carpark. Bin location moved internally.

Dedicated pedestrian path along the internal driveway. Increased Communal Open Space to the rear - Increased variation to the facade including the use of dark

timber cladding to front balustrades & colour tone variation to the side elevations

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