VICTORIA STREET DEVELOPMENT OR INFORMATION LANDSCAPE DRAWINGS FOR ENDORSEMENT AUGUST 2024

PREPARED BY:

MALA STUDIO

1/11 AMSTERDAM STREET RICHMOND VICTORIA 3047

FOR:

Assemble Victoria Street Development

342-348 VICTORIA STREET BRUNSWICK, VICTORIA 3056

ADVERTISED PLAN

LANDSCAPE DRAWINGS

No.	Title	Sheet	Scale
L000	TITLE SHEET	TITLE	N/A
L001	GENERAL NOTES & SCHEDULES	INFORMATION	N/A
L002	SITE PLAN - GROUND FLOOR	PLAN	1:200 @ <i>F</i>
L003	SITE PLAN - LEVEL 1	PLAN	1:200 @ <i>F</i>
L004	SITE PLAN - ROOF PLAN	PLAN	1:200 @ <i>A</i>
L101	SETOUT - SHEET 1/4	PLAN	1:100 @ /
L102	SETOUT - SHEET 2/4	PLAN	1:100 @ /
L103	SETOUT - SHEET 3/4	PLAN	1:100 @ /
L104	SETOUT - SHEET 4/4	PLAN	1:100 @ /
L201	GRADING - SHEET 1/4	PLAN	1:100 @ /
L202	GRADING - SHEET 2/4	PLAN	1:100 @ /
L203	GRADING - SHEET 3/4	PLAN	1:100 @ /
L204	GRADING - SHEET 4/4	PLAN	1:100 @ /
L301	SURFACES - SHEET1/4	PLAN	1:100 @ /
L302	SURFACES - SHEET2/4	PLAN	1:100 @ /
L303	SURFACES - SHEET3/4	PLAN	1:100 @ /
L304	SURFACES - SHEET4/4	PLAN	1:100 @ /
L400	PLANTING SCHEDULES	SCHEDULE	N/A
L401	PLANTING - SHEET 1/4	PLAN	1:100 @ /
L402	PLANTING - SHEET 2/4	PLAN	1:100 @ /
L403	PLANTING - SHEET 3/4	PLAN	1:100 @ /
L404	PLANTING - SHEET 4/4	PLAN	1:100 @ /
L405	PLANTING - LEVEL 1	PLAN	1:200 @ /
L406	PLANTING - ROOF SPACES	PLAN	1:200 @ /

LANDSCAPE DETAILS, SCHEDULES & DOCUMENTS

No.	Title	Sheet	Scale
L501	SECTIONS - CENTRAL COMMONS	SECTION	AS SHOWN
L502	SECTIONS - SOUTHERN LANEWAY	SECTION	AS SHOWN
L503	SECTIONS - NORTHERN LANEWAY	SECTION	AS SHOWN
L601	DETAILS - HARD DETAILS	DETAIL	AS SHOWN
L602	DETAILS - SOFT DETAILS	DETAIL	AS SHOWN
L603	DETAILS - DECK SEAT	DETAIL	AS SHOWN
L604	DETAILS - PLANTING	DETAIL	AS SHOWN
L605	DETAILS - BRICK SEATS	DETAIL	AS SHOWN
L606	DETAILS - ARBORS	DETAIL	AS SHOWN
L607	DETAILS - ARBOR	DETAIL	AS SHOWN
L700	MATERIAL SCHEDULE	SCHEDULE	N/A

ATTACHMENTS

Sheets	Title	Issue	Scale
1 - 4	IRRIGATION DRAWINGS	P1	AS SHOWN

			1				
	NOTES	REV NO DATE DESCRIPTION	PROJECT INFORMATION	SHEET TITLE			
		E1 05.08.24 FOR ENDORSEMENT	VICTORIA STREET DEVELOPMENT	TITLE SHEE	ĒΤ		
			342-348 VICTORIA STREET				
\mathbf{m}			BRUNSWICK, VIC 3029				
				DRAWN BY PLC	OT DATE	SCALE @ A1	NORTH
				AY 05.0	08.2024	N/A	
			ISSUE	APPROVED PRO	OJECT NO	SHEET NO.	REV NO
			FOR ENDORSEMENT	BB 230	2	L000	E1

TECHNICAL NOTES

Plan General Notes

- These drawing shall be read in conjunction with documentation provided by other consultants.
- These drawing shall be read in conjunction with the Landscape Specification (L800)
- Plan drawings containing general set out information can be obtained in Autocad format upon request from the contractor.
- The contractor and subcontractors shall verify all dimensions, lines, levels, and existing service locations prior to commencement on site, preparation of detail/ shop drawings and fabrication of construction/building components.
- Digital Setout to be provided for accurate setout of all landscape items on request.

Detail General Notes

- The contractor and subcontractors shall verify all dimensions, lines, levels, and existing service locations prior to commencement on site, preparation of detail/ shop drawings and fabrication of construction/ building components.
- The contractor must verify all dimensions prior to fabrication and installation. If any anomalies arise the contractor is to advise the superintendent immediately.
- All dimensions are in mm. Do not scale off drawings.
- Contractor is to provide shop drawings (CAD drafted to scale with adequate notes and dimensions for review and fabrication) to the Engineer and Landscape Architect for approval. Fixing components and details to be confirmed through shop drawing process.
- Contractor is to dispose of any contaminated material removed from site
- All proprietary items are to be installed and fixed in accordance with the manufacturers specifications and instructions.
- All work is to be carried out in accordance with all Work-cover requirements and occupational health and safety act regulations.

Australian Standards:

Unless specified to the contrary, materials, installation and construction practice shall be in accordance with the requirements of the latest editions of the following standards as appropriate:

Steel materials, construction, fabrication and erection: To AS 4100.

Concrete materials, construction, fabrication and erection: To AS 3600. Formwork design and construction, formed surfaces: To AS 3610 and AS 3610.1.

Plywood formwork: To AS 6669.

Profiled steel sheeting, including shear connectors: To AS 2327.1.

Residential ground slabs and footings: To AS 2870.

Concrete structures for retaining liquids: To AS 3735.

Precast members: Conform to the recommendations of NP:PCH (Precast concrete handbook).

- Transport, erection and installation: To AS 3850.
- Precast flooring: To AS 3600.
- Strand, bar and wire: To AS/NZS 4672.1
- AS 1012 Methods of Testing Concrete
- AS 1302 Steel Reinforcing Bars for Concrete
- AS 1379 The Specification and Manufacture of Concrete
 AS 1554 SAA Structural Steel Welding Code
- AS 3600 Concrete Structures
- AS4100 Steel Structures

Where there are differences between the requirements of the Specification or the Drawings and the above Standards, the Specification or Drawings shall take precedence where more onerous.

Materials or operations not covered by the above Standard Codes and Specifications shall conform to the appropriate Australian Standard, or if no such Standard exists they shall conform to the Standards laid down by the ASTM.

Soil: On structure and raised planter

All soil profiles shall be to a proprietary Fytogreen system or approved equivalent. Refer Specification.

Soil : Deep soil

High quality imported soil, suitable for the establishment and on going viability of the selected vegetation, free of weed propagules and of contaminants and meeting all the criteria of natural soil and soil blends in AS4419 unless specified differently in this document.

FOR INFORMATION

Irrigation

Sub-surface irrigation is to be designed and installed to <u>all</u> planted garden beds within public and private areas on title, including those on structure (across all levels) and those in deep soil areas, as documented by Irrigation Contractor.

The Irrigation Contractor shall determine the water demands, available water supply location, size, pressures and flows and design an automatic sub-surface irrigation system to service the garden bed areas and planters designated on the drawings.

The Irrigation Contractor is to coordinate with The Contractor to ensure the provision for all pipes and conduits from points of water supply to garden bed areas in order to facilitate the construction of the irrigation system.

The irrigation design will need to consider the joint use of mains water supply and collected stored water as per the Sustainability management plan. Refer to Civil documentation for storage tank, drainage and connection locations.

The Irrigation contractor is to design and supply a maintenance schedule compatible with the long term, successful use of the irrigation system including tasks such as inspection intervals, flushing requirements and any other routine maintenance activities required through the life of the system.

Drainage

It is the responsibility of the contractor to ensure that all drainage meets manufacturers specifications. Refer Civil documentation for all drainage items.

Refer Engineers Drawings and Specifications for all Concrete performance strength, reinforcement and sub-base requirements.

Landscape Architect is responsible for colour and finish specifications only.

Planting

All plants must be laid out in accordance with planting plans and approved by Landscape architect prior to installation.

Stakes and ties

Generally: If plants are unable to be self supported or if stakes are damaged, stake or restake the plants as follows:

Drive stakes into the ground at least one third of their length, avoiding damage to the root system.

Stake sizes:

- For plants ≥ 2.5 m high: Three 50 x 50 x 3000mm stakes per plant [finalise length on site]
- For plants 1 2.5 m high: Two 50 x 50 x 1800 mm stakes per plant.
- For plants < 1 m high: One 38 x 38 x 1200 mm stake per plant.

Do not single stake large plants.

Removal: If plants are robust with well developed systems and are strong enough to no longer require support, remove stakes and ties.

Tree anchoring system: Plant using nominated tree anchoring system and stake as shown on Landscape Architect's drawings.

Weeding

Weeds: Unwanted plants and grasses considered invasive to the locality.

Program:

Trees and shrubs: As required for planted, paved and mulched areas to be weed free when observed at bi-weekly intervals.

Method: Clear and keep clear vigorous ground covers 200 mm from the base of any shrub or tree.

Small areas: By hand.

Herbicide application: Avoid windy days or if rain is likely to follow within 12 hours. Apply: To the manufacturer's instructions and material data and safety sheets. When the weather is humid with moderate temperatures and maximum sunlight.

Bicycle Parking

Bicycle parking dimensioned in accordance with Australian Standard for Parking Facilities – Bicycle Parking (AS2890.3) or otherwise justified by a suitably qualified professional to the satisfaction of the Responsible Authority.

All trees west of the site marked on the endorsed plans as being retained must have a Tree Protection Zone (TPZ) to the satisfaction of the Responsible Authority. The fencing associated with this TPZ must meet the following requirements:

Extent

The tree protection fencing (TPF) is to be provided to the extent of the identified TPZ.

If works are shown on any endorsed plan of this permit within the confines of the calculated TPZ, then the TPF must be taken in to only the minimum amount necessary to allow the works to be completed.

Fencing

All tree protection fencing required by this permit must be erected in accordance with the approved TPZ.

The TPF must be erected to form a visual and physical barrier and must be a minimum height of 1.5 metres and of chain mesh or similar fence with 1.8 metre support posts (e.g. treated pine or similar) every 3-4 metres, including a top line of high visibility plastic hazard tape erected around the perimeter of the fence.

Signage

Fixed signs are to be provided on all visible sides of the TPF clearly stating "Tree Protection Zone – No Entry", to the satisfaction of the Responsible Authority.

Irrigation

The area within the TPZ and TPF must be irrigated during the summer months with 1 litre of clean water for every 1cm of trunk girth measured at the soil/trunk interface on a weekly basis.

Access to TPZ

Should temporary access be necessary within the Tree Protection Zone during the period of construction, the Responsible Authority must be informed prior to relocating the fence (as it may be necessary to undertake additional root protection measures such as bridging over with timber).

Raised Planters:

Raised planter construction is to include, but not necessarily be limited to, the supply and installation of agricultural drains, waterproofing membranes, drainage cells at base, filter fabric, planting medium, mulch and irrigation. Planters must be effectively tanked and lined with core flute to prevent leaking. Drainage cells are to be provided at the base of the planter and are to be covered with a layer of filter fabric and a 100mm deep layer of Hydrocell Hard foam RG30.

A drainage outlet is to be installed in the base of the planter with the floor of the planter sloped towards it. Supply soil mix and spread evenly. Compact lightly and evenly in 150mm layers. Avoid differential subsidence and excess compaction and produce a finished surface that is graded evenly and ready for planting. Allow for min 50mm layer of specified mulch to top of beds and a finished level 25-50mm below the planter rim. Drip irrigation as specified is to be installed beneath the mulch layer.

WARNING AND DISCLAIMER

Beware of underground services.

The locations of underground services are approximate only and their exact location and level shall be proven on site by contractor prior to commencing works. No guarantee is given that all existing services are show.

Site setout shall be to Australian Map Grid (AMG). An electronic format of the drawings will be issued as an Autocad 2D file for the purposes of surveyed setout. Such files shall be issued under Superintendent written instruction.


All levels grades and dimensions shall be confirmed onsite prior to construction of works. If any discrepancies arise such instances shall be directed to the Superintendent for clarification and written confirmation.


Landscape Drawings shall be read in conjunction with all other consultant drawings and specifications and other written instructions as may be issued through the course of the tender and contract.

ADVERTISED PLAN

NOTES

REV NO DATE DESCRIPTION PROJECT INFORMATION **GENERAL NOTES & SCHEDULES** E1 05.08.24 FOR ENDORSEMENT VICTORIA STREET DEVELOPMEN 342-348 VICTORIA STREET BRUNSWICK, VIC 3029 DRAWN BY PLOT DATE SCALE @ A1 **NORTH** N/A 05.08.2024 APPROVED PROJECT NO SHEET NO. **REV NO** L001 2302 E1 FOR ENDORSEMENT

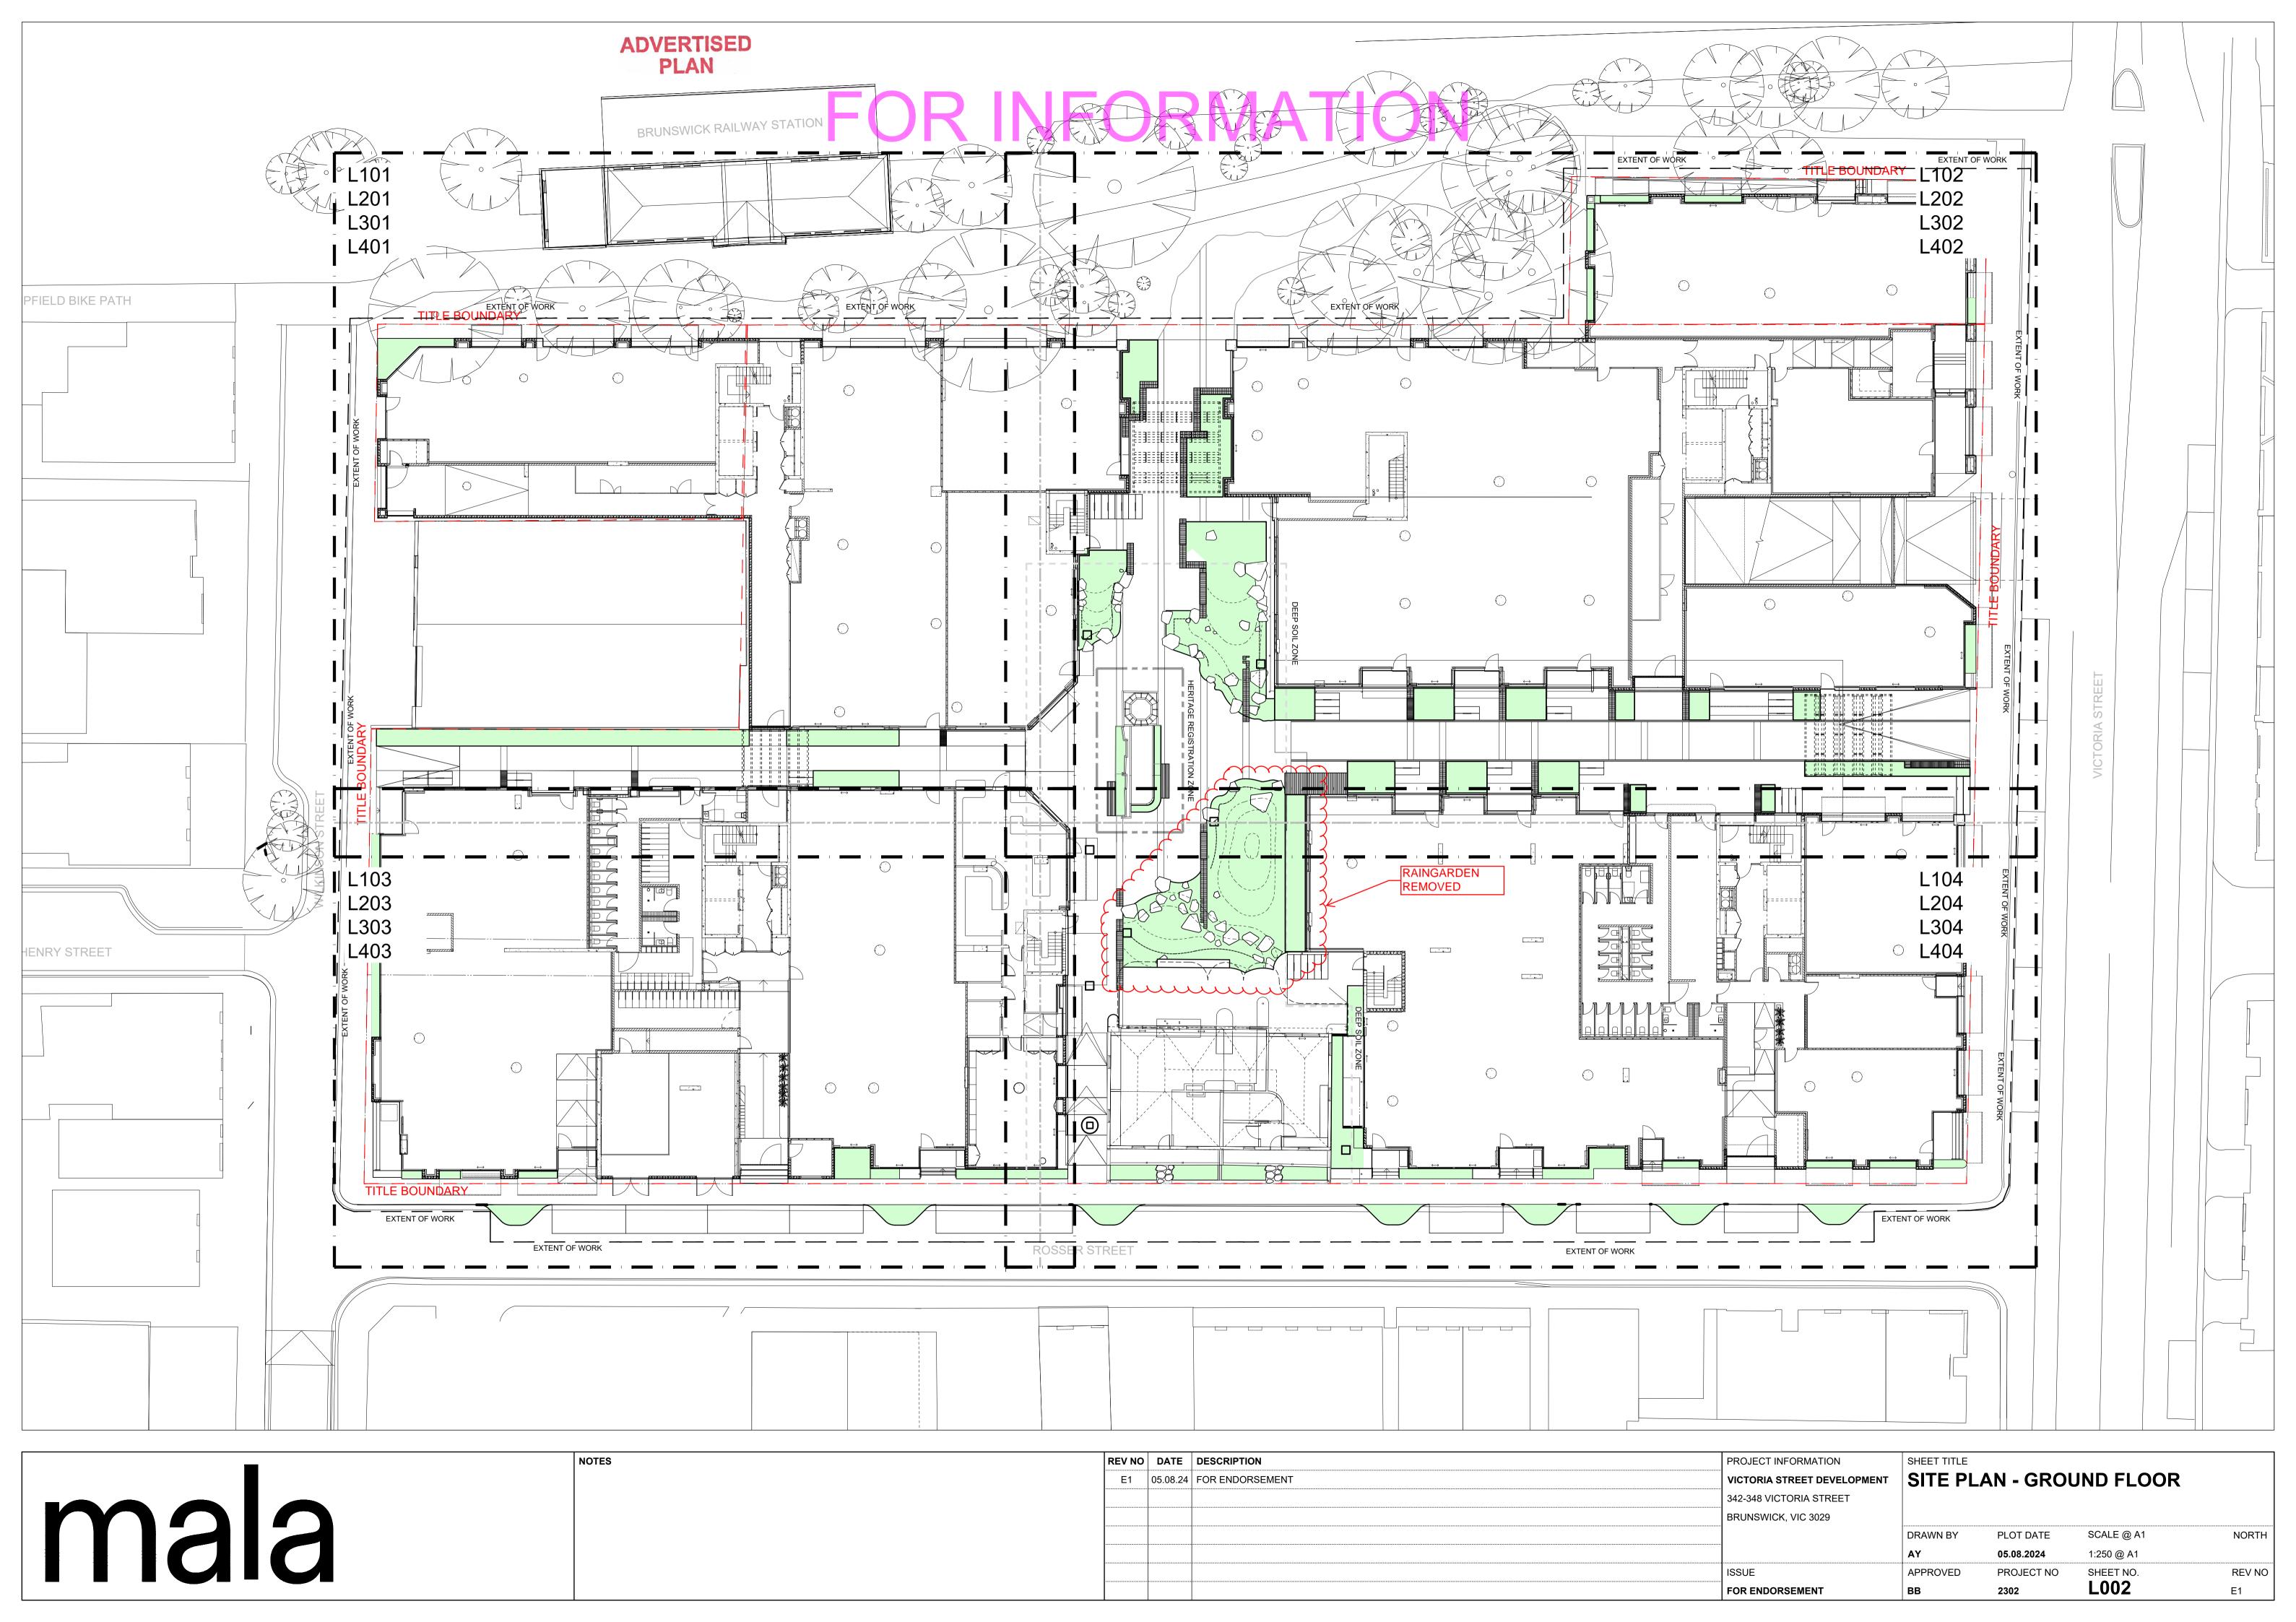


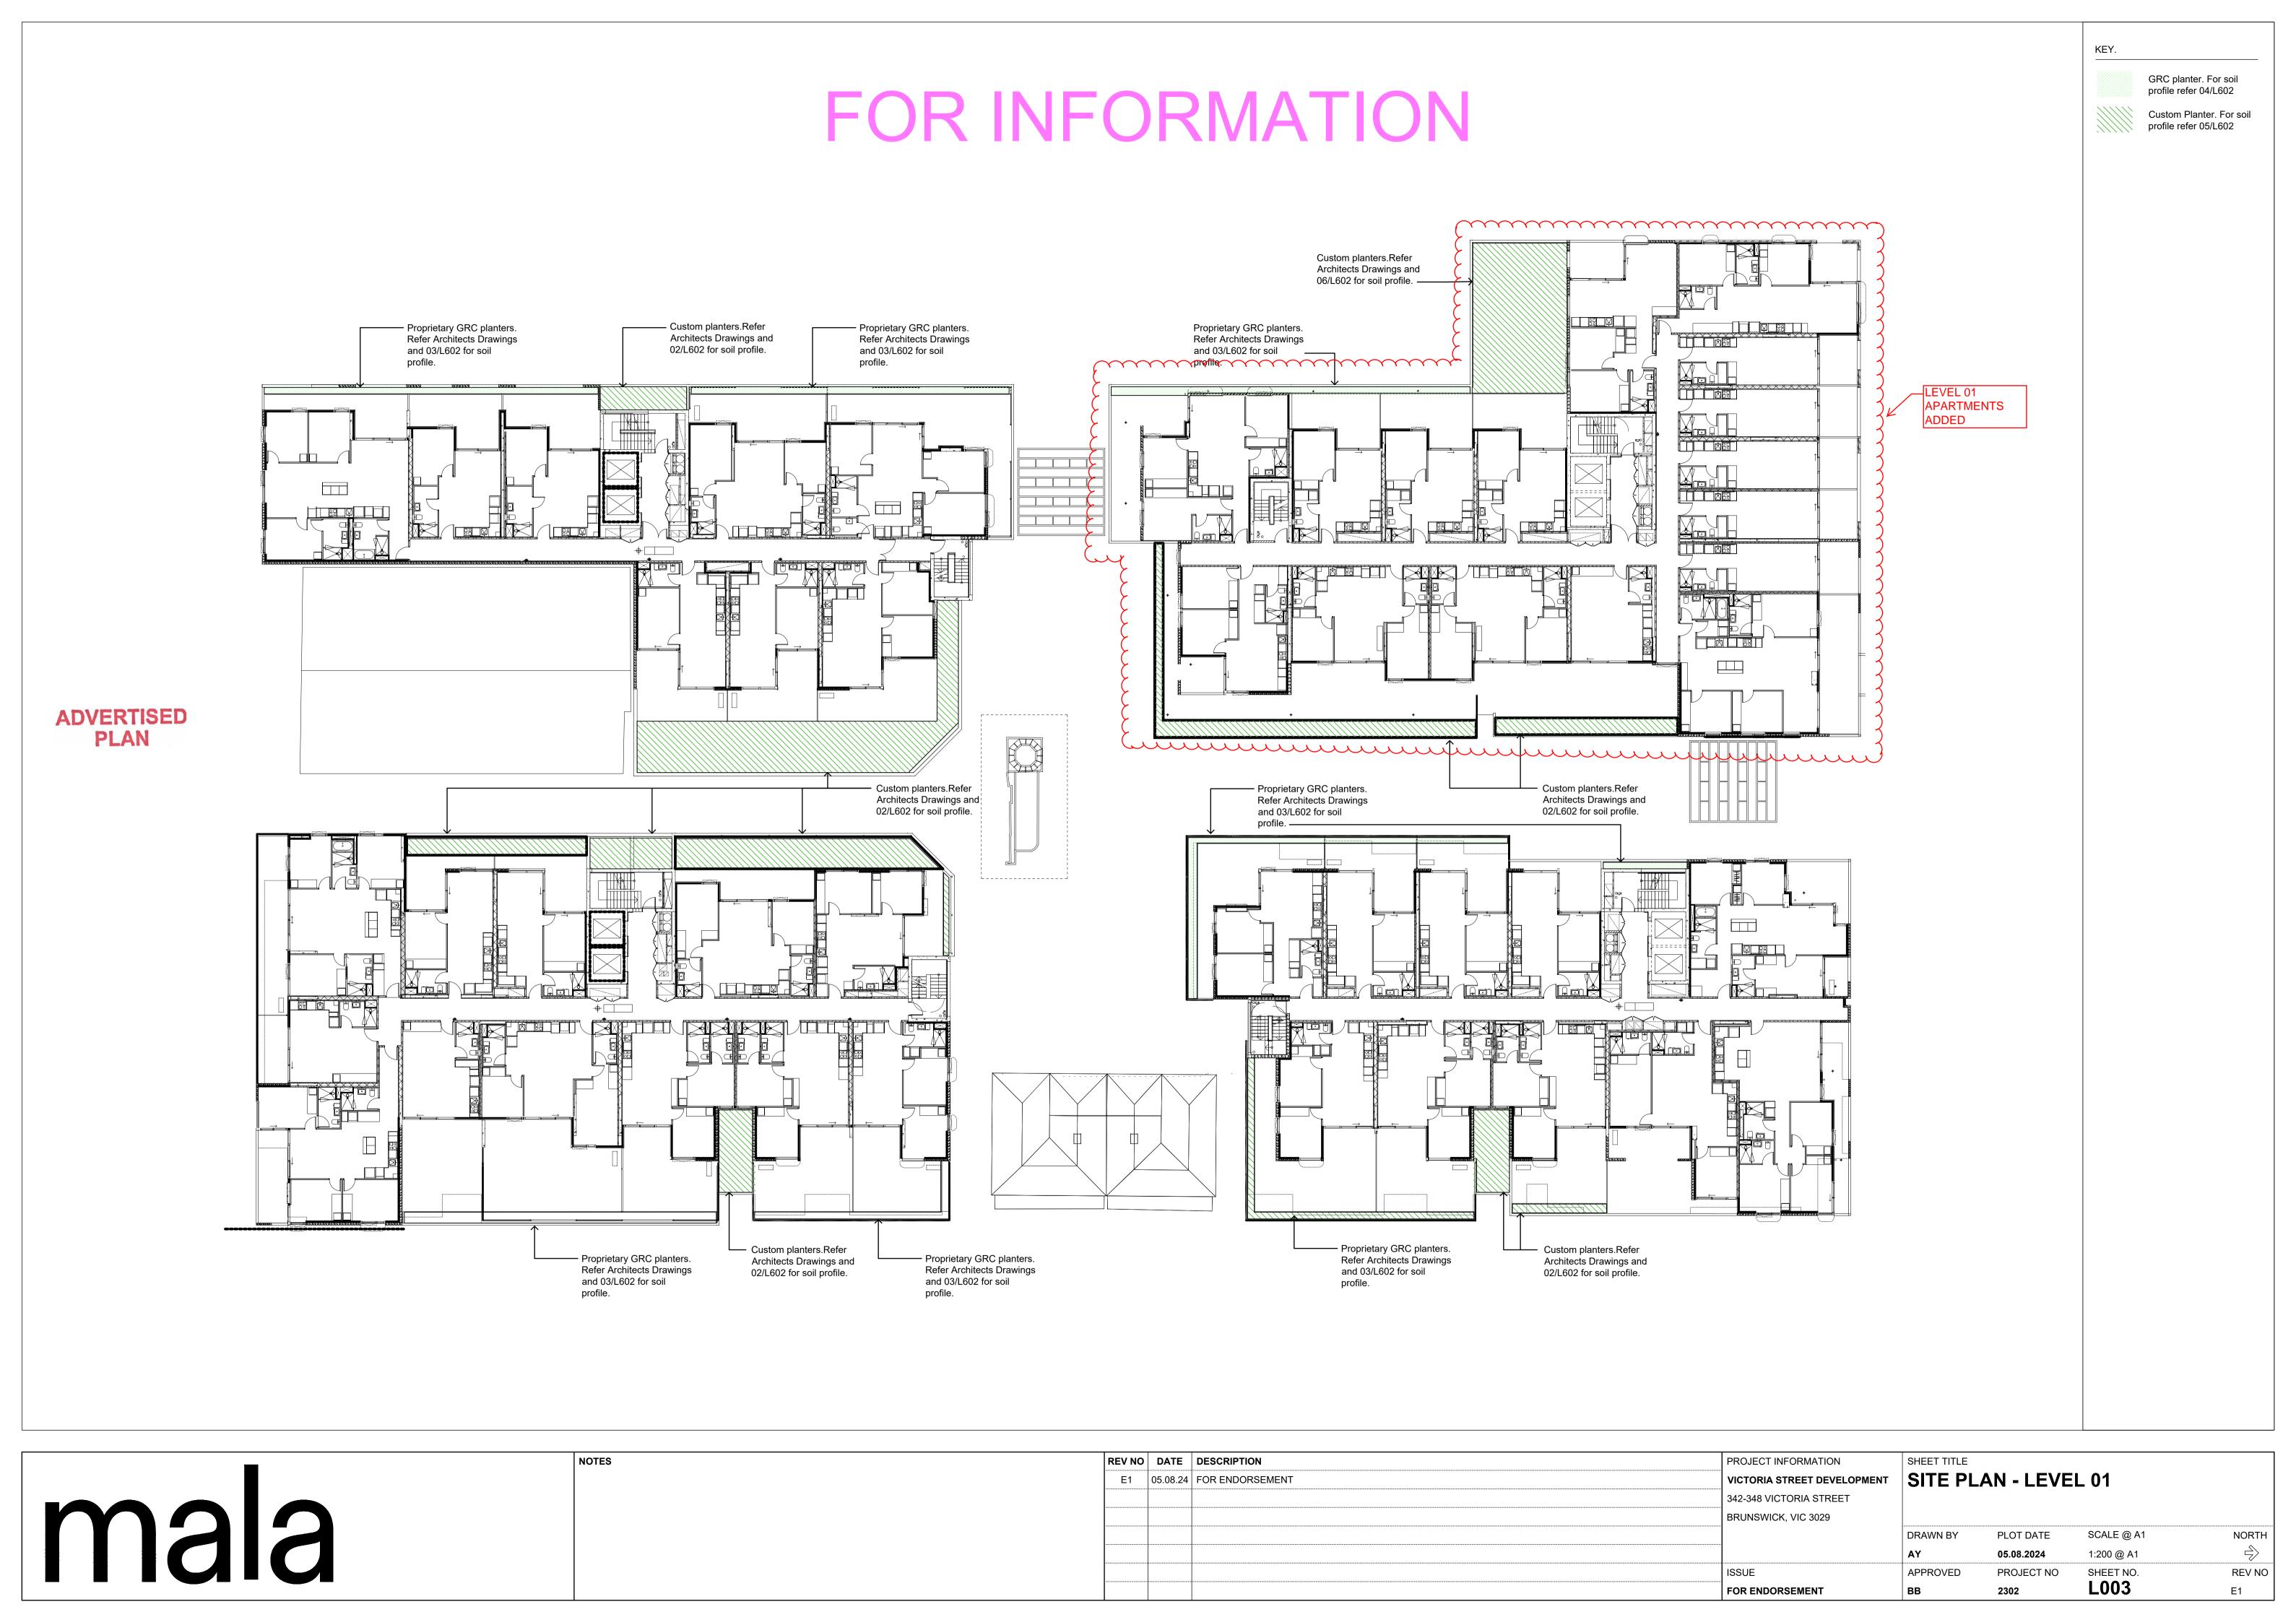



KEY.

Custom Planter. For soil profile refer 05/L602

FOR INFORMATION

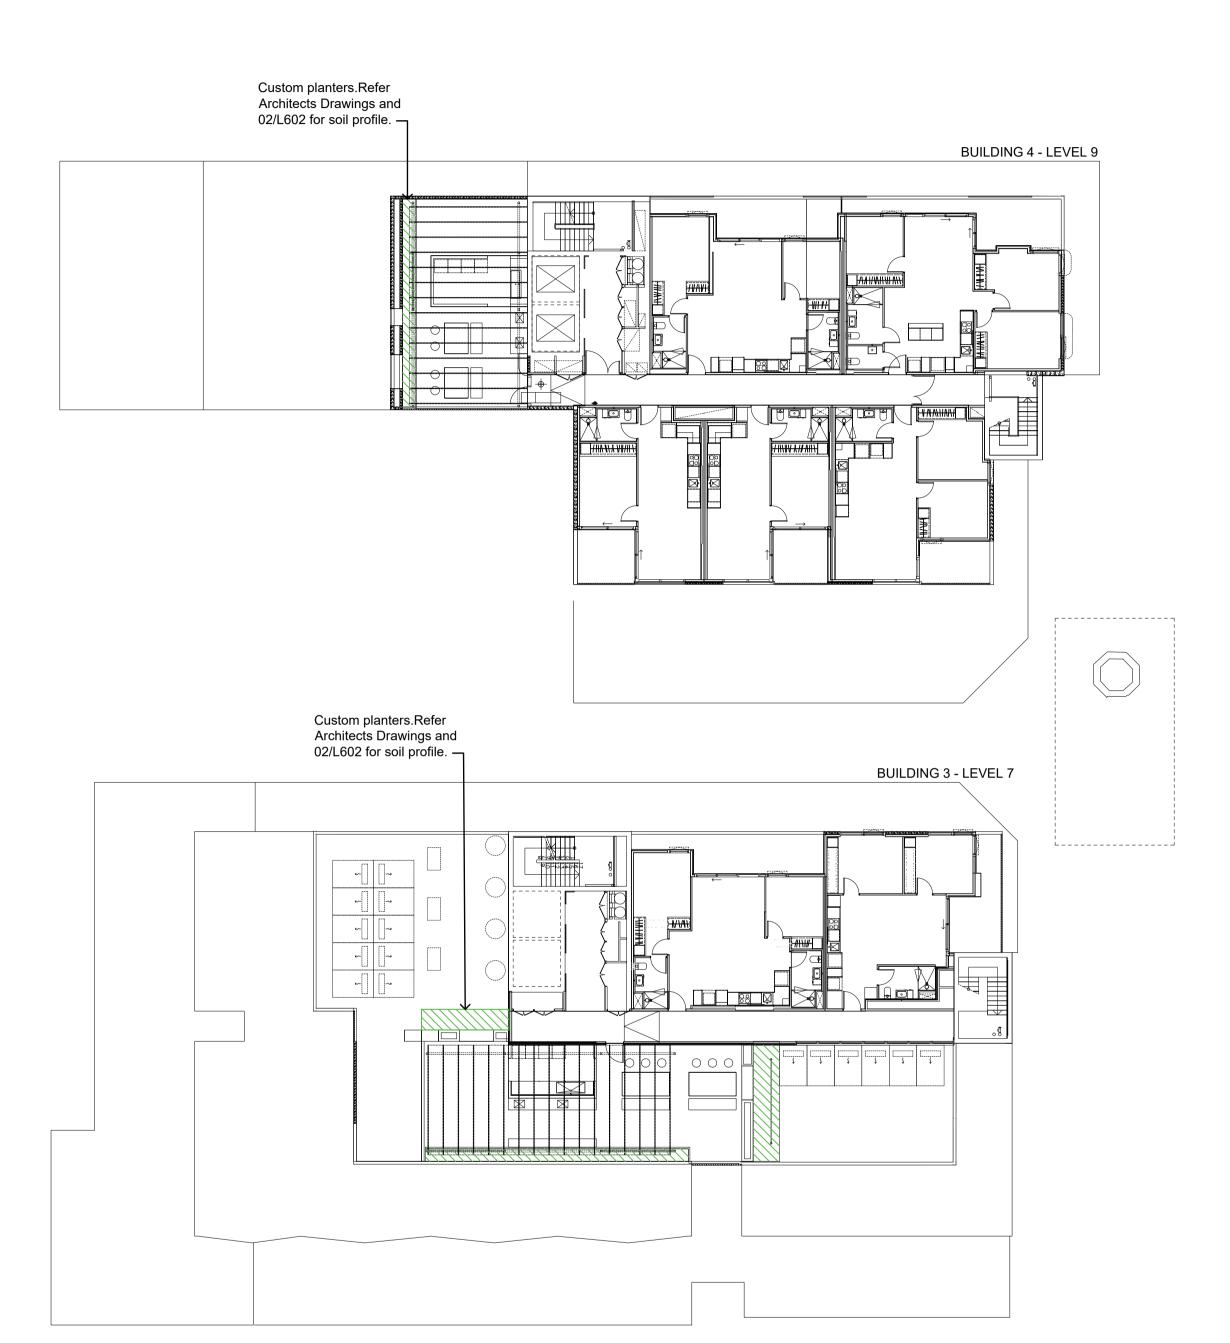

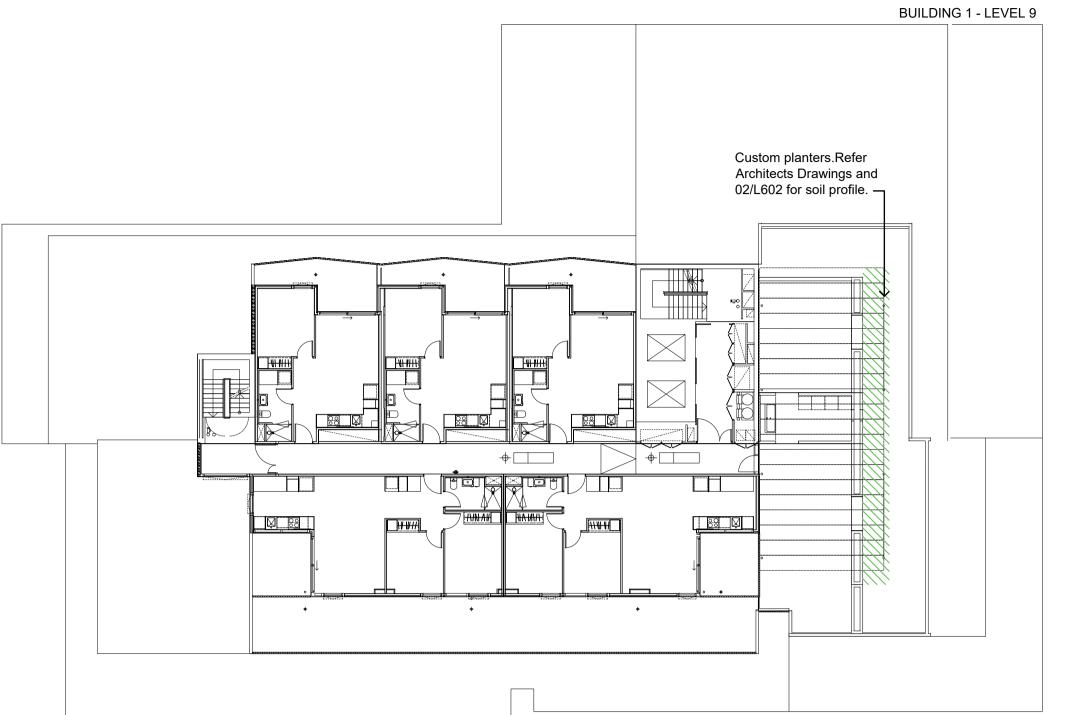


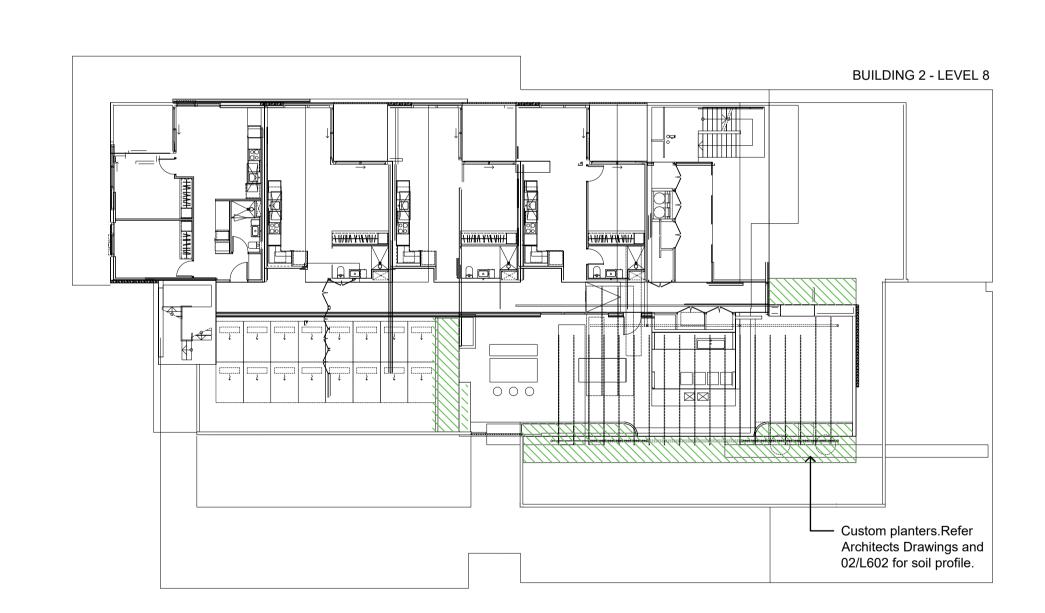



ADVERTISED PLAN


mala


REV NO	DATE	DESCRIPTION	PROJECT INFORMATION	SHEET TITLE			
E1	05.08.24	FOR ENDORSEMENT	VICTORIA STREET DEVELOPMENT	SITE PLA	N - ROOF	PLAN	
			342-348 VICTORIA STREET				
			BRUNSWICK, VIC 3029				
				DRAWN BY	PLOT DATE	SCALE @ A1	NORTH
				AY	05.08.2024	1:200 @ A1	
			ISSUE	APPROVED	PROJECT NO	SHEET NO.	REV NO
			FOR ENDORSEMENT	ВВ	2302	L004	E1

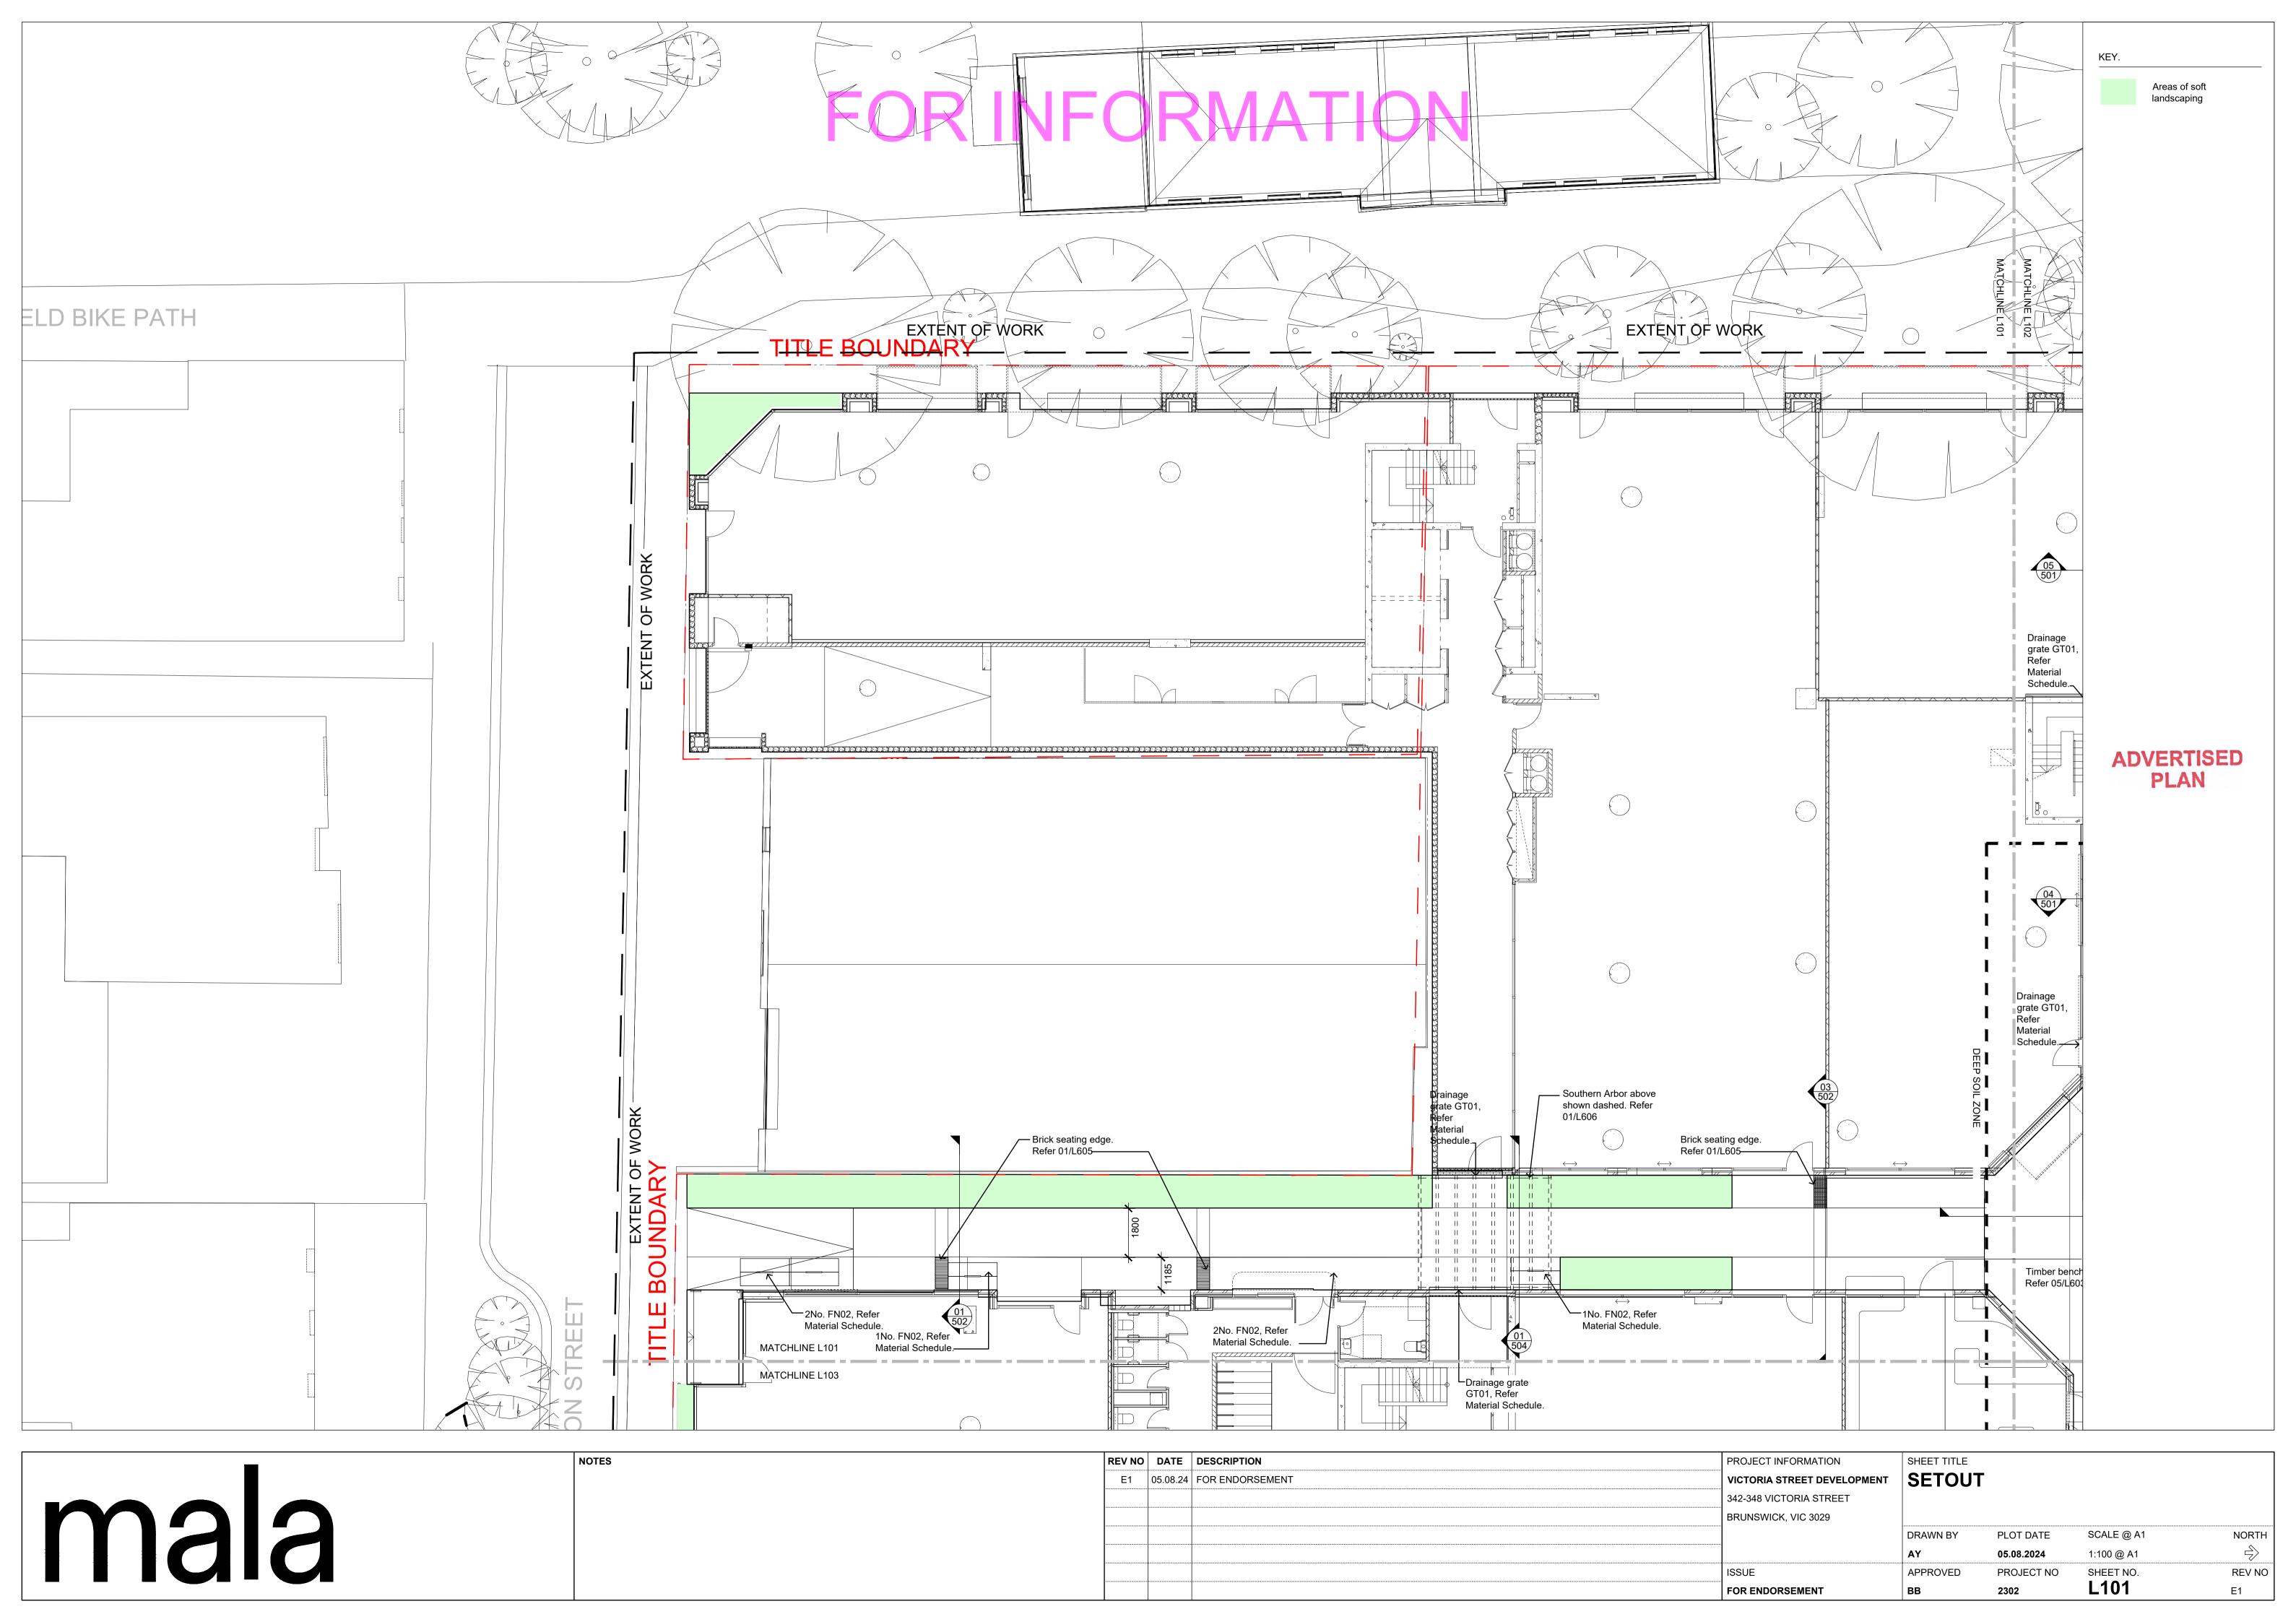


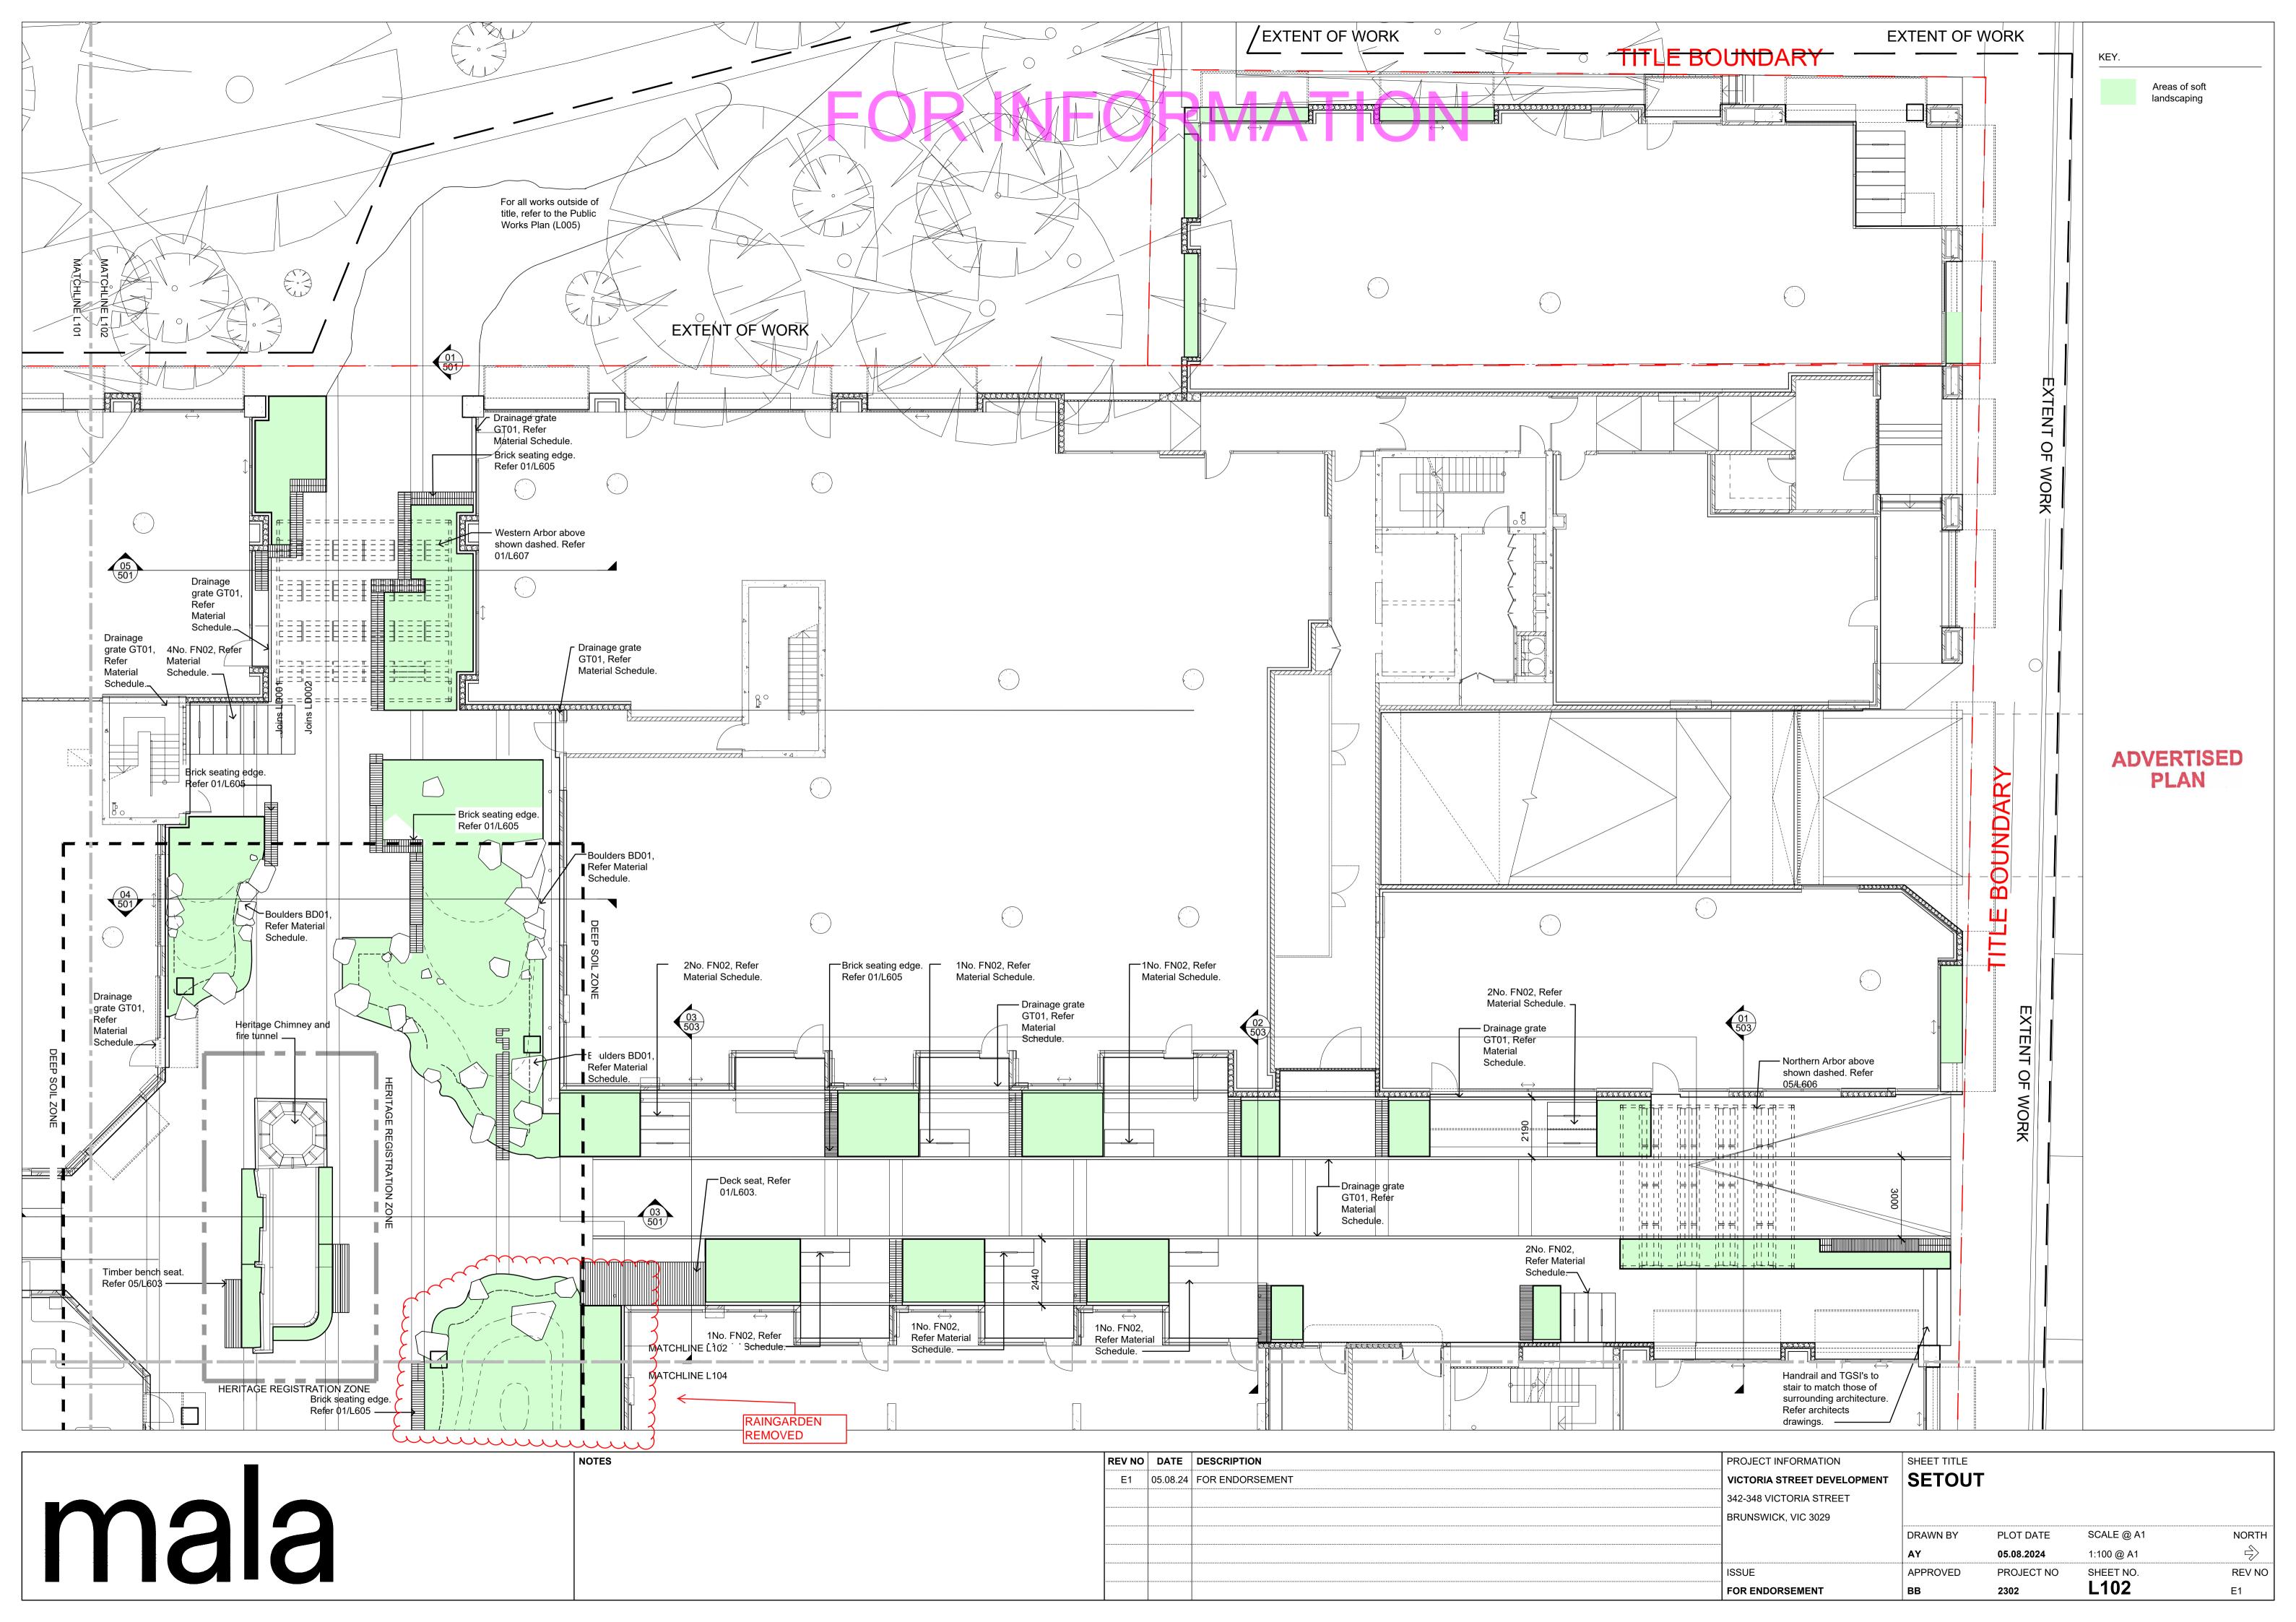


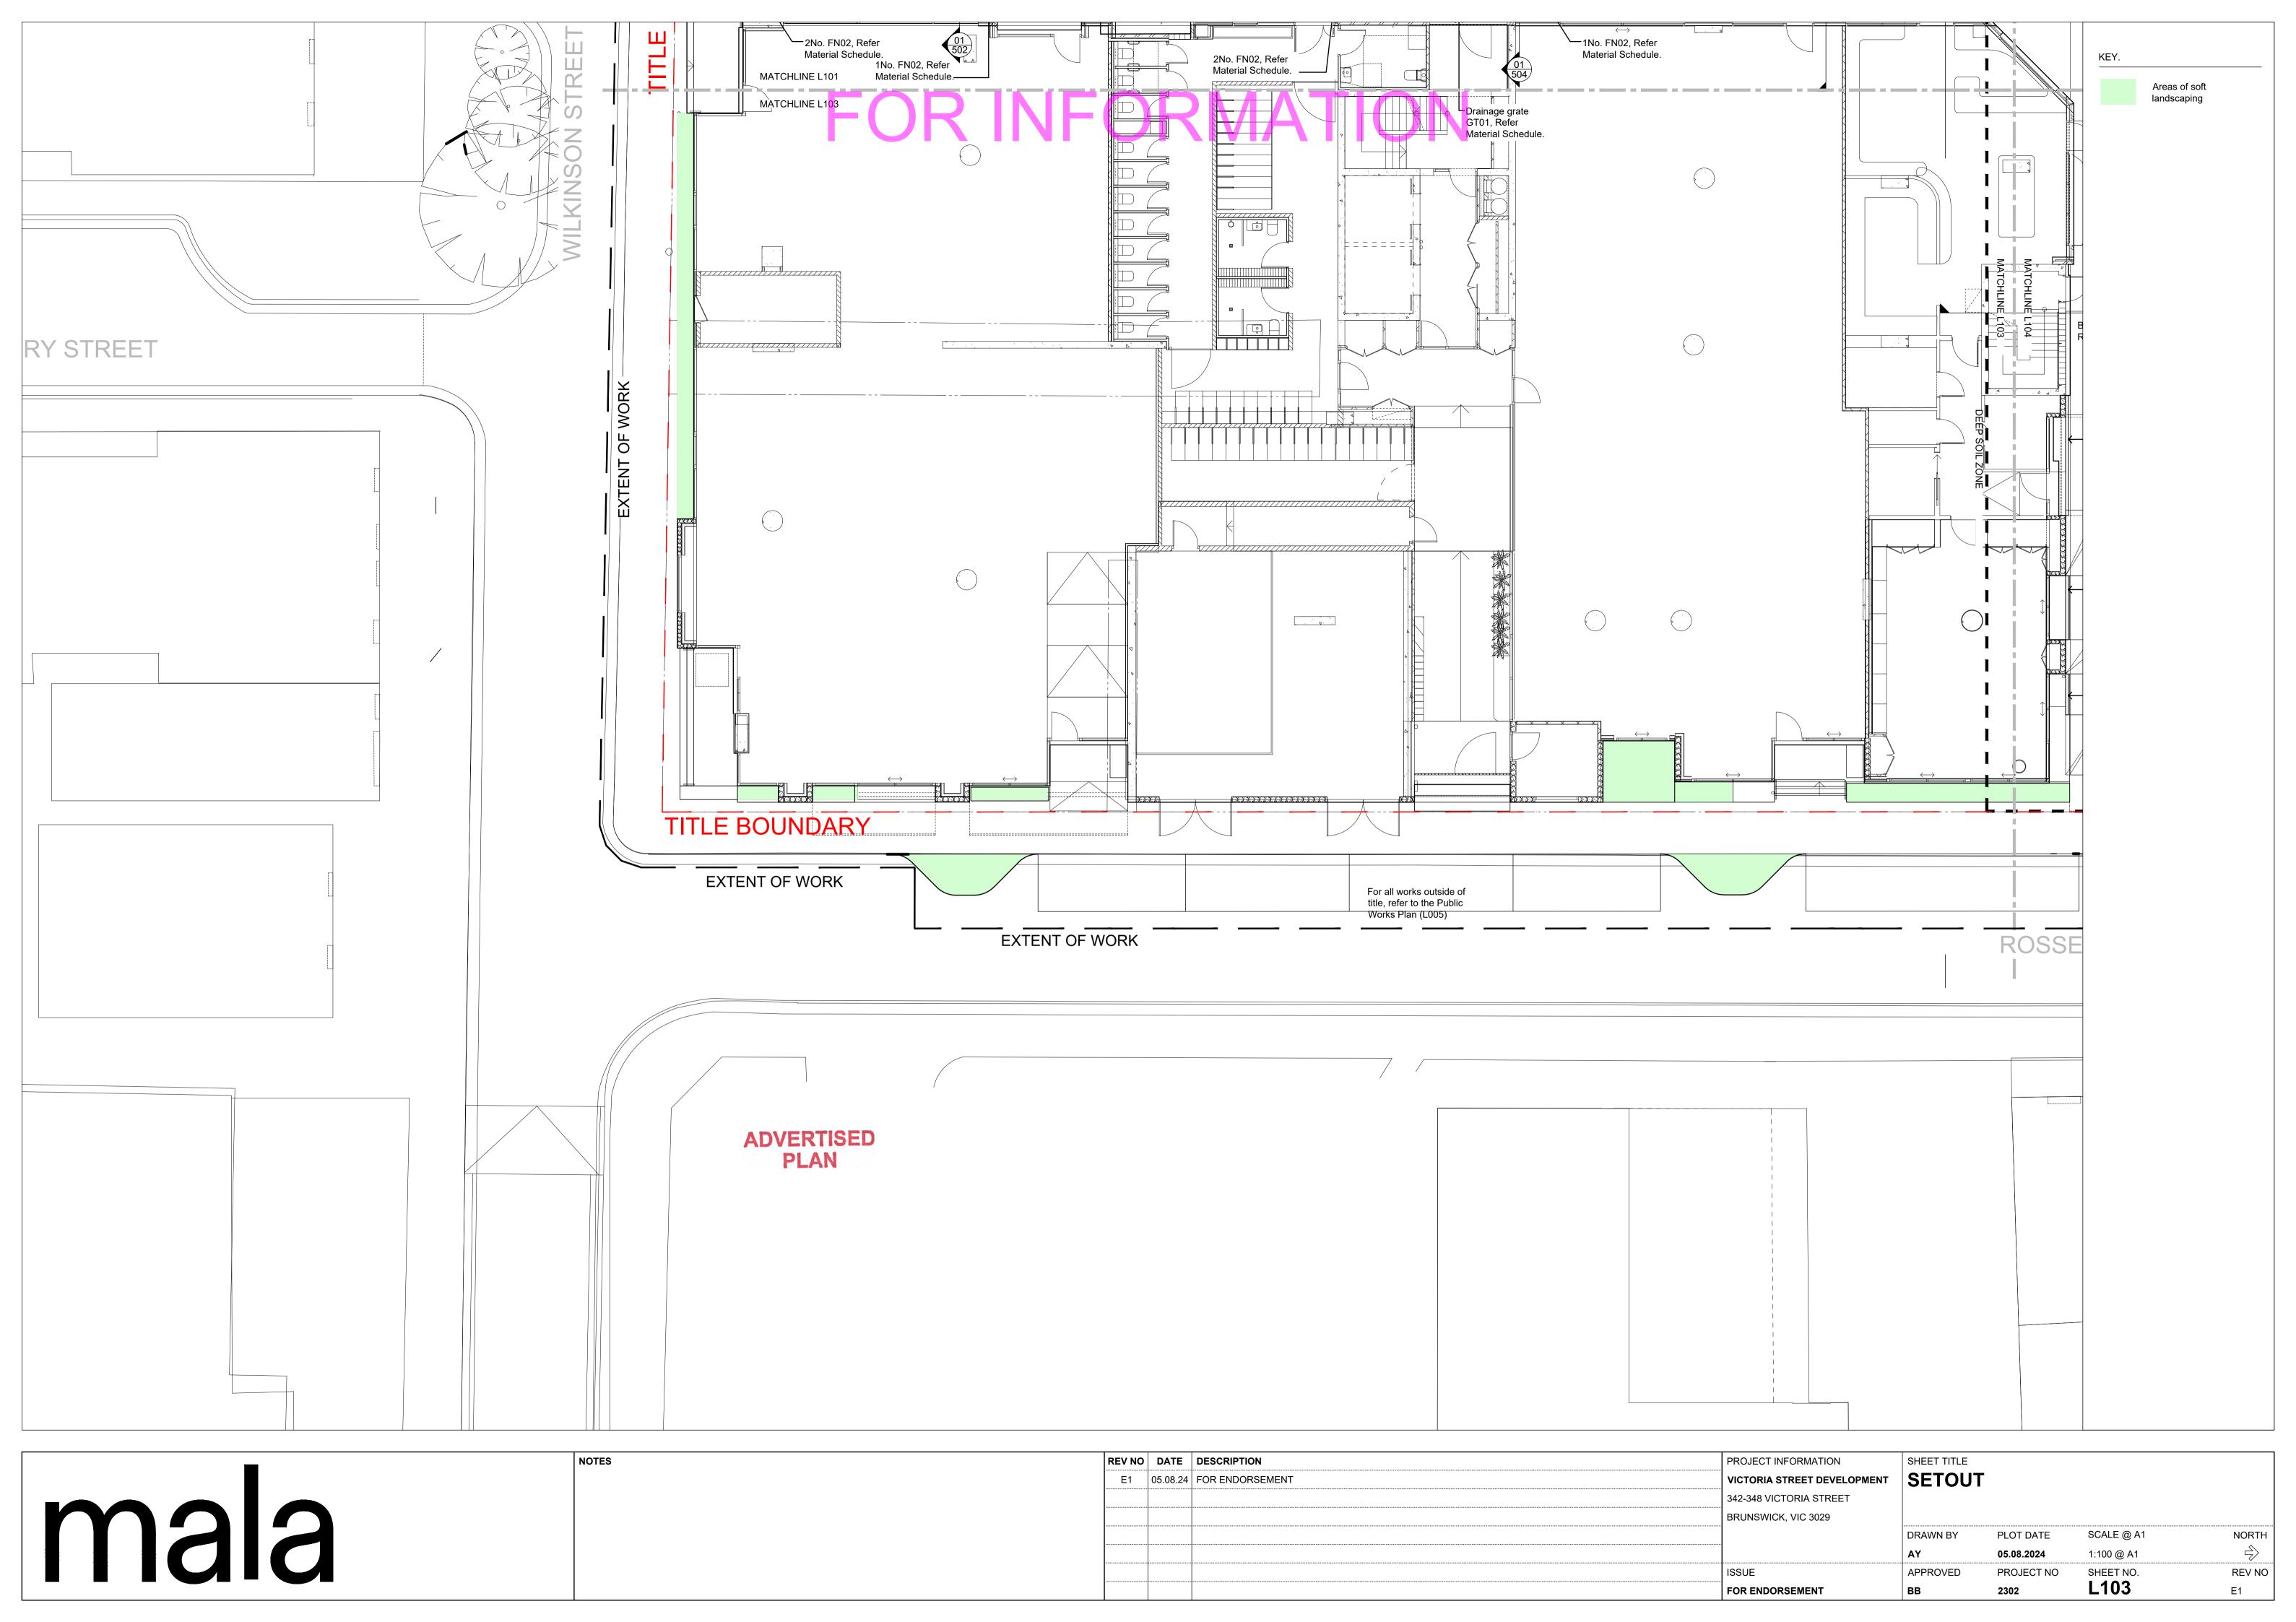


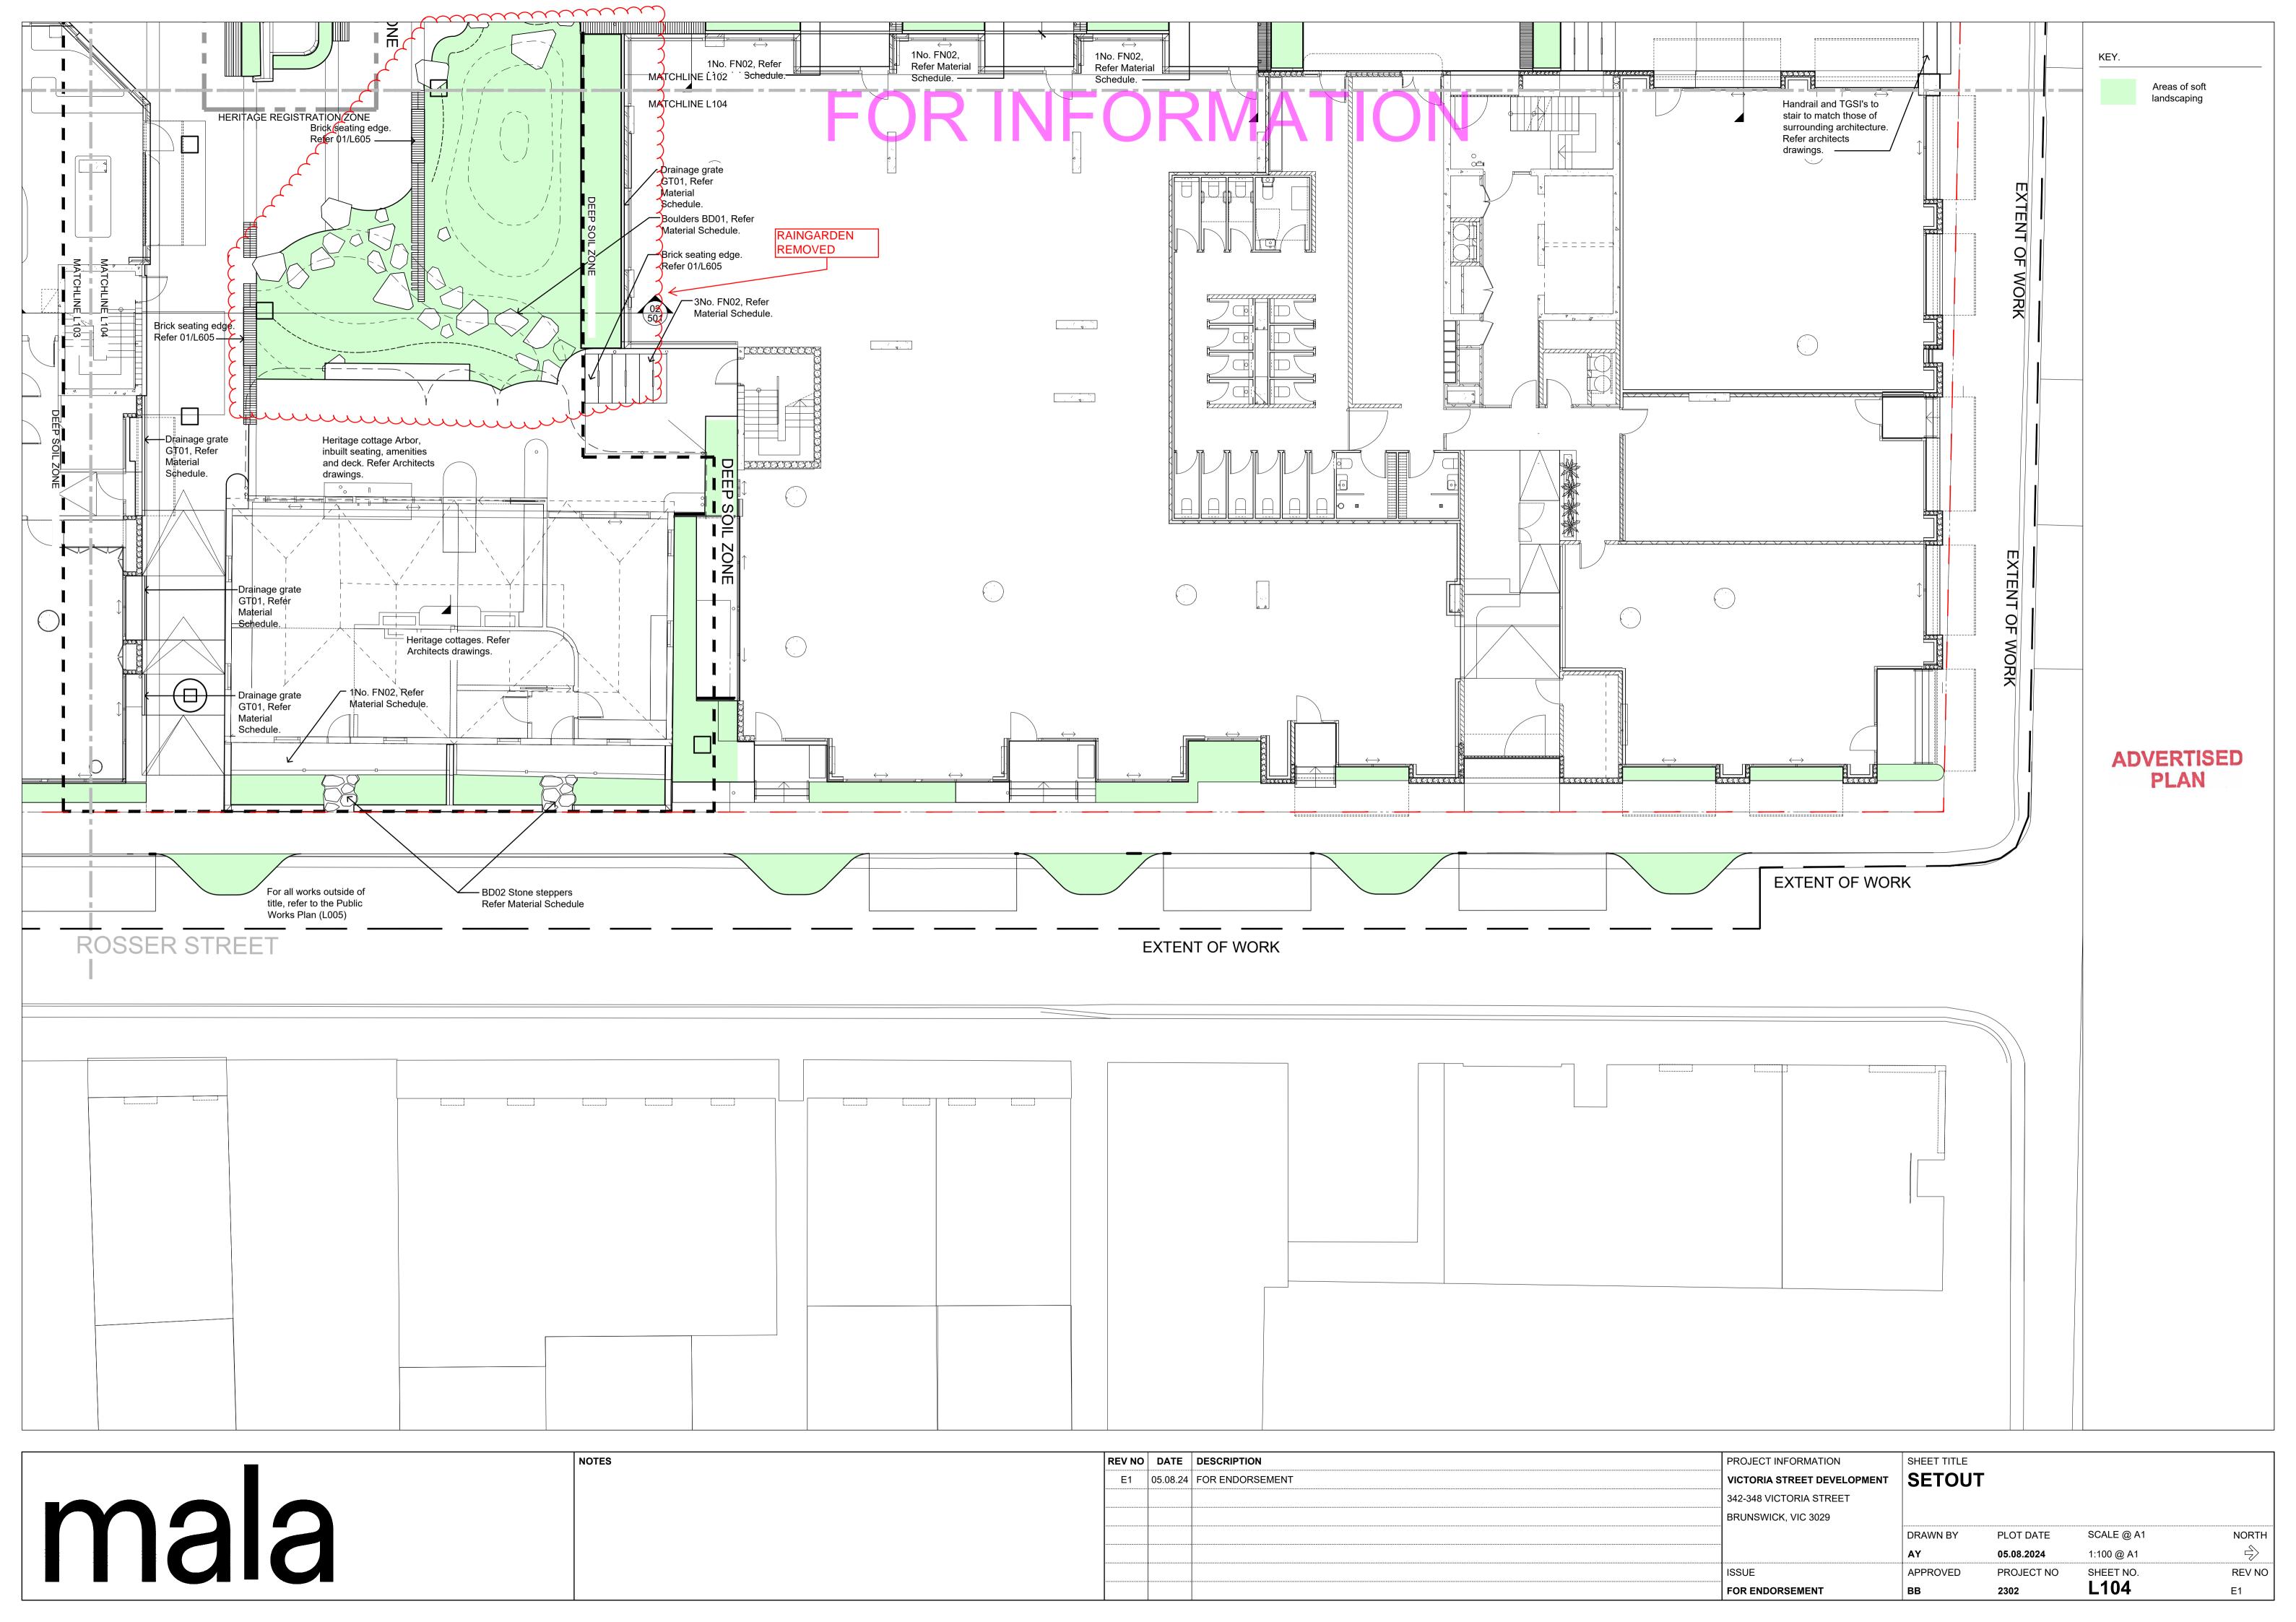


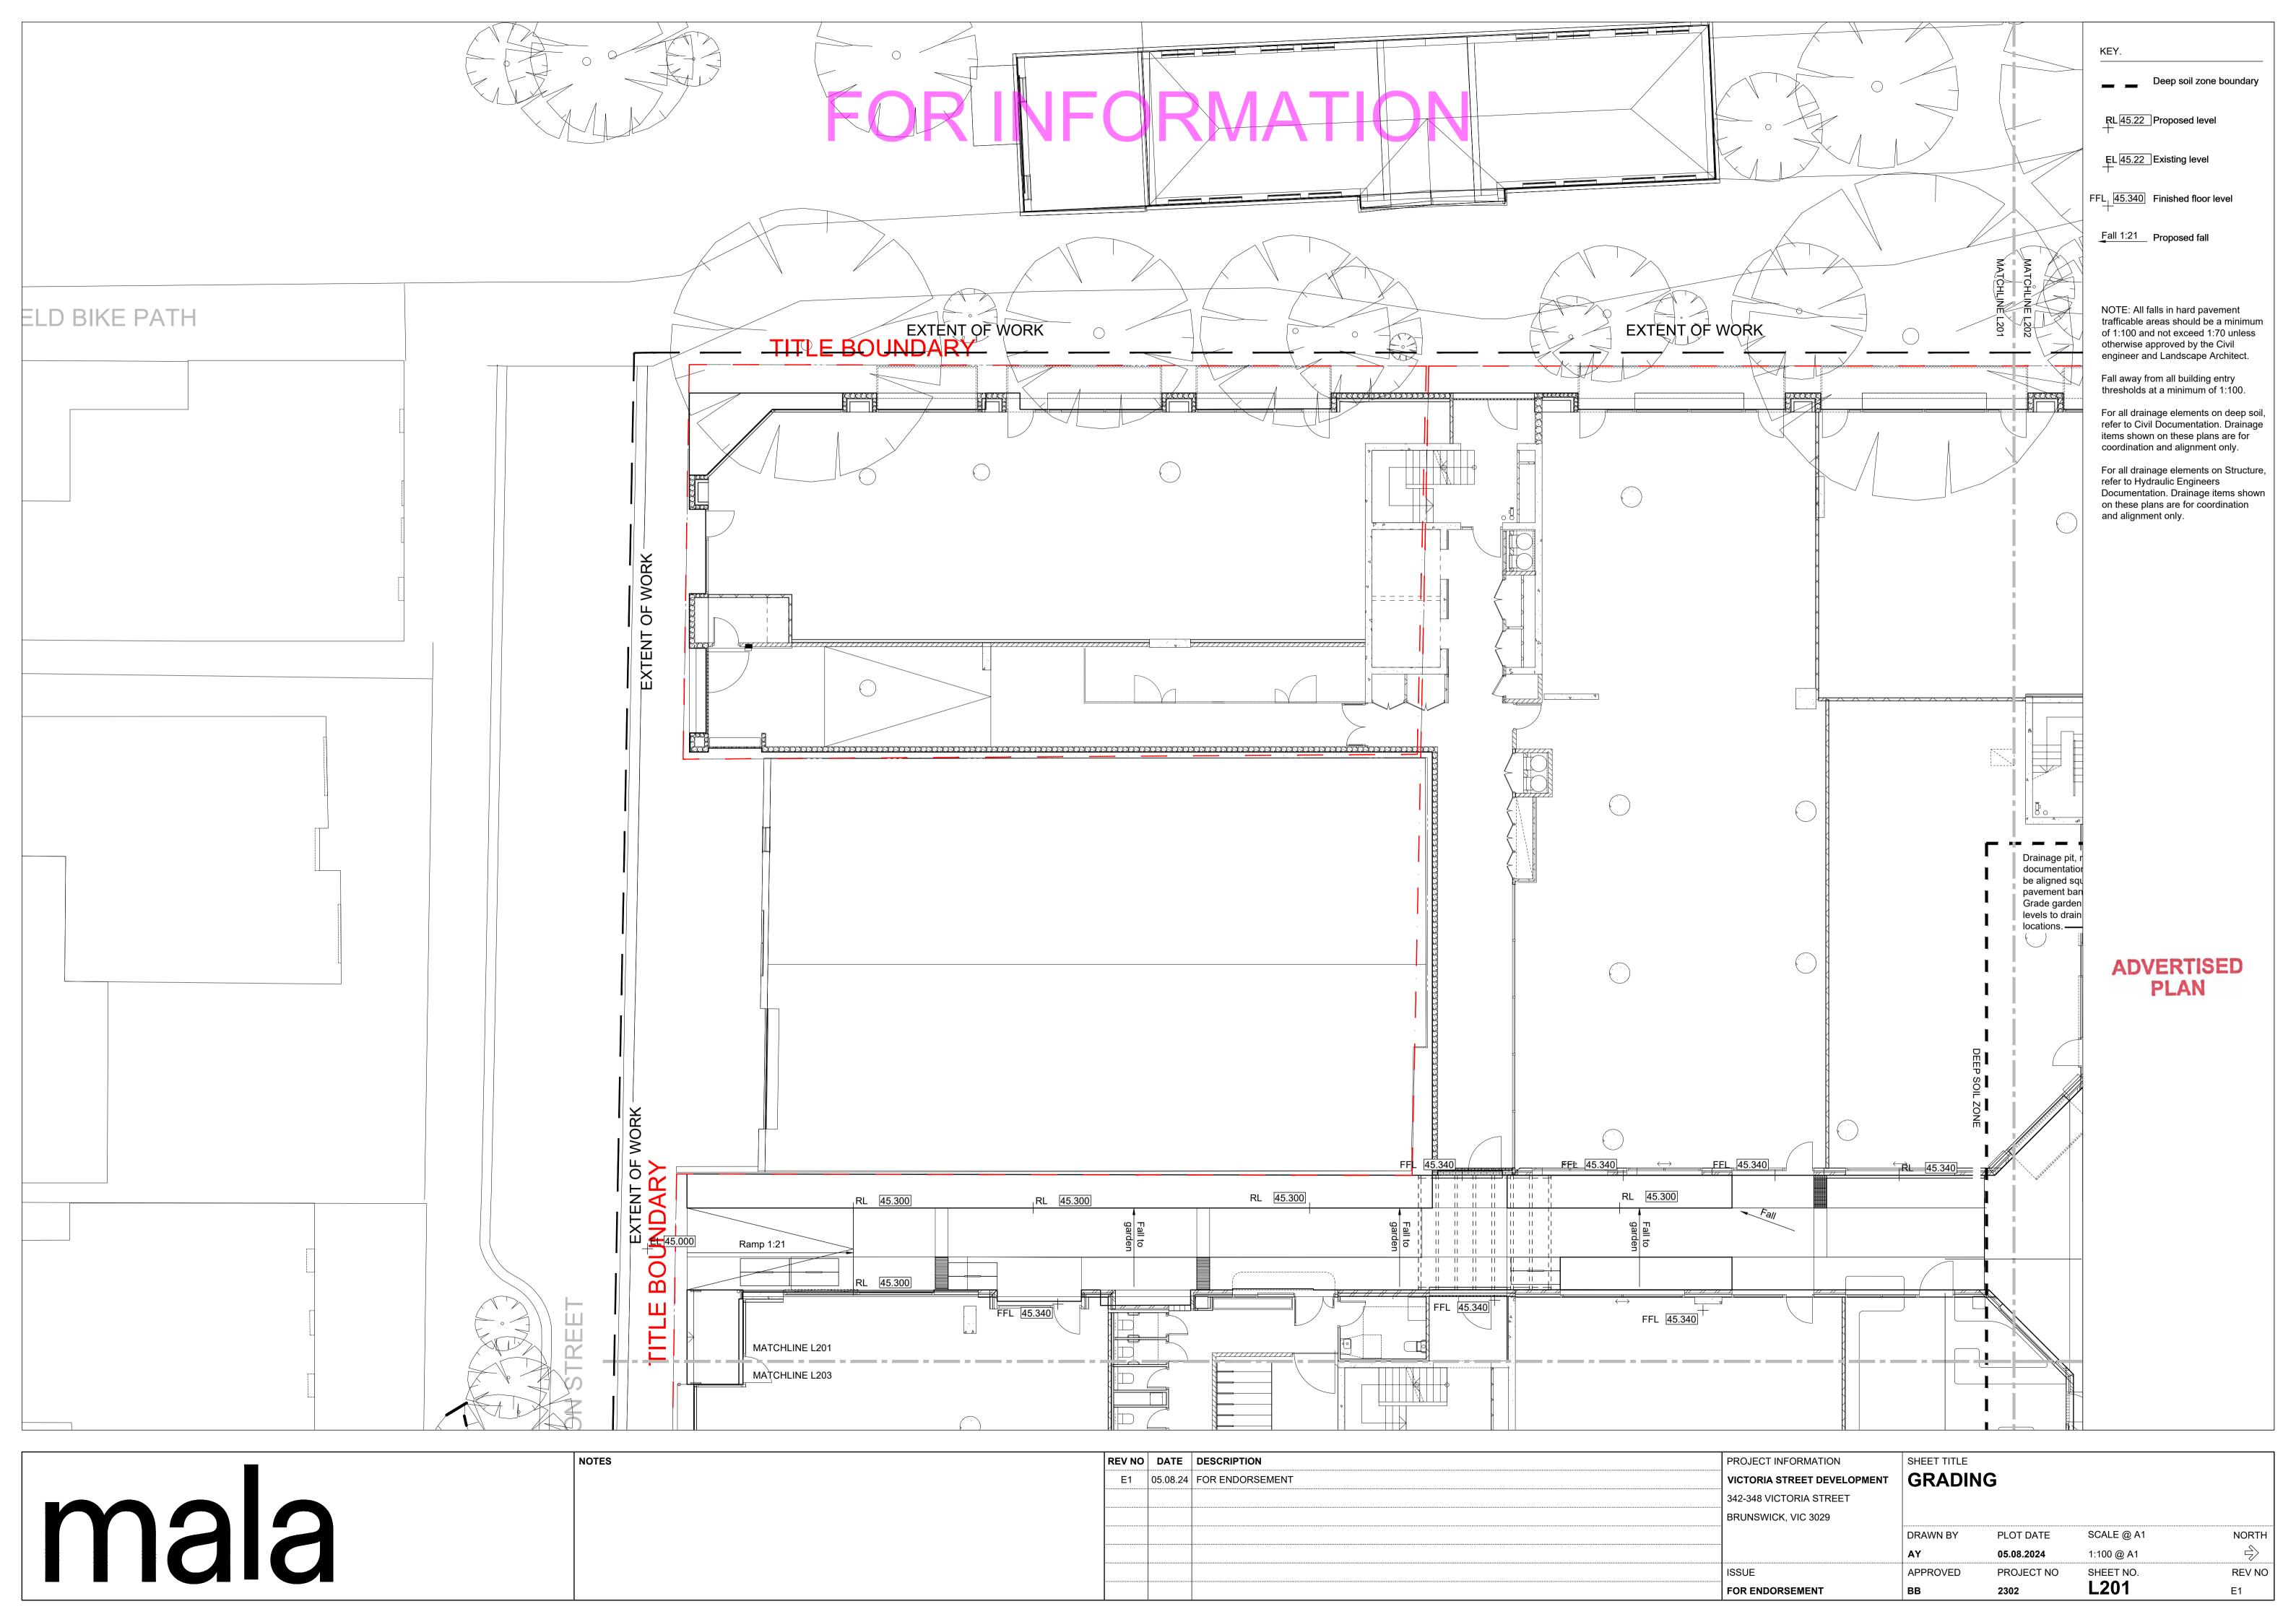


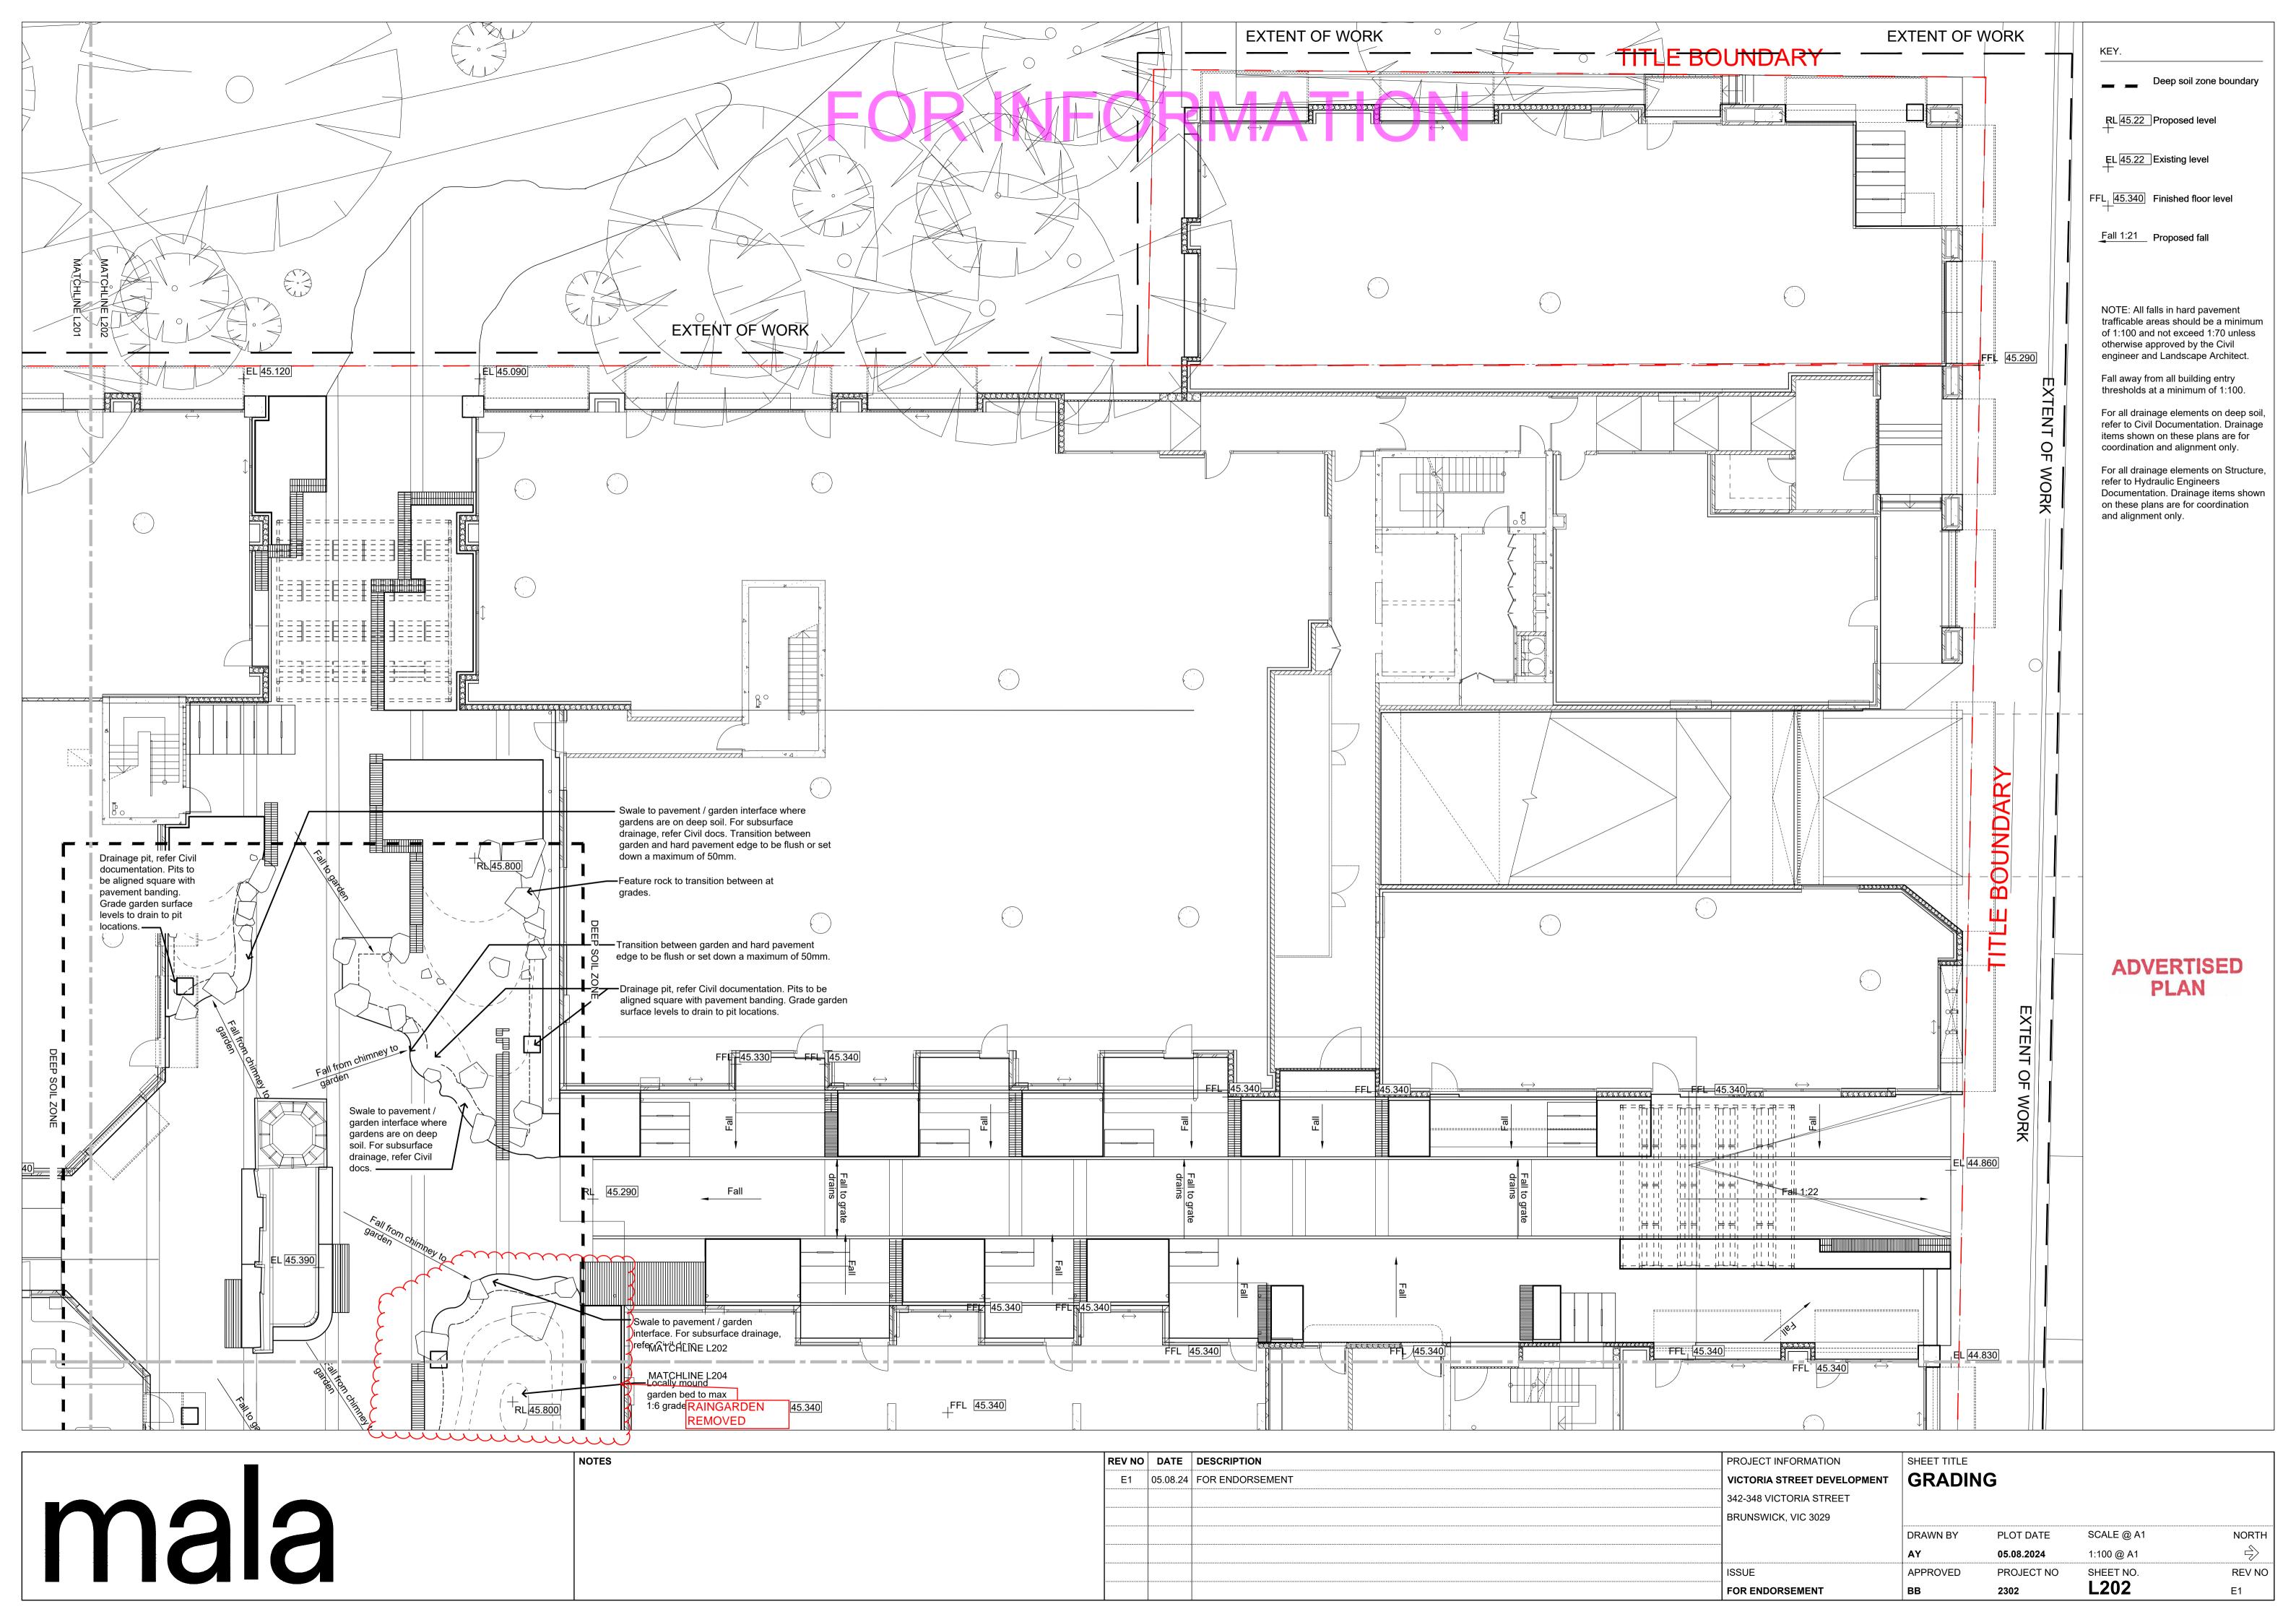


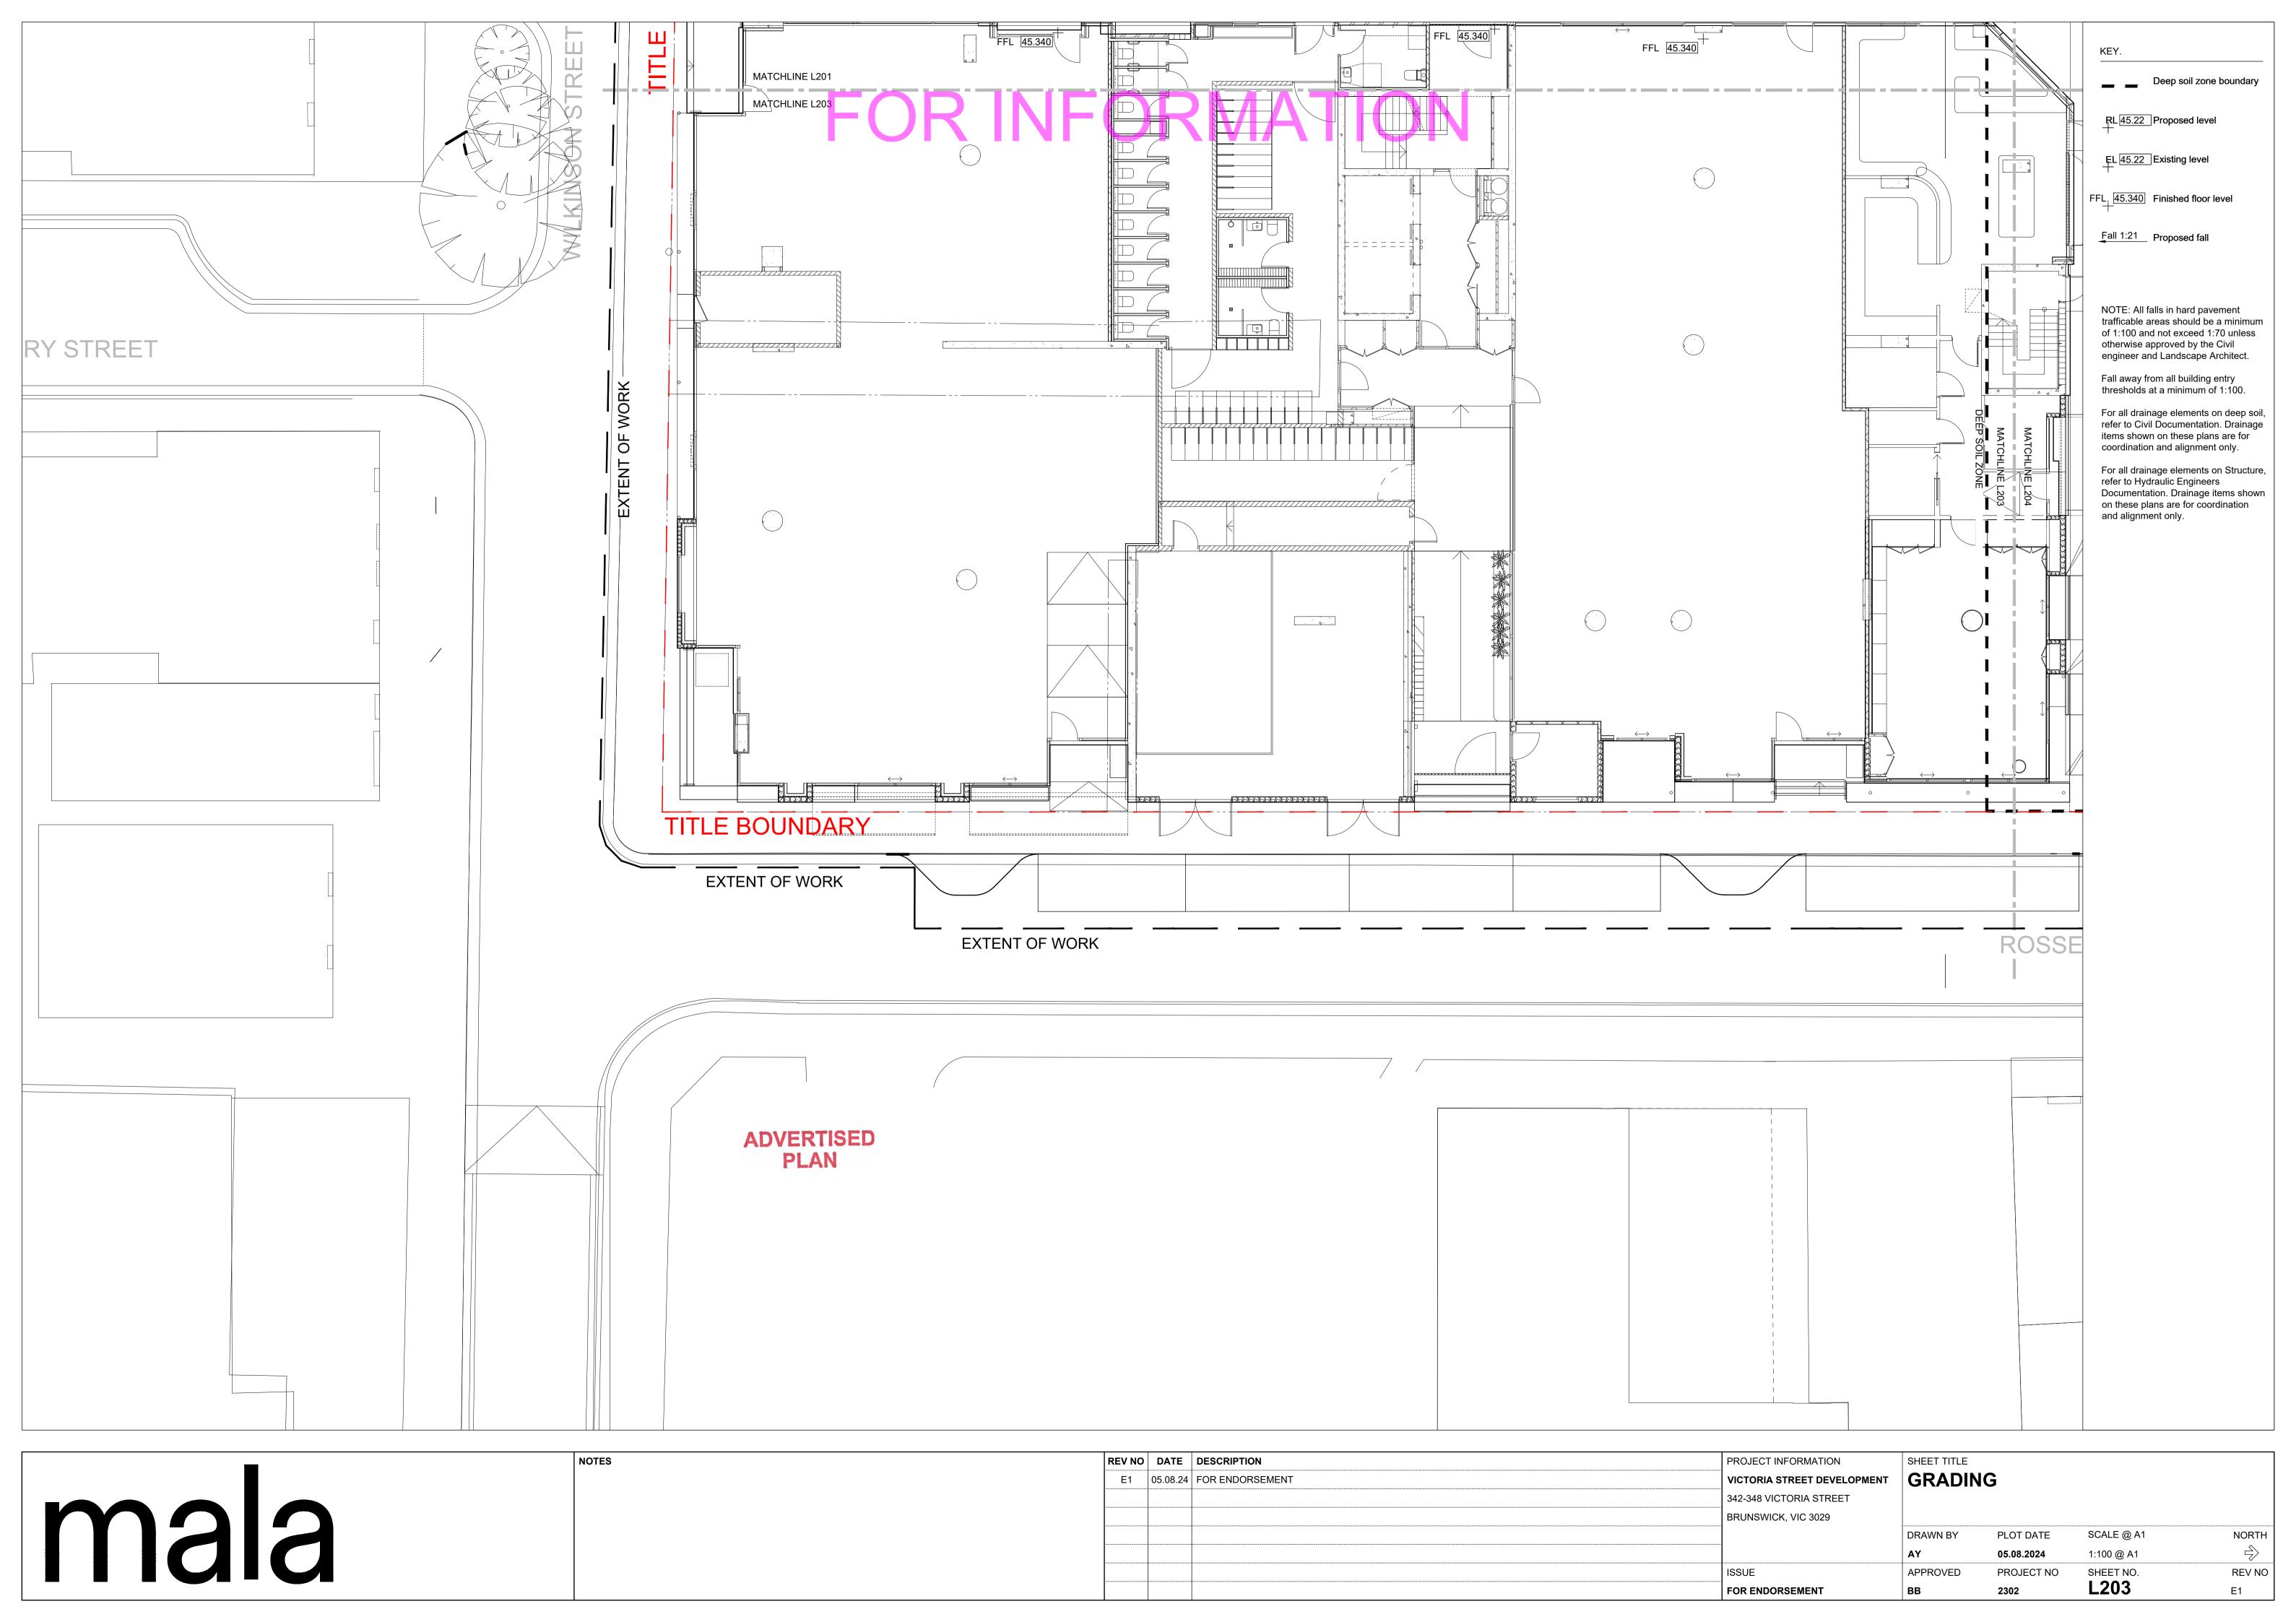


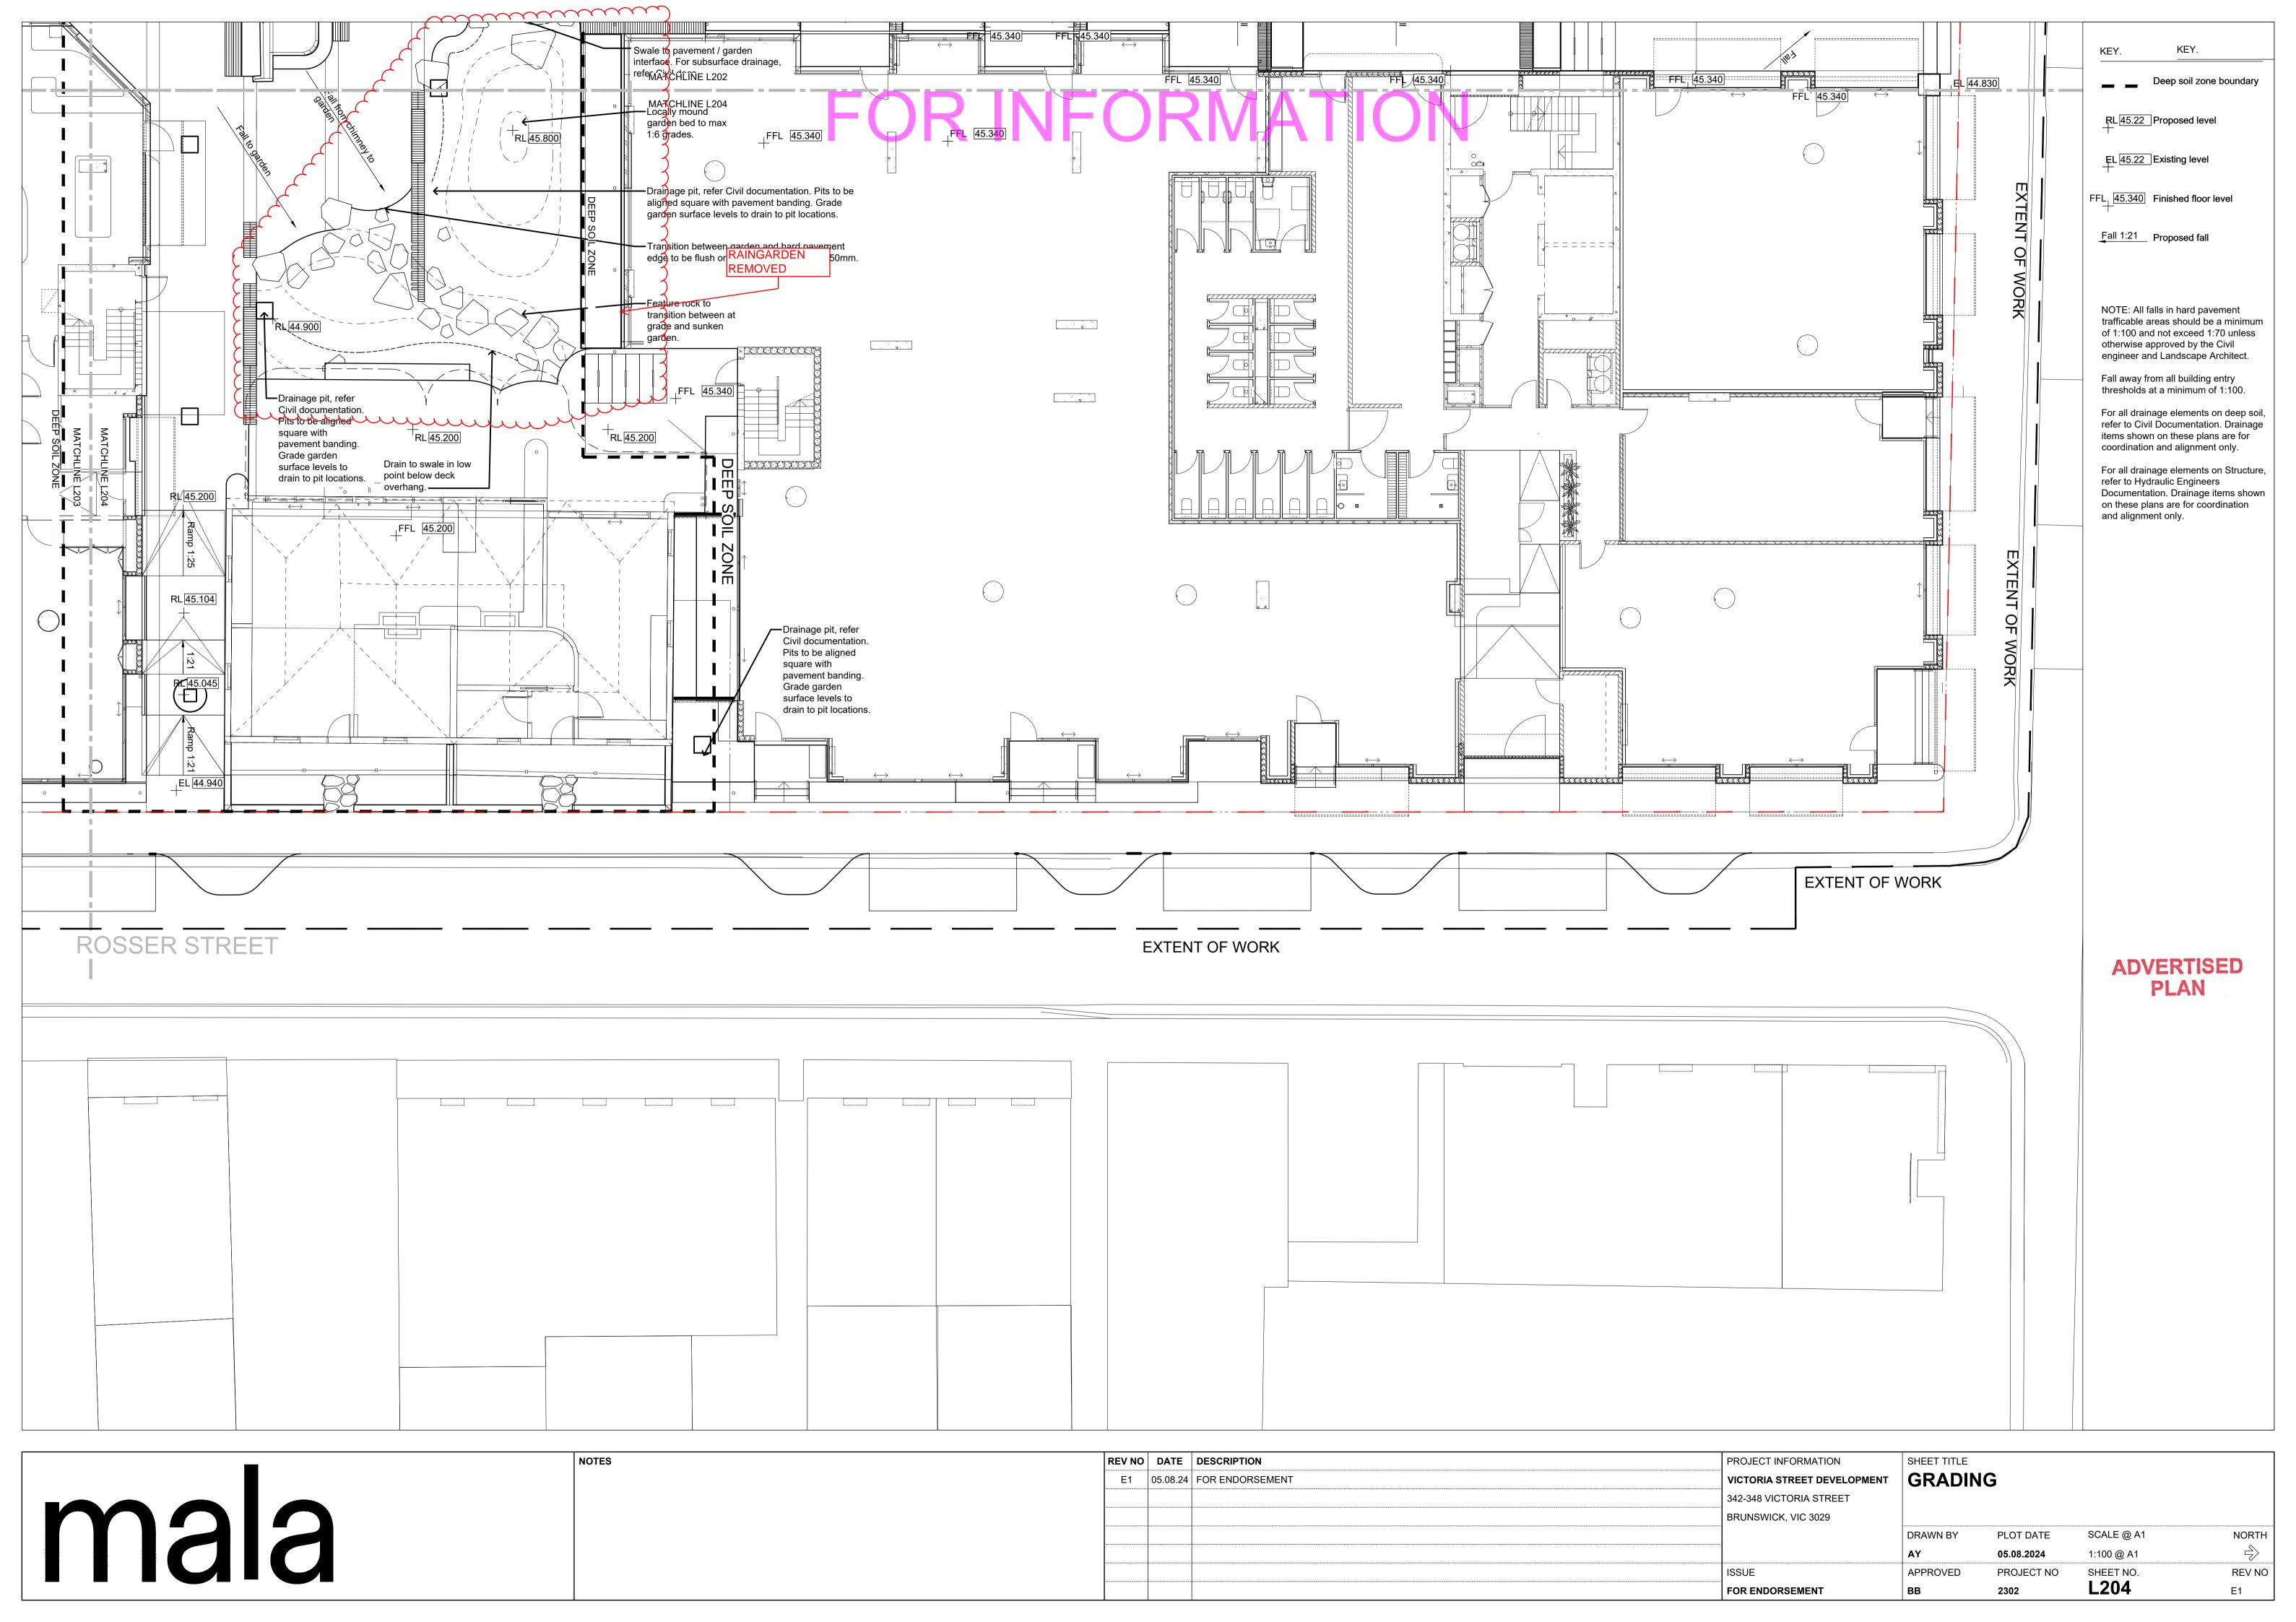

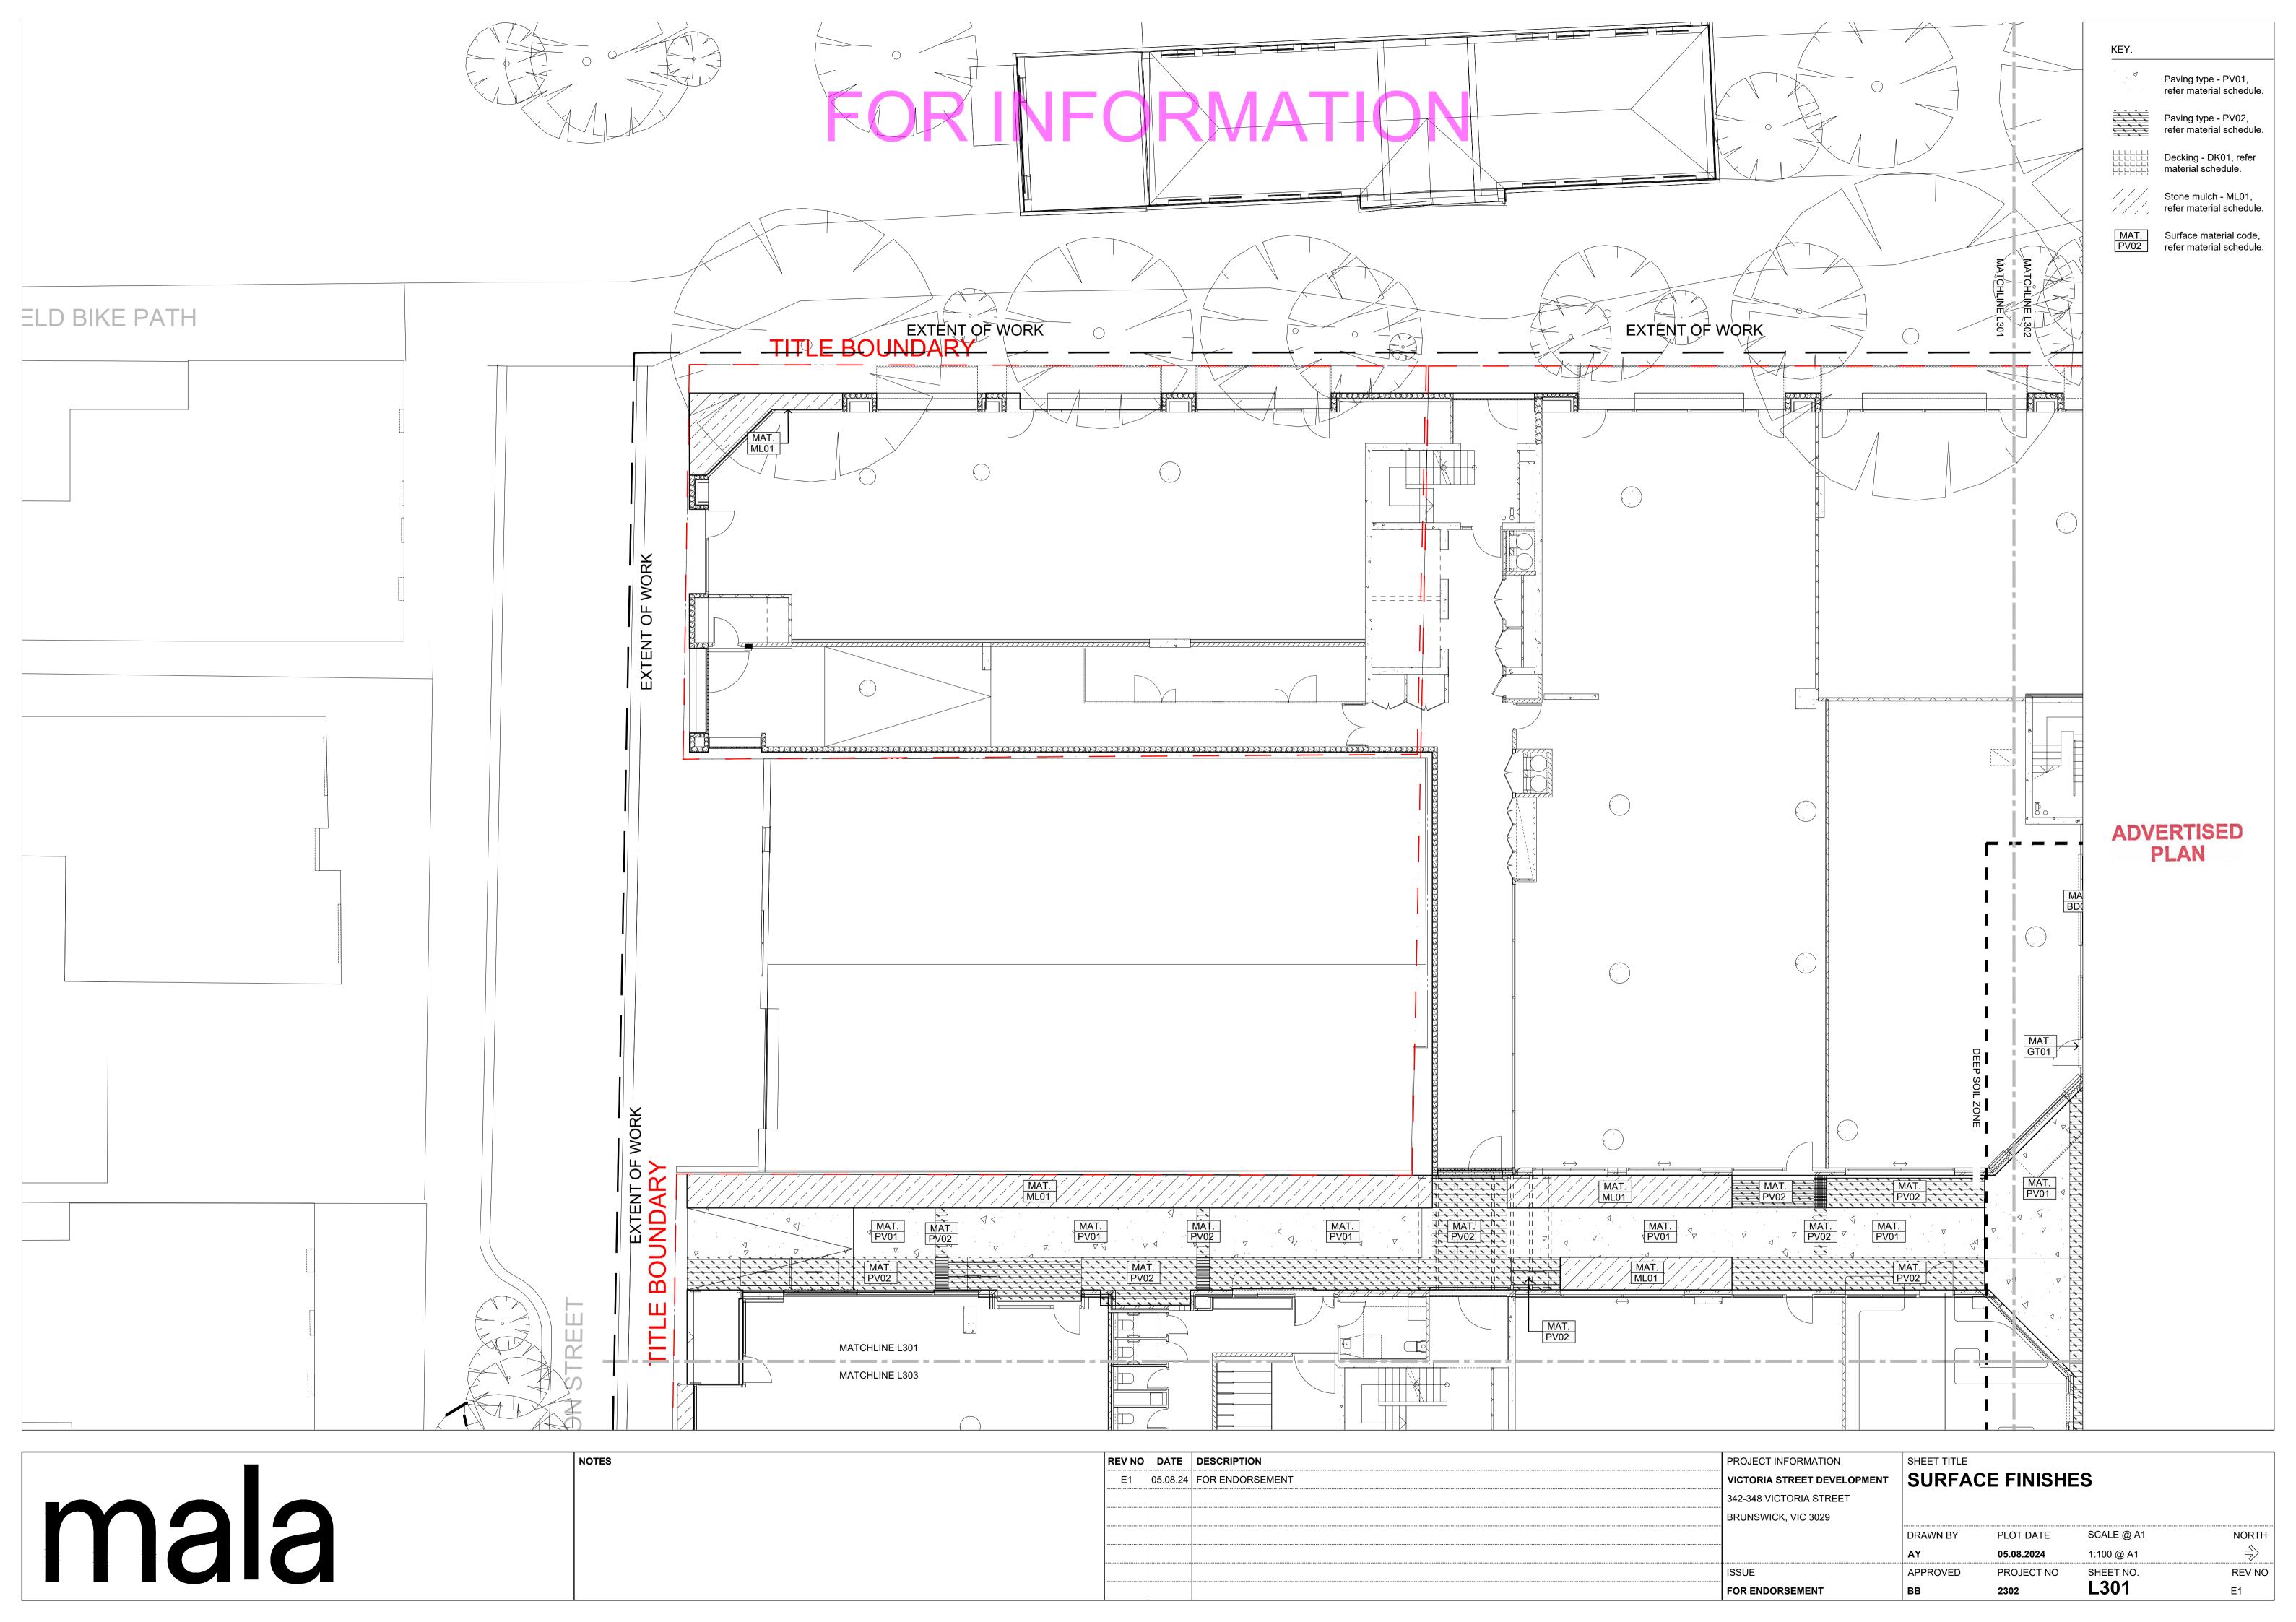

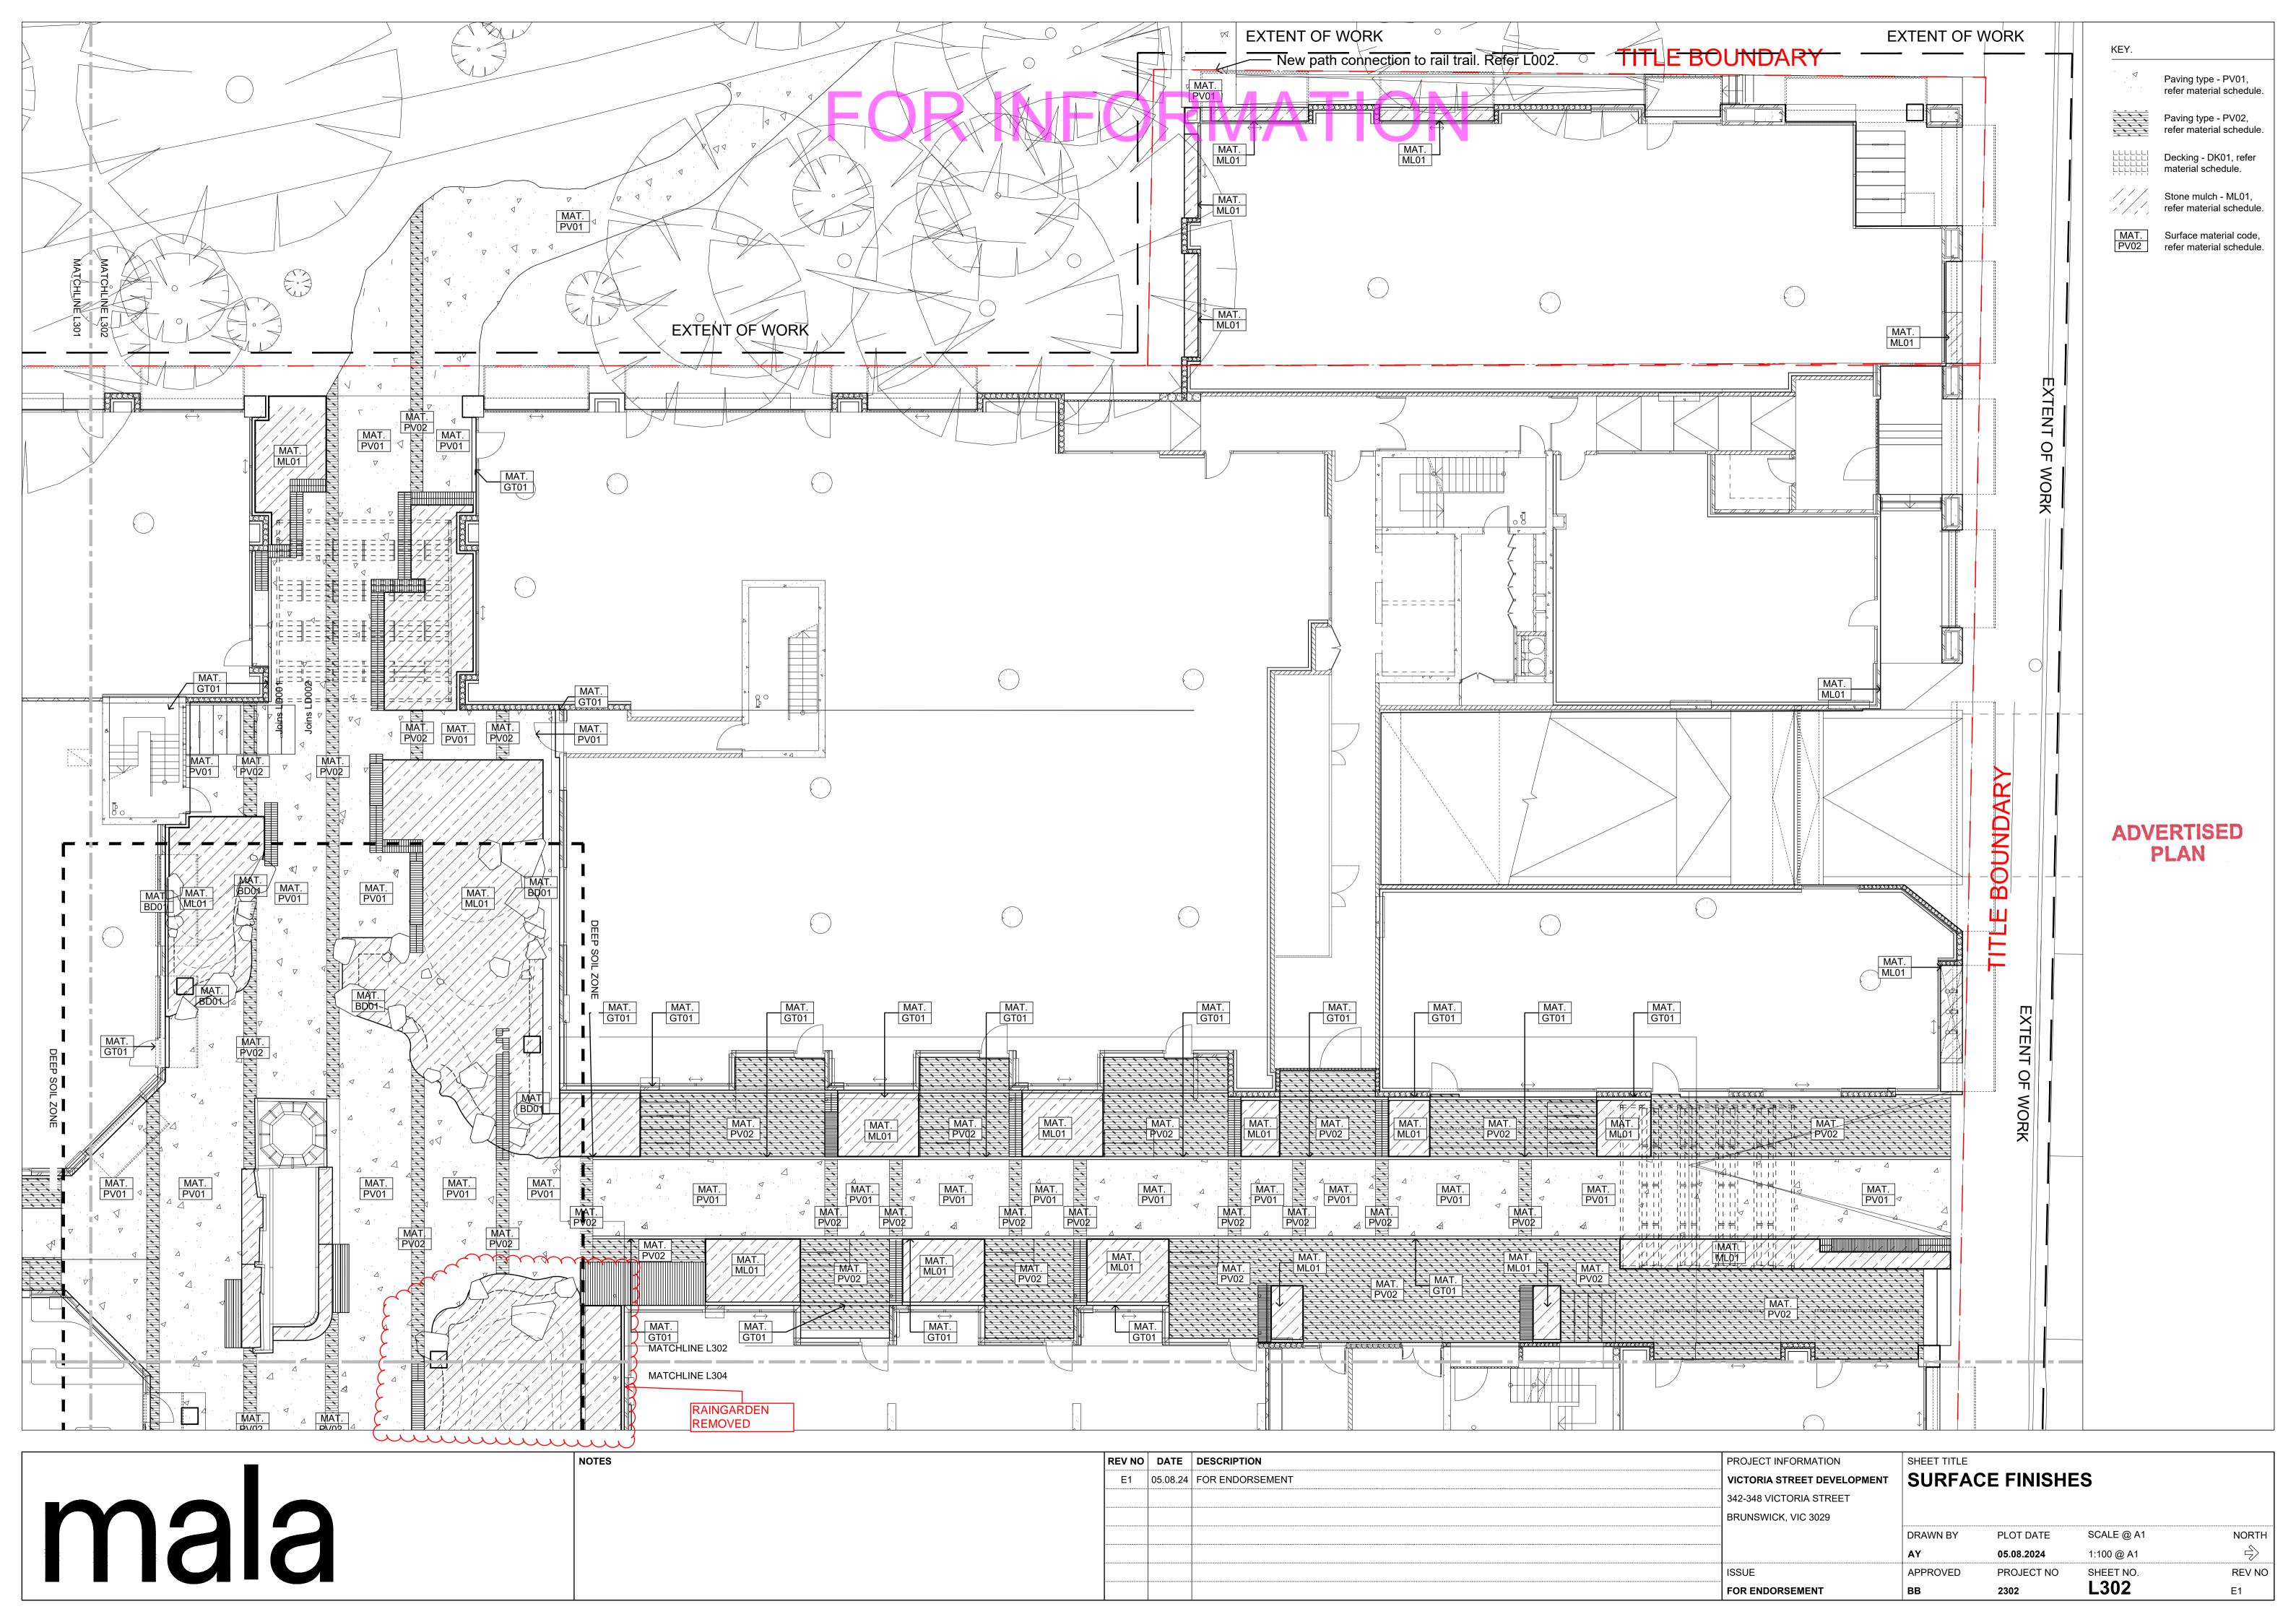

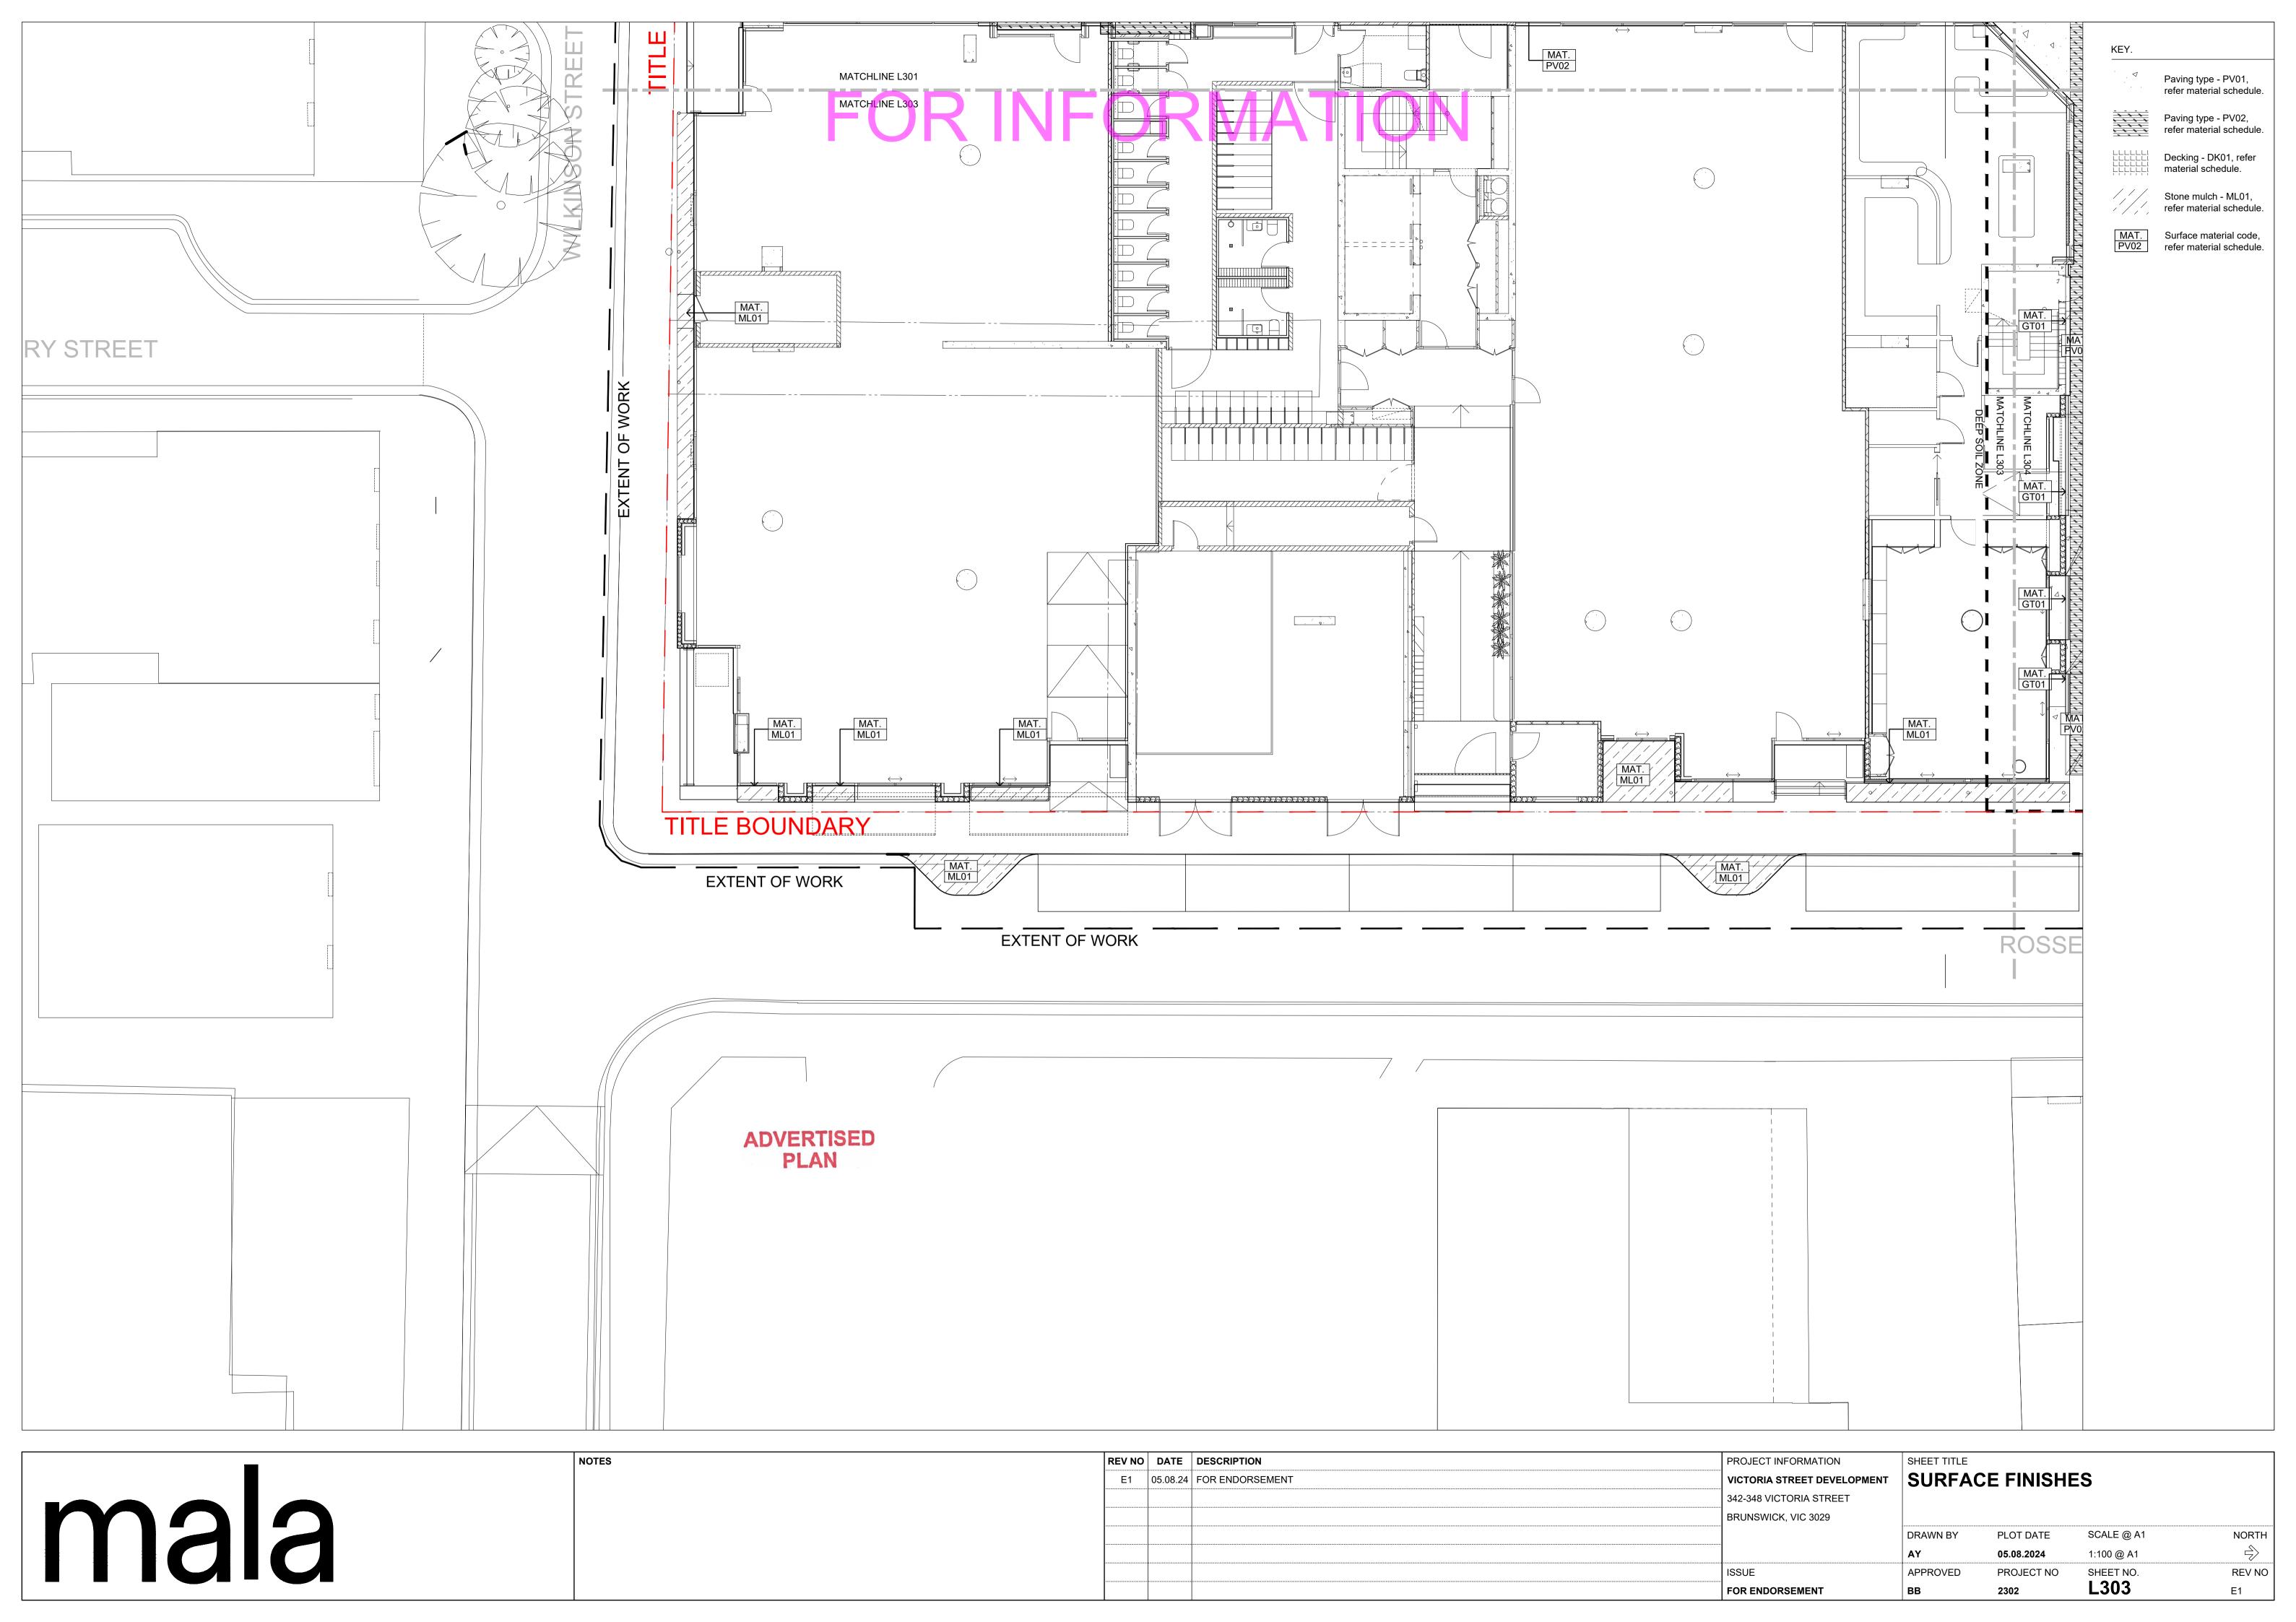

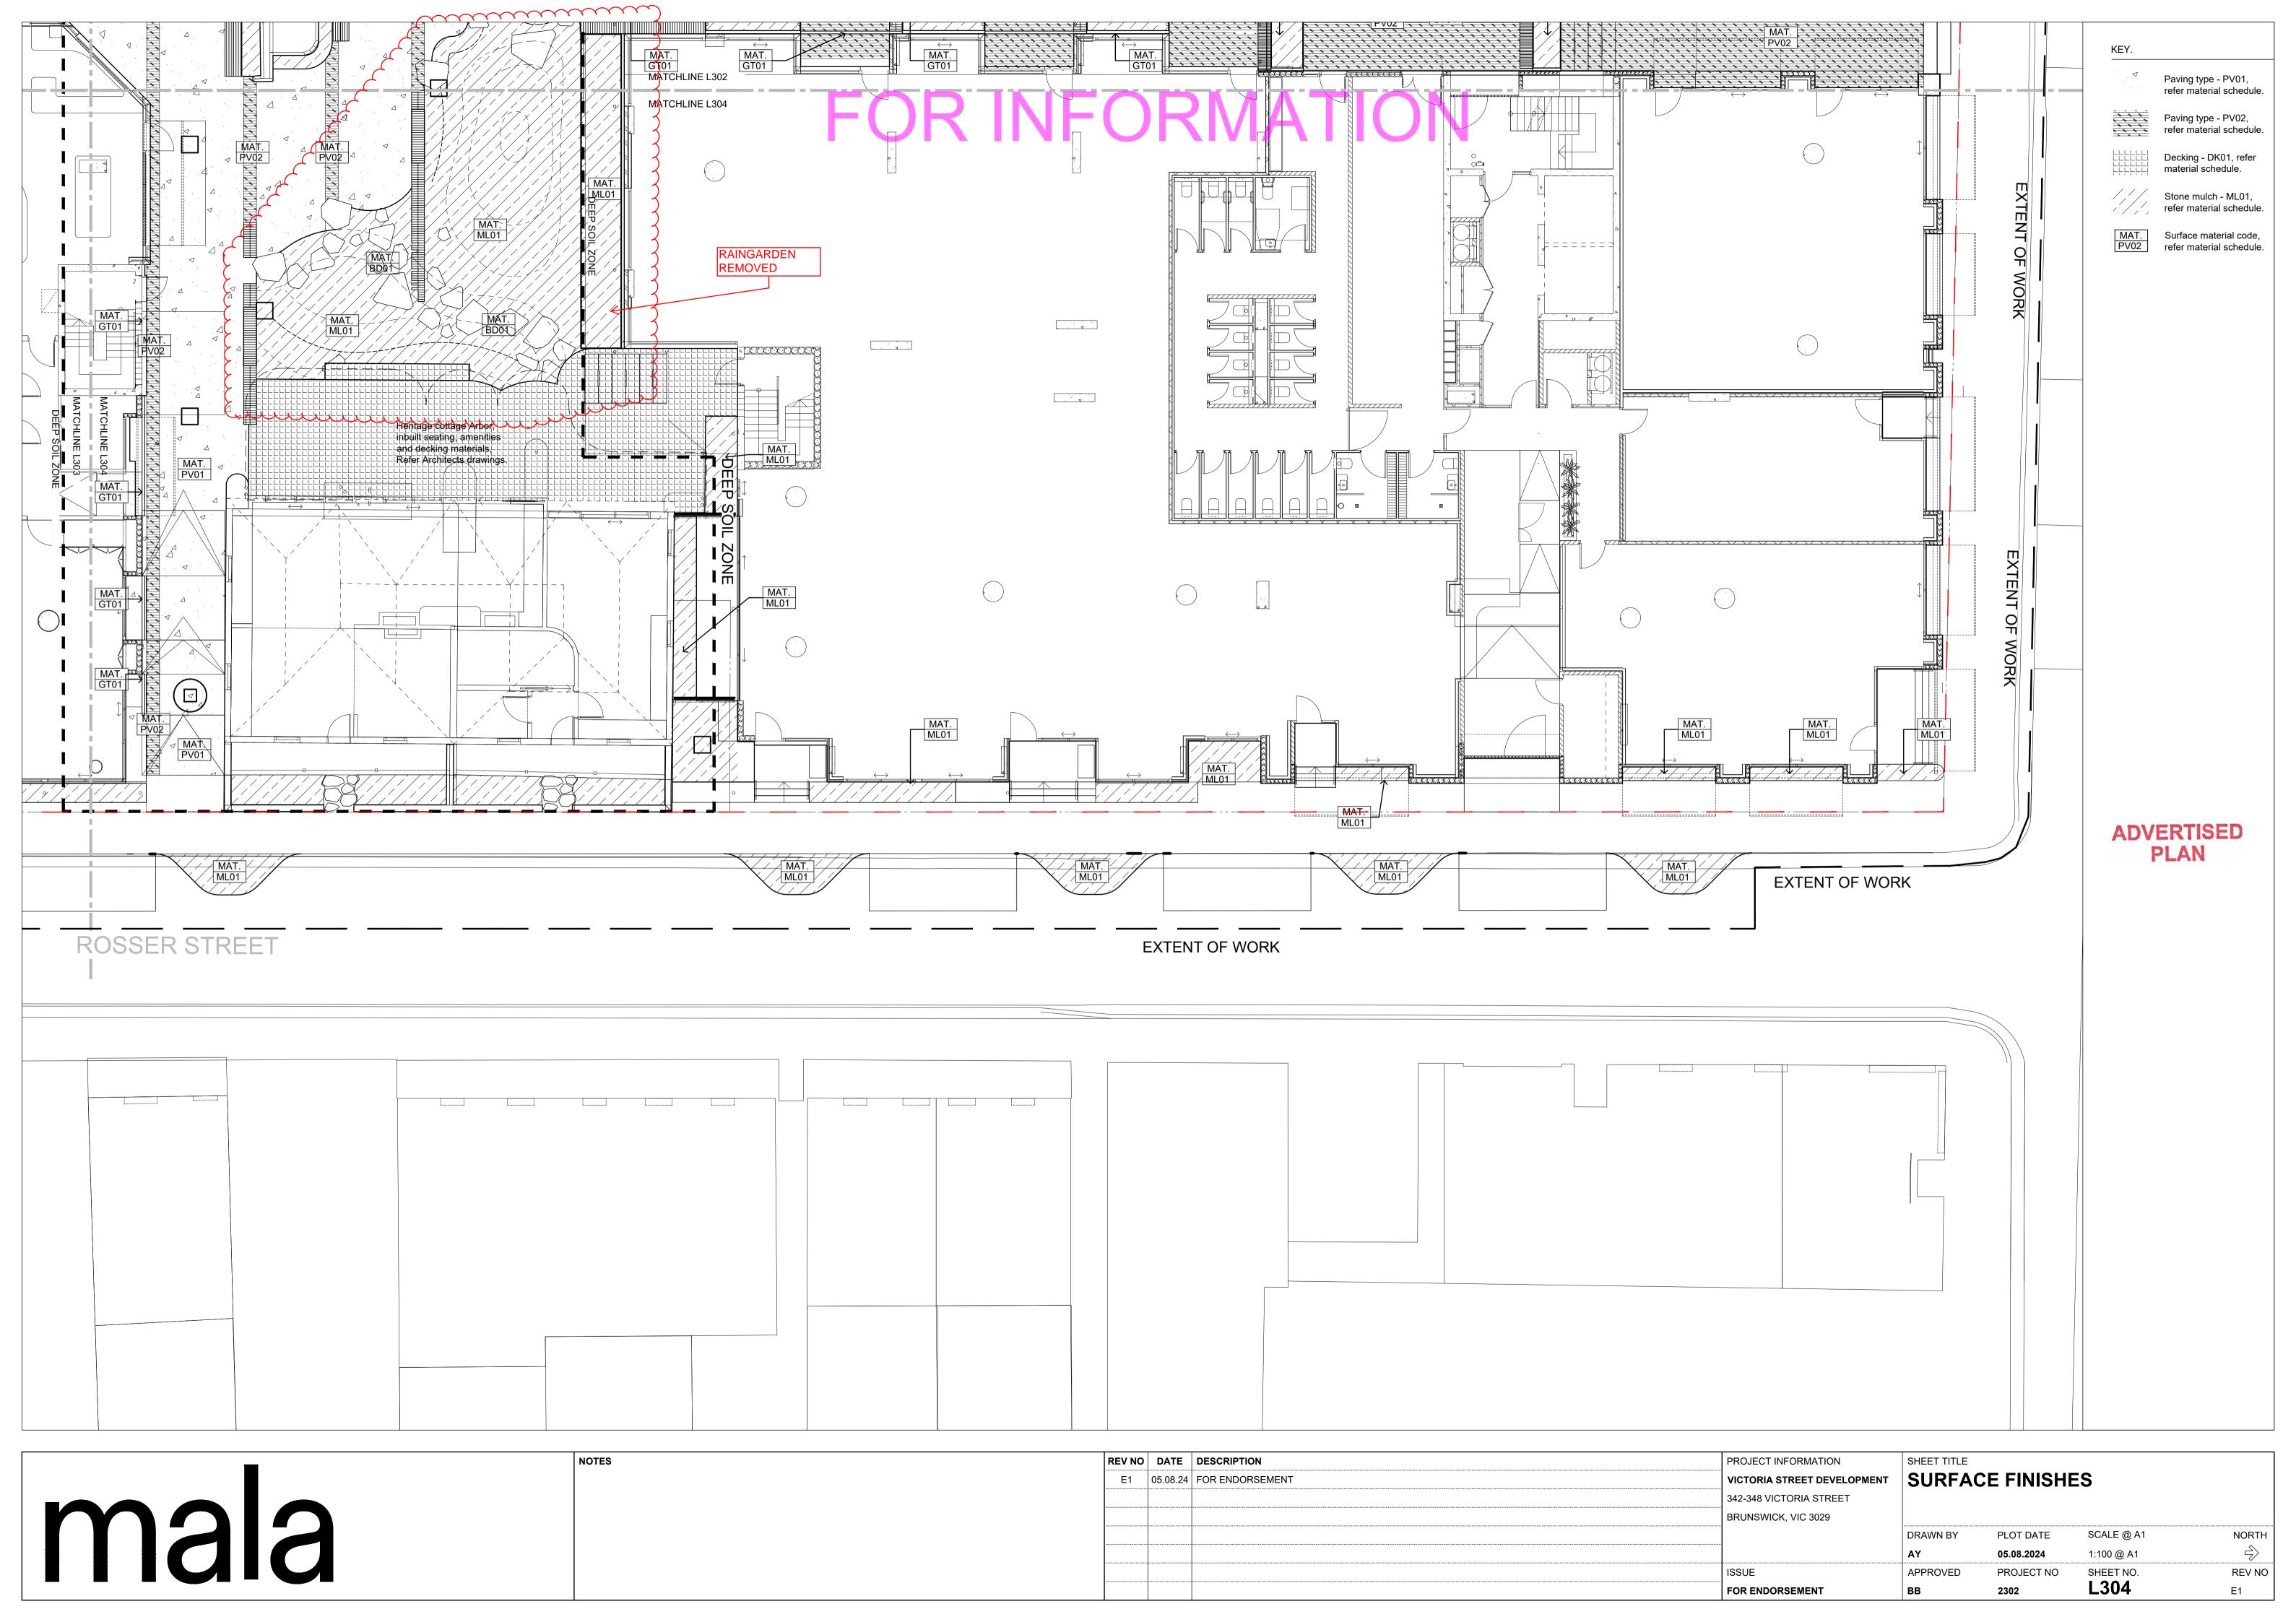

PLANTING SCHEDULE

Northern Lane

Pal	lette

		SIZE AT		
		MATURITY		
BOTANICAL NAME	COMMON NAME	HxW (m)	POT SIZE (install)	DENSITY

15 x 5

40L

As Shown

QLD Bottle Tree

Brachychiton rupestris

Low/ Meduim planting				
Dichondra argenea	Silver falls	0.1 x 0.8	140mm	6 p/sqm
Banksia blechnifolia	Ground cover banksia	0.5 x 2-4	140mm	6 p/sqm
Maireana sedifolia	Blue Bush	1 x 1	140mm	4 p/sqm
Osteospermum sp.	African daisies	0.25 x 0.5	140mm	6 p/sqm
Alyxia buxifolia	Sea Box	0.5 x 0.5	140mm	4 p/sqm
Doryanthes excelsa	Gymea Lily	1.5 x 1.5	140mm	1 p/sqm
Lotus berthelotii	Parrot-beak	0.2 x 0.6	140mm	6 p/sqm

Climbers

Wisteria	floribunda	Japanese Wisteria	n/a	200mm	As Shown
Pandore	a pandorana	Wonga Wonga Vine	n/a	200mm	As Shown

Southern Lane

Pallette

		MATURITY		
BOTANICAL NAME	COMMON NAME	HxW (m)	POT SIZE (install)	DENSITY
Lave / Billa desires estambles				
Low/ Meduim planting				
Asplenium scolopendrium	Hearts tongue fern	0.5 x 0.5	140mm	6 p/sqm
Asparagus densiflorus				
/a a	1		1	

SIZE AT

Asplenium scolopendrium	Hearts tongue fern	0.5 x 0.5	140mm	6 p/sqm
Asparagus densiflorus				
'Myersii'	Foxtail Fern	0.6 x 0.6	140mm	6 p/sqm
Thaumatophyllum xanadu	Filodendro Xanadu	1 x 1	140mm	6 p/sqm
Alcantarea imperialis	bromeliad	1 x 1	140mm	6 p/sqm
Vinca minor alba	Creeping Myrtle	0.5 x 1.5	140mm	6 p/sqm
Zamia furfuracea	Cardboard Palm	0.5 x 1	140mm	4 p/sqm
Dichondra repens	Kidney weed	0.1 x 1	140mm	6 p/sqm

Climbers

Schizophragma	Japanese Hydrangea			
hydrangeoides	Vine	n/a	200mm	As Shown
monstera deliciosa		n/a	200mm	As Shown

Central Garden

Pallette

		SIZE AT		
		MATURITY		
BOTANICAL NAME	COMMON NAME	HxW (m)	POT SIZE (install)	DENSITY

Toona ciliata	Australian Red Cedar	25+ x 12+	40L	As Shown
Tristaniopsis laurina			40L or 100L (for	
Lushious	Water gum	7 – 12m x 6m	street trees)	As Shown
Fraxinus pennsylvanica	Urbdell' Urbanite	11 x 8	40L	As Shown

Low/ Meduim planting

Bird's nest fern	1 x 1	140mm	1 p/sqm
lacy tree fern	3 x 2	140mm	1 p/sqm
Silver falls	0.1 x 0.8	140mm	6 p/sqm
Kidney weed	0.1 x 1	140mm	6 p/sqm
cunjevoi	1 x 1	140mm	2 p/sqm
Common Rasp Fern	0.5 x 0.5	140mm	6 p/sqm
Cardboard Palm	0.5 x 1	140mm	4 p/sqm
	lacy tree fern Silver falls Kidney weed cunjevoi Common Rasp Fern	lacy tree fern 3 x 2 Silver falls 0.1 x 0.8 Kidney weed 0.1 x 1 cunjevoi 1 x 1 Common Rasp Fern 0.5 x 0.5	lacy tree fern 3 x 2 140mm Silver falls 0.1 x 0.8 140mm Kidney weed 0.1 x 1 140mm cunjevoi 1 x 1 140mm Common Rasp Fern 0.5 x 0.5 140mm

Cillibers				
Hardenbergia violaceae	Purple Coral Pea	n/a	200mm	As Shown
Schizophragma	Japanese Hydrangea			
hydrangeoides	Vine	n/a	200mm	As Shown
Cissus antarctica	Kangaroo Vine	n/a	200mm	As Shown

Central Sunken

	INIC		
F U N	$\Pi \Lambda \Gamma$	Rooftop Garden	

Garden Pallette SIZE AT MATURITY POT SIZE (install) DENSITY **BOTANICAL NAME** COMMON NAME HxW (m)

Trees				
Toona ciliata	Australian Red Cedar	25+ x 12+	40L	As Shown
Tristaniopsis laurina			40L or 100L (for	
Lushious	Water gum	7 – 12m x 6m	street trees)	As Shown
Fraxinus pennsylvanica	Urbdell' Urbanite	11 x 8	40L	As Shown

Low/ Meduim planting

Crinum pedunculatum	Swamp lily	1 x 1	140mm	6 p/sqm
Dianella	Dianella Breeze	0.6 x 0.6	140mm	6 p/sqm
Dichondra repens	Kidney weed	0.1 x 1	140mm	6 p/sqm
Dianella tasmanica	Cherry red	1 x 1	140mm	6 p/sqm
Dianella	King alfred	0.7 x 0.7	140mm	6 p/sqm
Ficinia nodosa	Club rush	0.8 x 0.8	140mm	6 p/sqm
Centella asiatica	Asiatic pennywort	0.25 x 0.4	140mm	6 p/sqm

GRC Planter

Pallette

		SIZE AT		
		MATURITY		
BOTANICAL NAME	COMMON NAME	HxW (m)	POT SIZE (install)	DENSITY
Low/ Meduim planting				
Grevillea juniperina	'Gold Cluster'	0.4 x 1.5	140mm	6 p/sqm
Dichondra argenea	Silver falls	0.1 x 0.8	140mm	6 p/sqm
Rosmarinus officinalis	'Prostrate' Rosemary	0.5 x 1	140mm	6 p/sqm
Lotus berthelotii	Parrot-beak	0.2 x 0.6	140mm	6 p/sqm
Rhapiolepis	Snow maiden	1 x 1	140mm	6 p/sqm
Casuarina 'Cousin It'	Cousin It	0.25 x 1	140mm	6 p/sqm

As Shown
As Shown
As Shown
-

Roof Profile

Pallette

NOTES

		SIZE AT MATURITY		
BOTANICAL NAME	COMMON NAME	HxW (m)	POT SIZE (install)	DENSITY
Low/ Meduim planting				
Aptenia cordifolia	Baby Sun Rose	0.15 x 0.6	140mm	6 p/sqm
Carpobrotus glaucescens	Pigface	0.1 x 1	140mm	6 p/sqm
Myoporum insulare	Ground Cover			
'Prostrate'	Boobialla	0.5 x 1	140mm	6 p/sqm
Myoporum parvifolium				
(broad leaf)	Creeping Boobialla	0.3 x 1	140mm	6 p/sqm
disphyma crassifolia	Creeping dew plant	0.2 x 1	140mm	6 p/sqm
Banksia blechnifolia	Ground cover banksia	0.5 x 2-4	140mm	6 p/sqm

Pallette

		MATURITY		
BOTANICAL NAME	COMMON NAME	HxW (m)	POT SIZE (install)	DENSITY
Low/ Meduim planting				
Banksia blechnifolia	Ground cover banksia	0.5 x 2-4	140mm	6 p/sqm
Dichondra argenea	Silver falls	0.1 x 0.8	140mm	6 p/sqm
Leucophyta brownii	Cushion bush	0.8 x 0.8	140mm	4 p/sqm
Senecio mandraliscae	blue chalksticks	0.2 x 1	140mm	6 p/sqm
Lomandra	Seascape	0.5 x 0.75	140mm	4 p/sqm
Dichondra argenea	Silver falls	0.1 x 0.8	140mm	6 p/sqm
Rosmarinus officinalis	'Prostrate' Rosemary	0.5 x 1	140mm	6 p/sqm
Casuarina 'Cousin It'	Cousin It	0.25 x 1	140mm	6 p/sqm
Doryanthes excelsa	Gymea Lily	1.5 x 1.5	140mm	1 p/sqm
Alyxia buxifolia	Sea Box	0.5 x 0.5	140mm	4 p/sqm

SIZE AT

Climbers

Cillibera				
Wisteria floribunda	Japanese Wisteria	n/a	200mm	As Shown
Hardenbergia violaceae	Purple Coral Pea	n/a	200mm	As Shown
Trachelospermum asiaticum	Japanese star jasmine	n/a	200mm	As Shown
Vitis vinifera	Ornimeltal Grape	n/a	200mm	As Shown

Cottage Garden

Pallette

		SIZE AT		
		MATURITY		
BOTANICAL NAME	COMMON NAME	HxW (m)	POT SIZE (install)	DENSITY

Low/ Meduim planting

LOW/ Wieduin planting				
Lomandra longifolia 'Tanika'	Mat Rush	0.5-0.6 x 0.65	140mm	As Shown
Lomandra confertifolia				
'Seascape'	Lomandra Seascape	0.5 x 0.75	140mm	As Shown
Dianella tasmanica	Tasman Flax-lily	0.6-1.5 x 0.5-2	140mm	As Shown

ADVERTISED PLAN

APPROVED

FOR ENDORSEMENT

PROJECT NO

SHEET NO. L400

REV NO

Estimated Canopy Cover

Trees at maturity

Species	Number proposed	Estimated canopy size at maturity (Diameter)	Total canopy area (m2)
Toona ciliata	1	12m	113
Tristaniopsis laurina			
Lushious	8	6m	224
Fraxinus pennsylvanica	3	8m	150
Brachychiton rupestris	8	5m	156
		Total tree	
		canopy	643

Arbor canopy at maturity


· · · · · · · · · · · · · · · · · · ·				
Arbor location	Arbor size (m2)			
Northern Arbor	37.14			
Western Arbor	42.24			
Southern Arbor	20.16			
Arbor Total	99.54			


Site ground plane canopy total (m2)


742.54





REV NO DATE DESCRIPTION PROJECT INFORMATION PLANTING SCHEDULES E1 05.08.24 FOR ENDORSEMENT VICTORIA STREET DEVELOPMENT 342-348 VICTORIA STREET BRUNSWICK, VIC 3029 SCALE @ A1 DRAWN BY PLOT DATE 05.08.2024

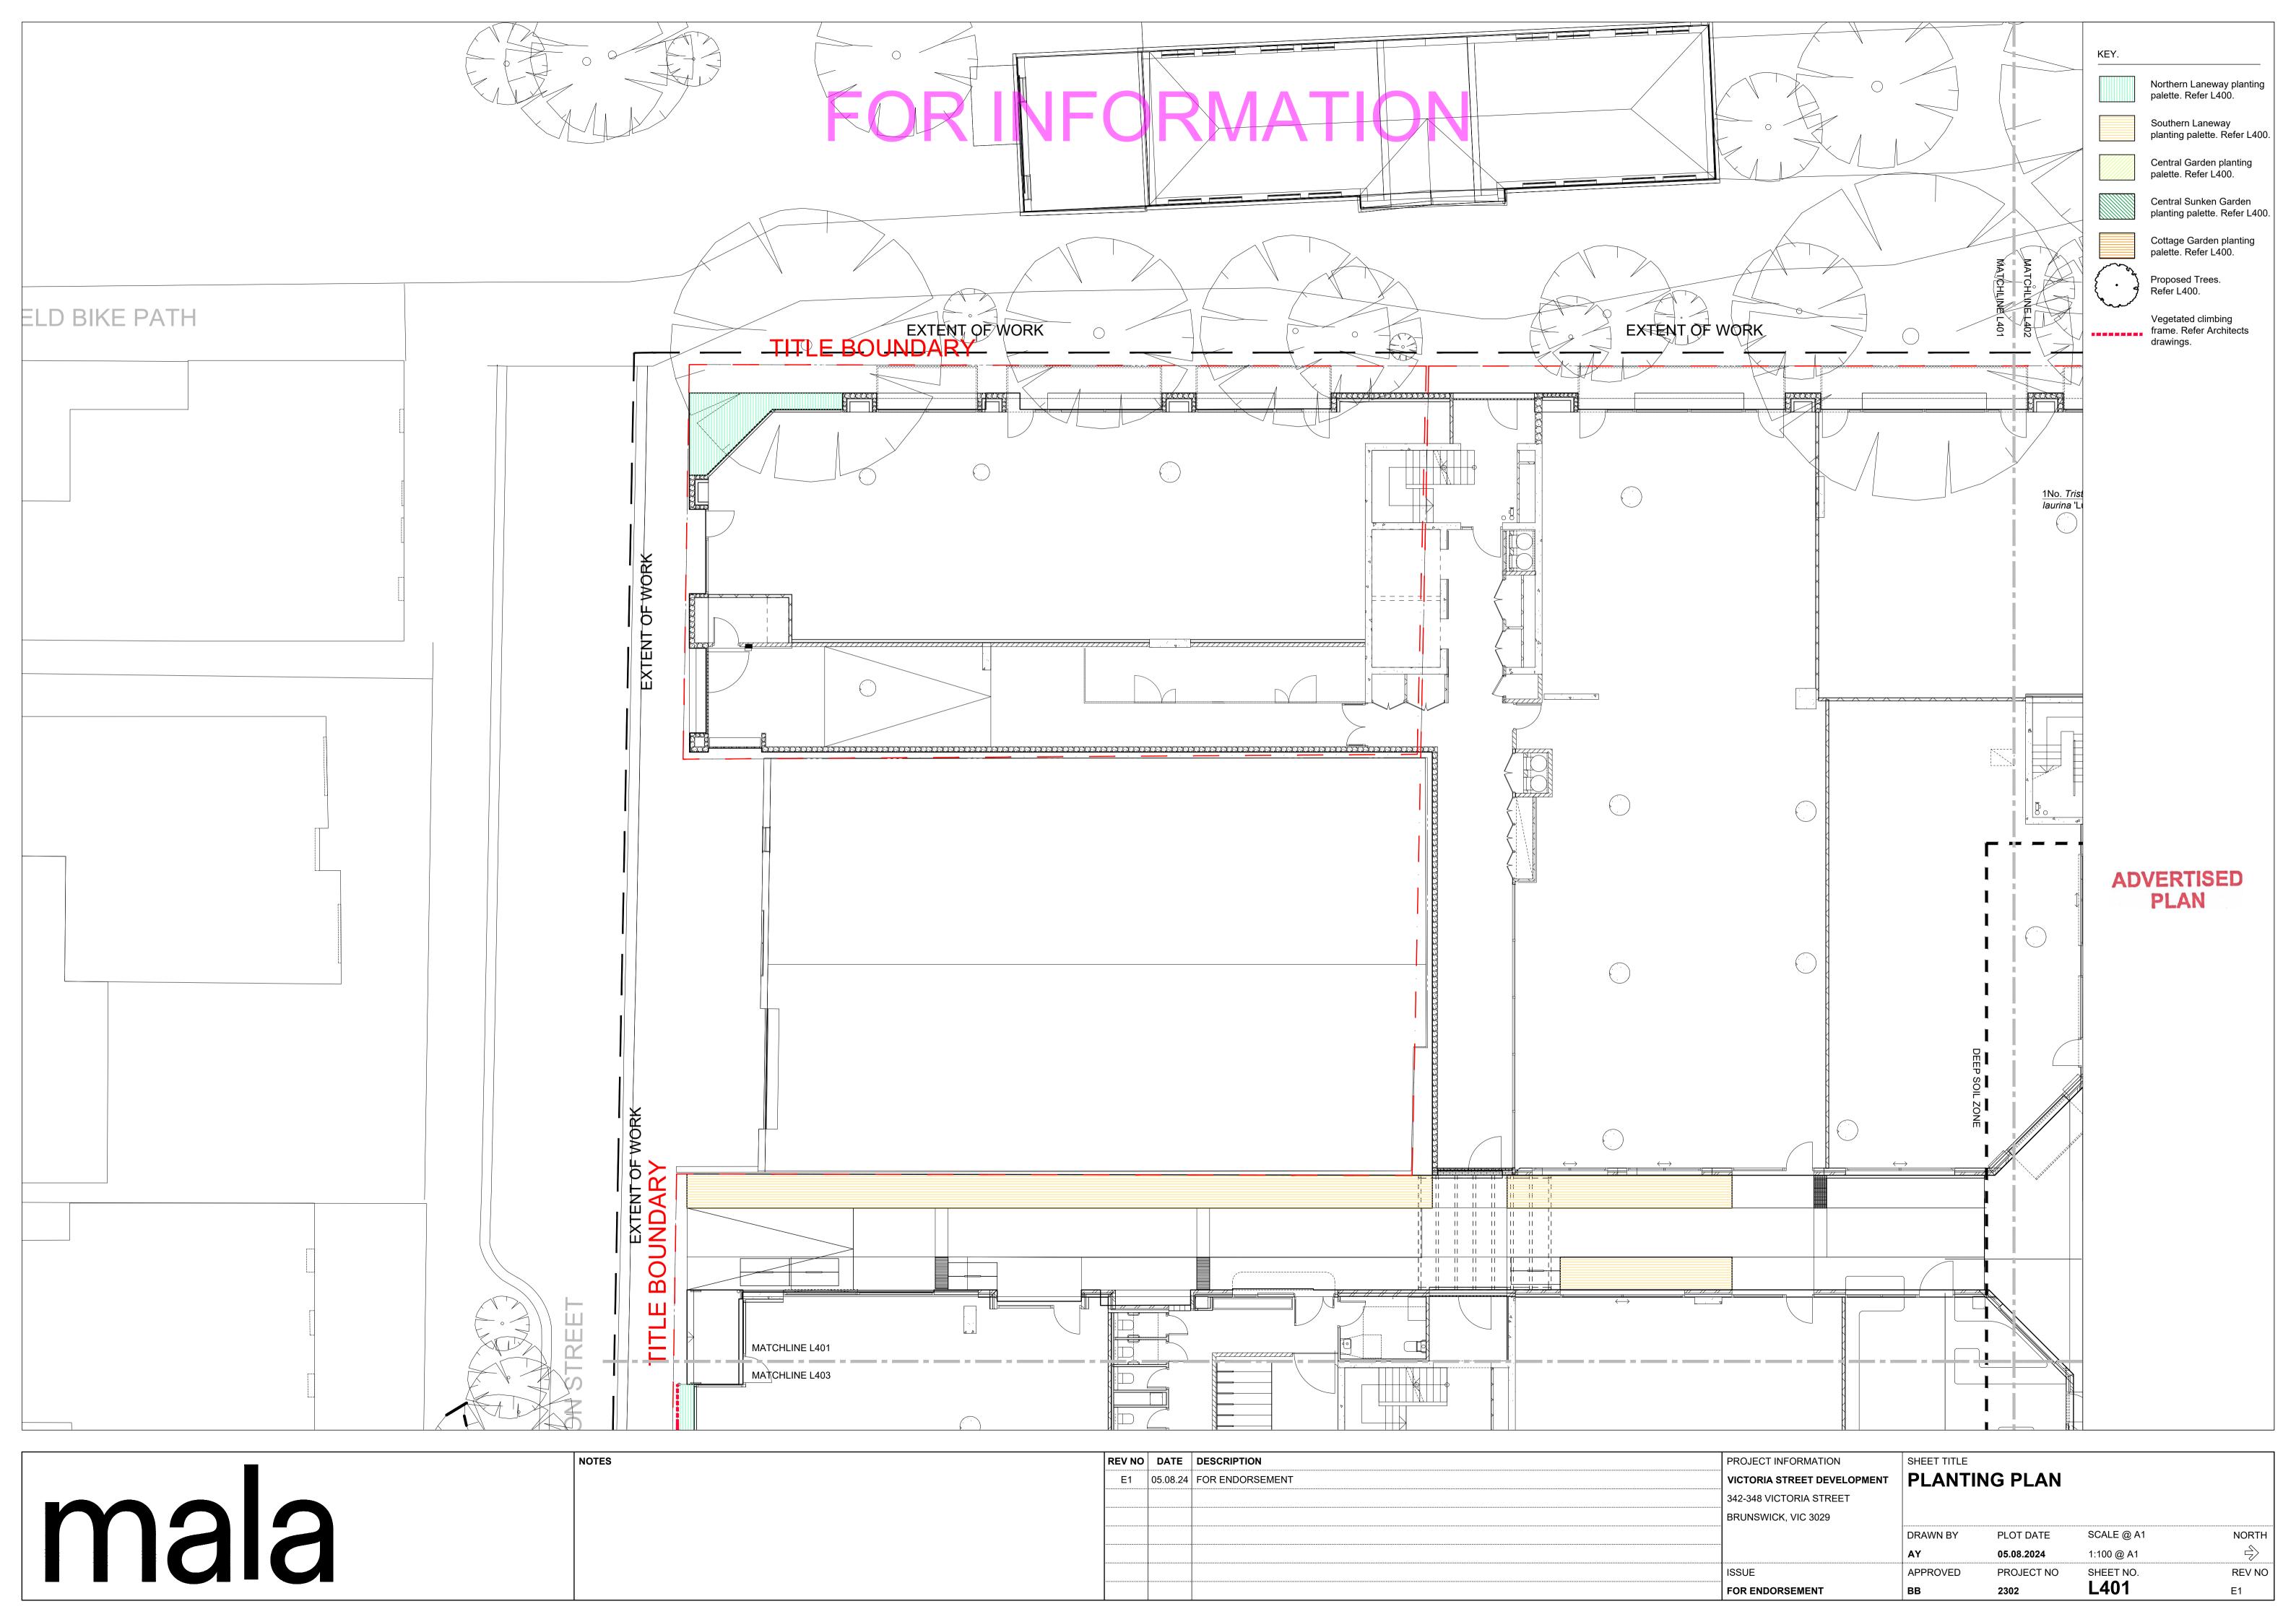

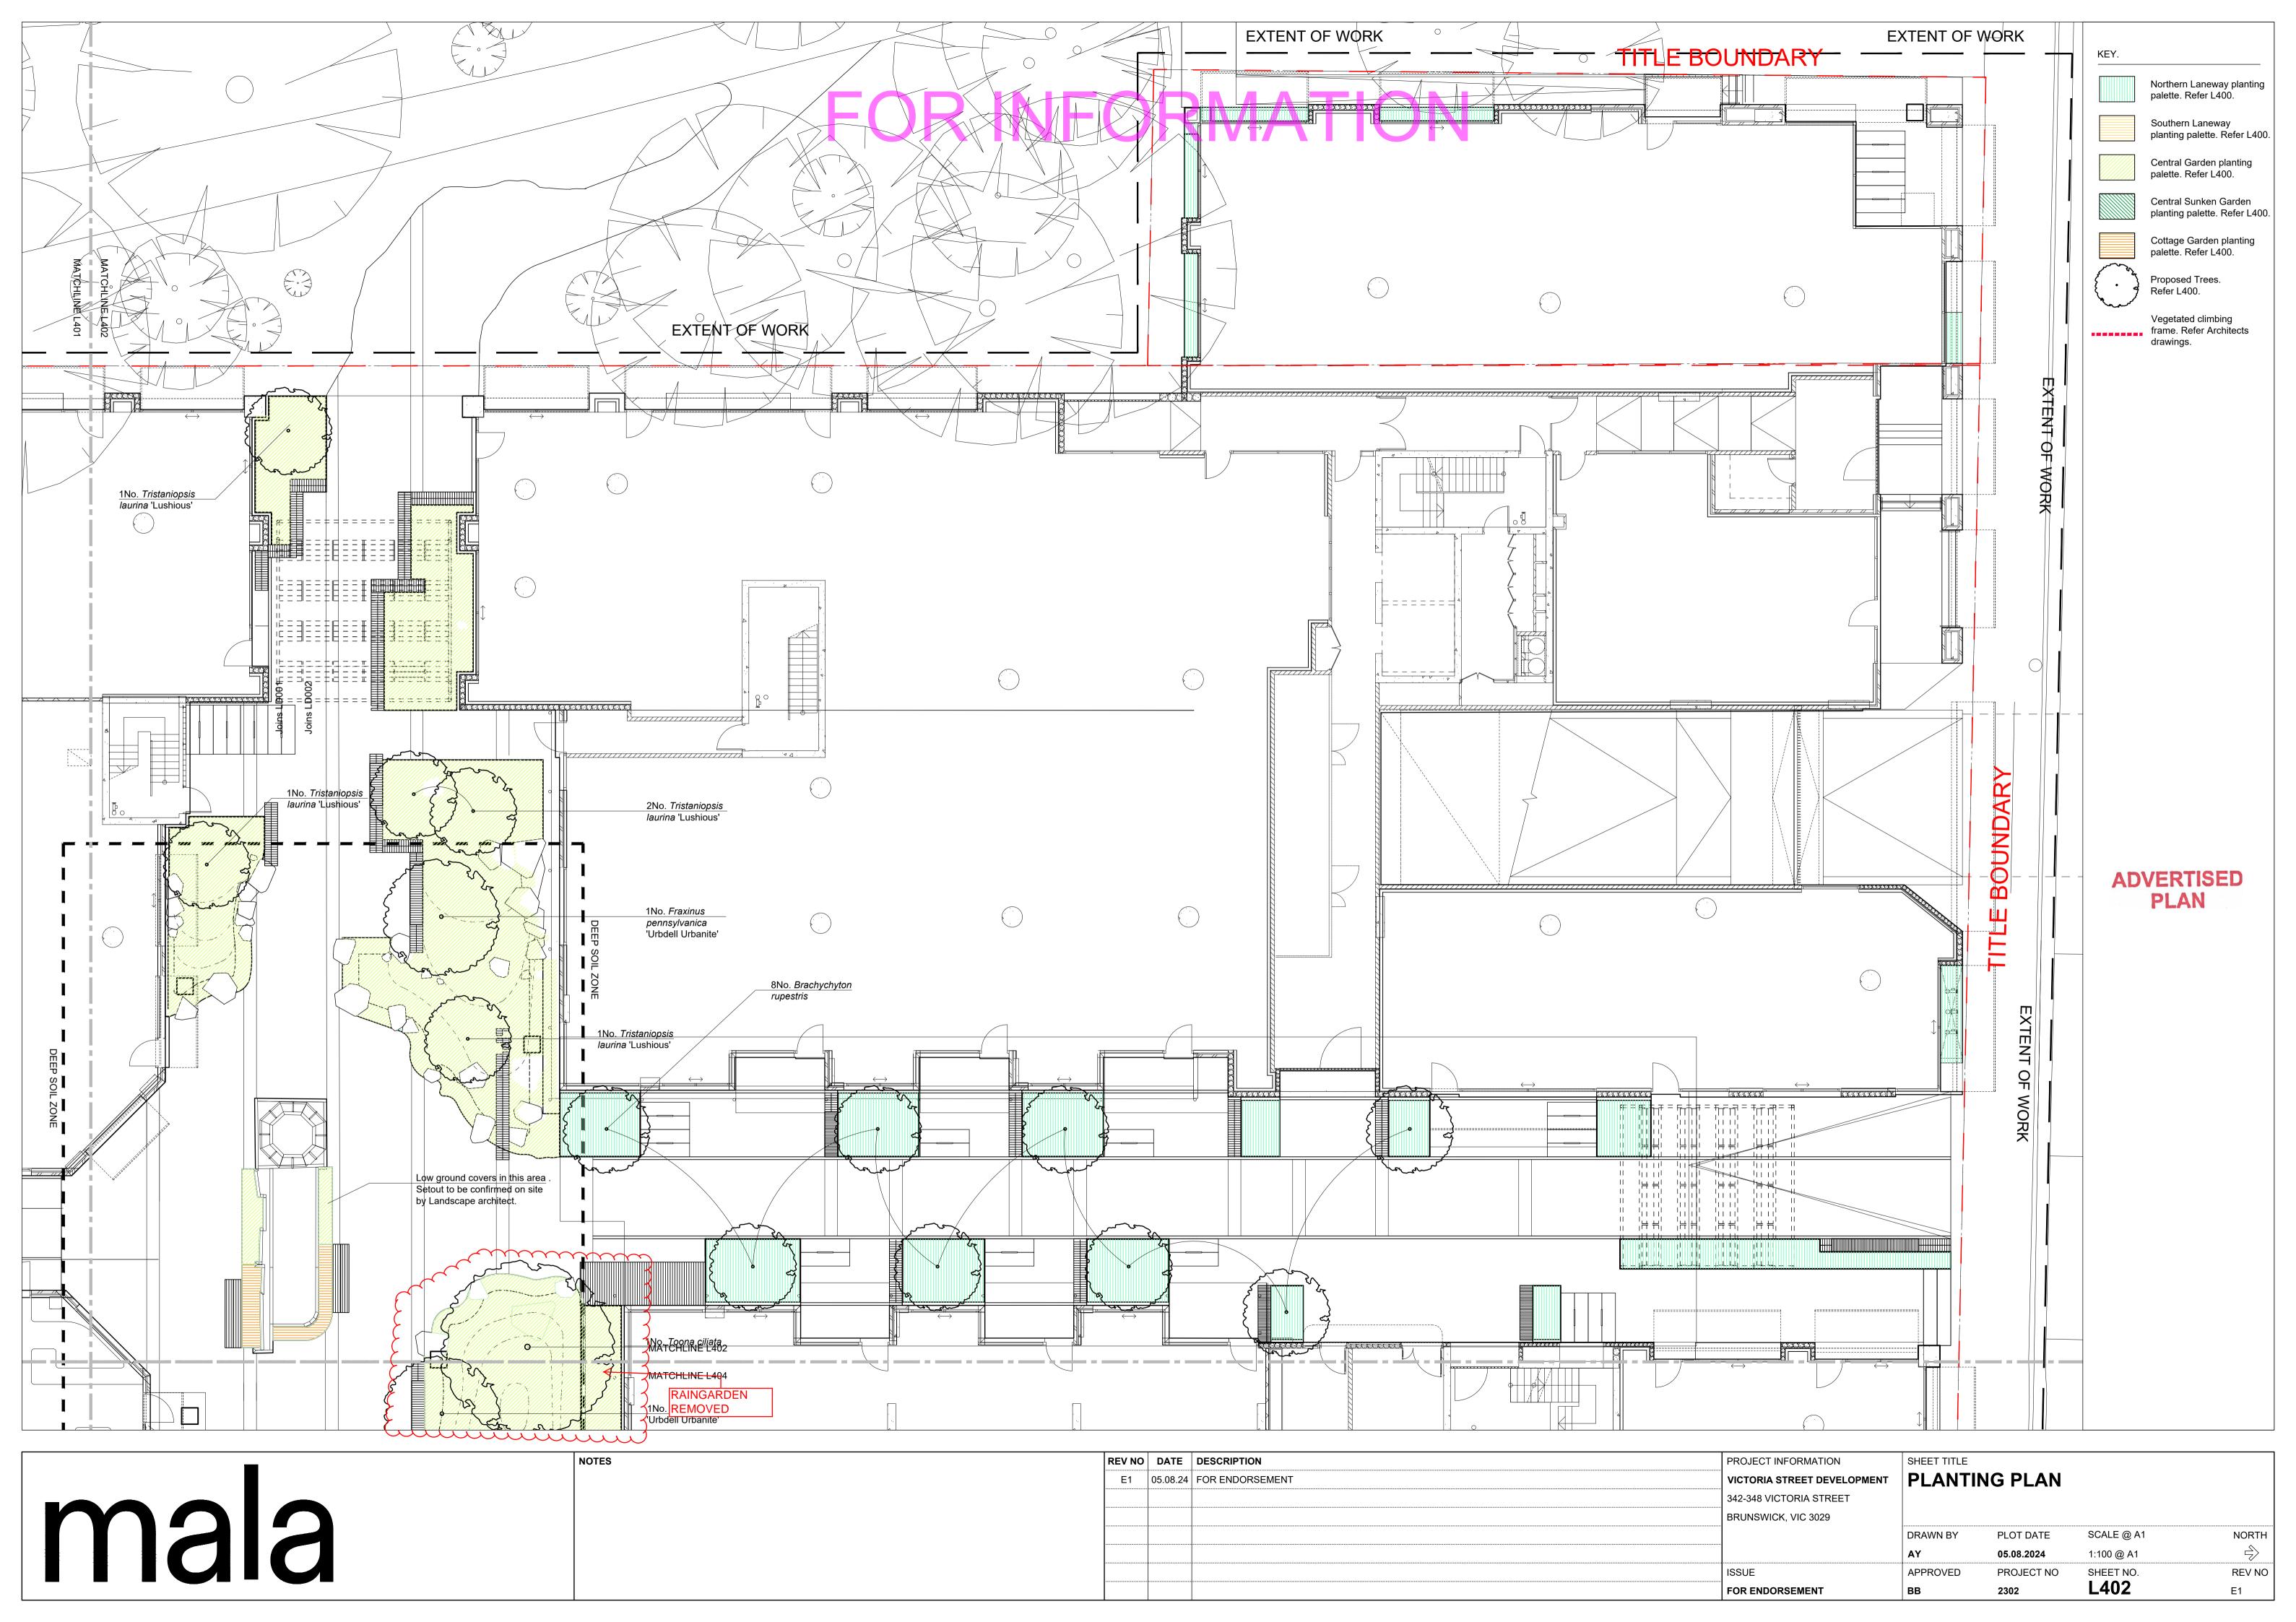


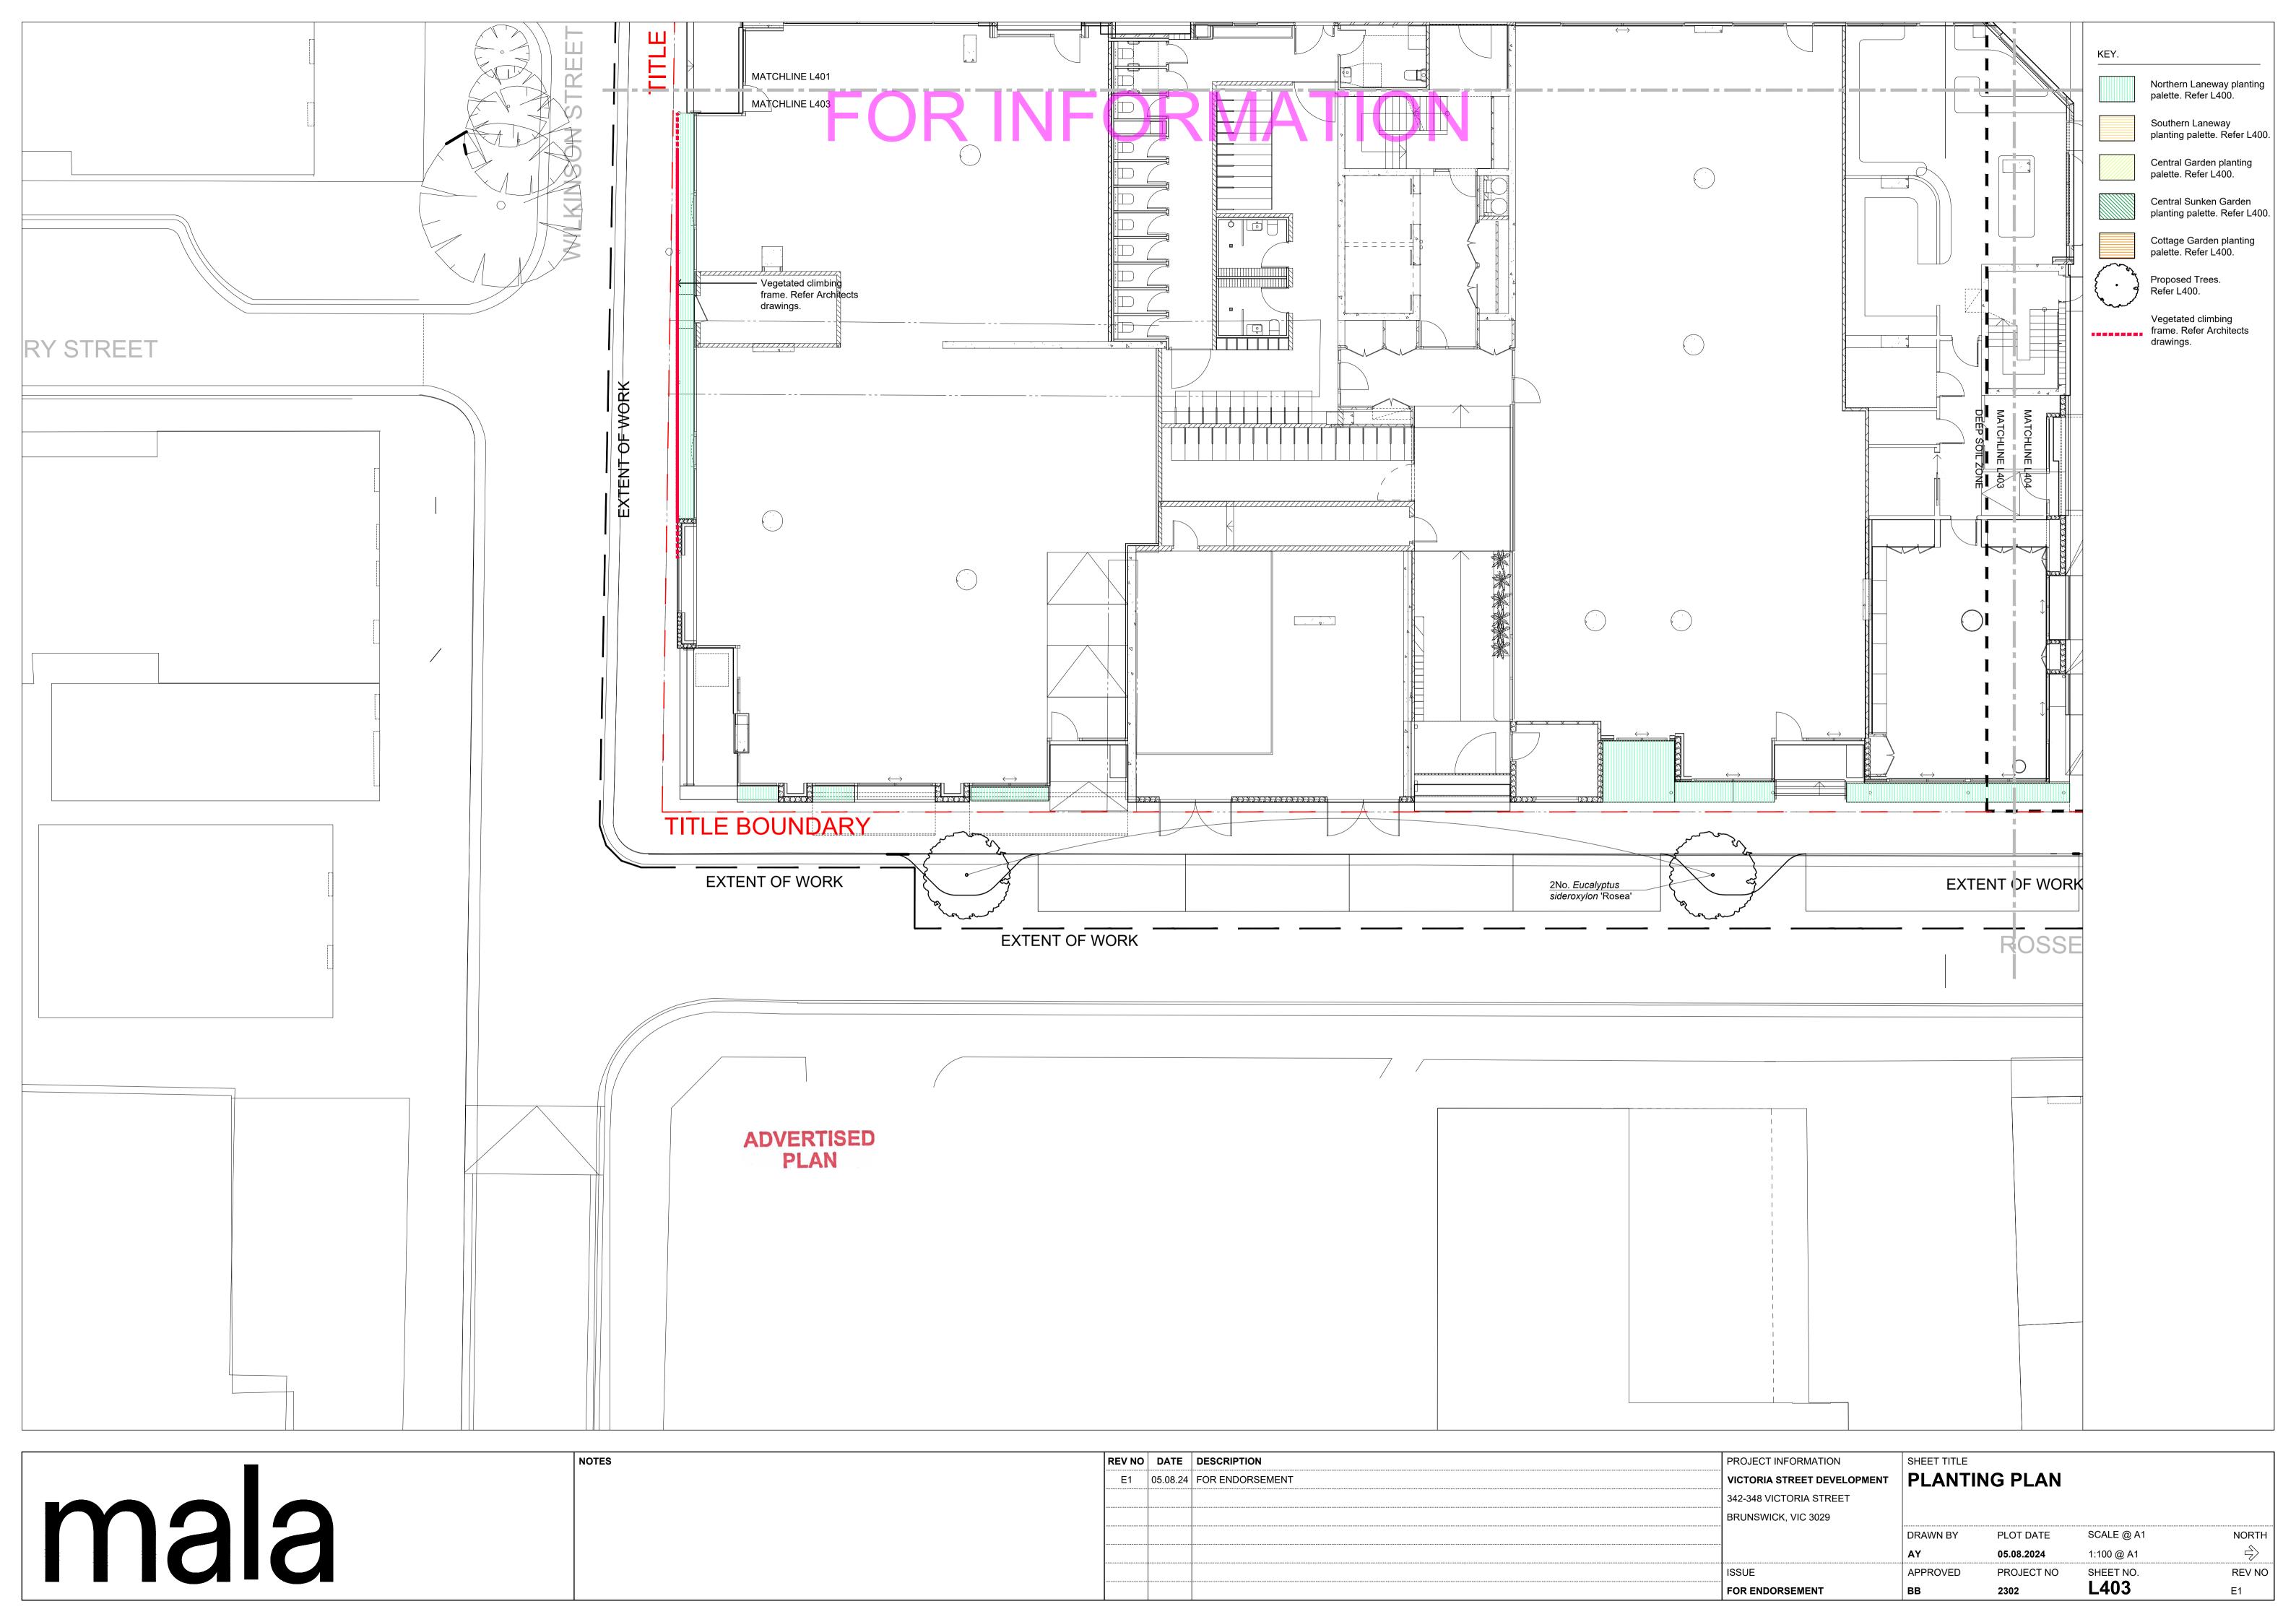

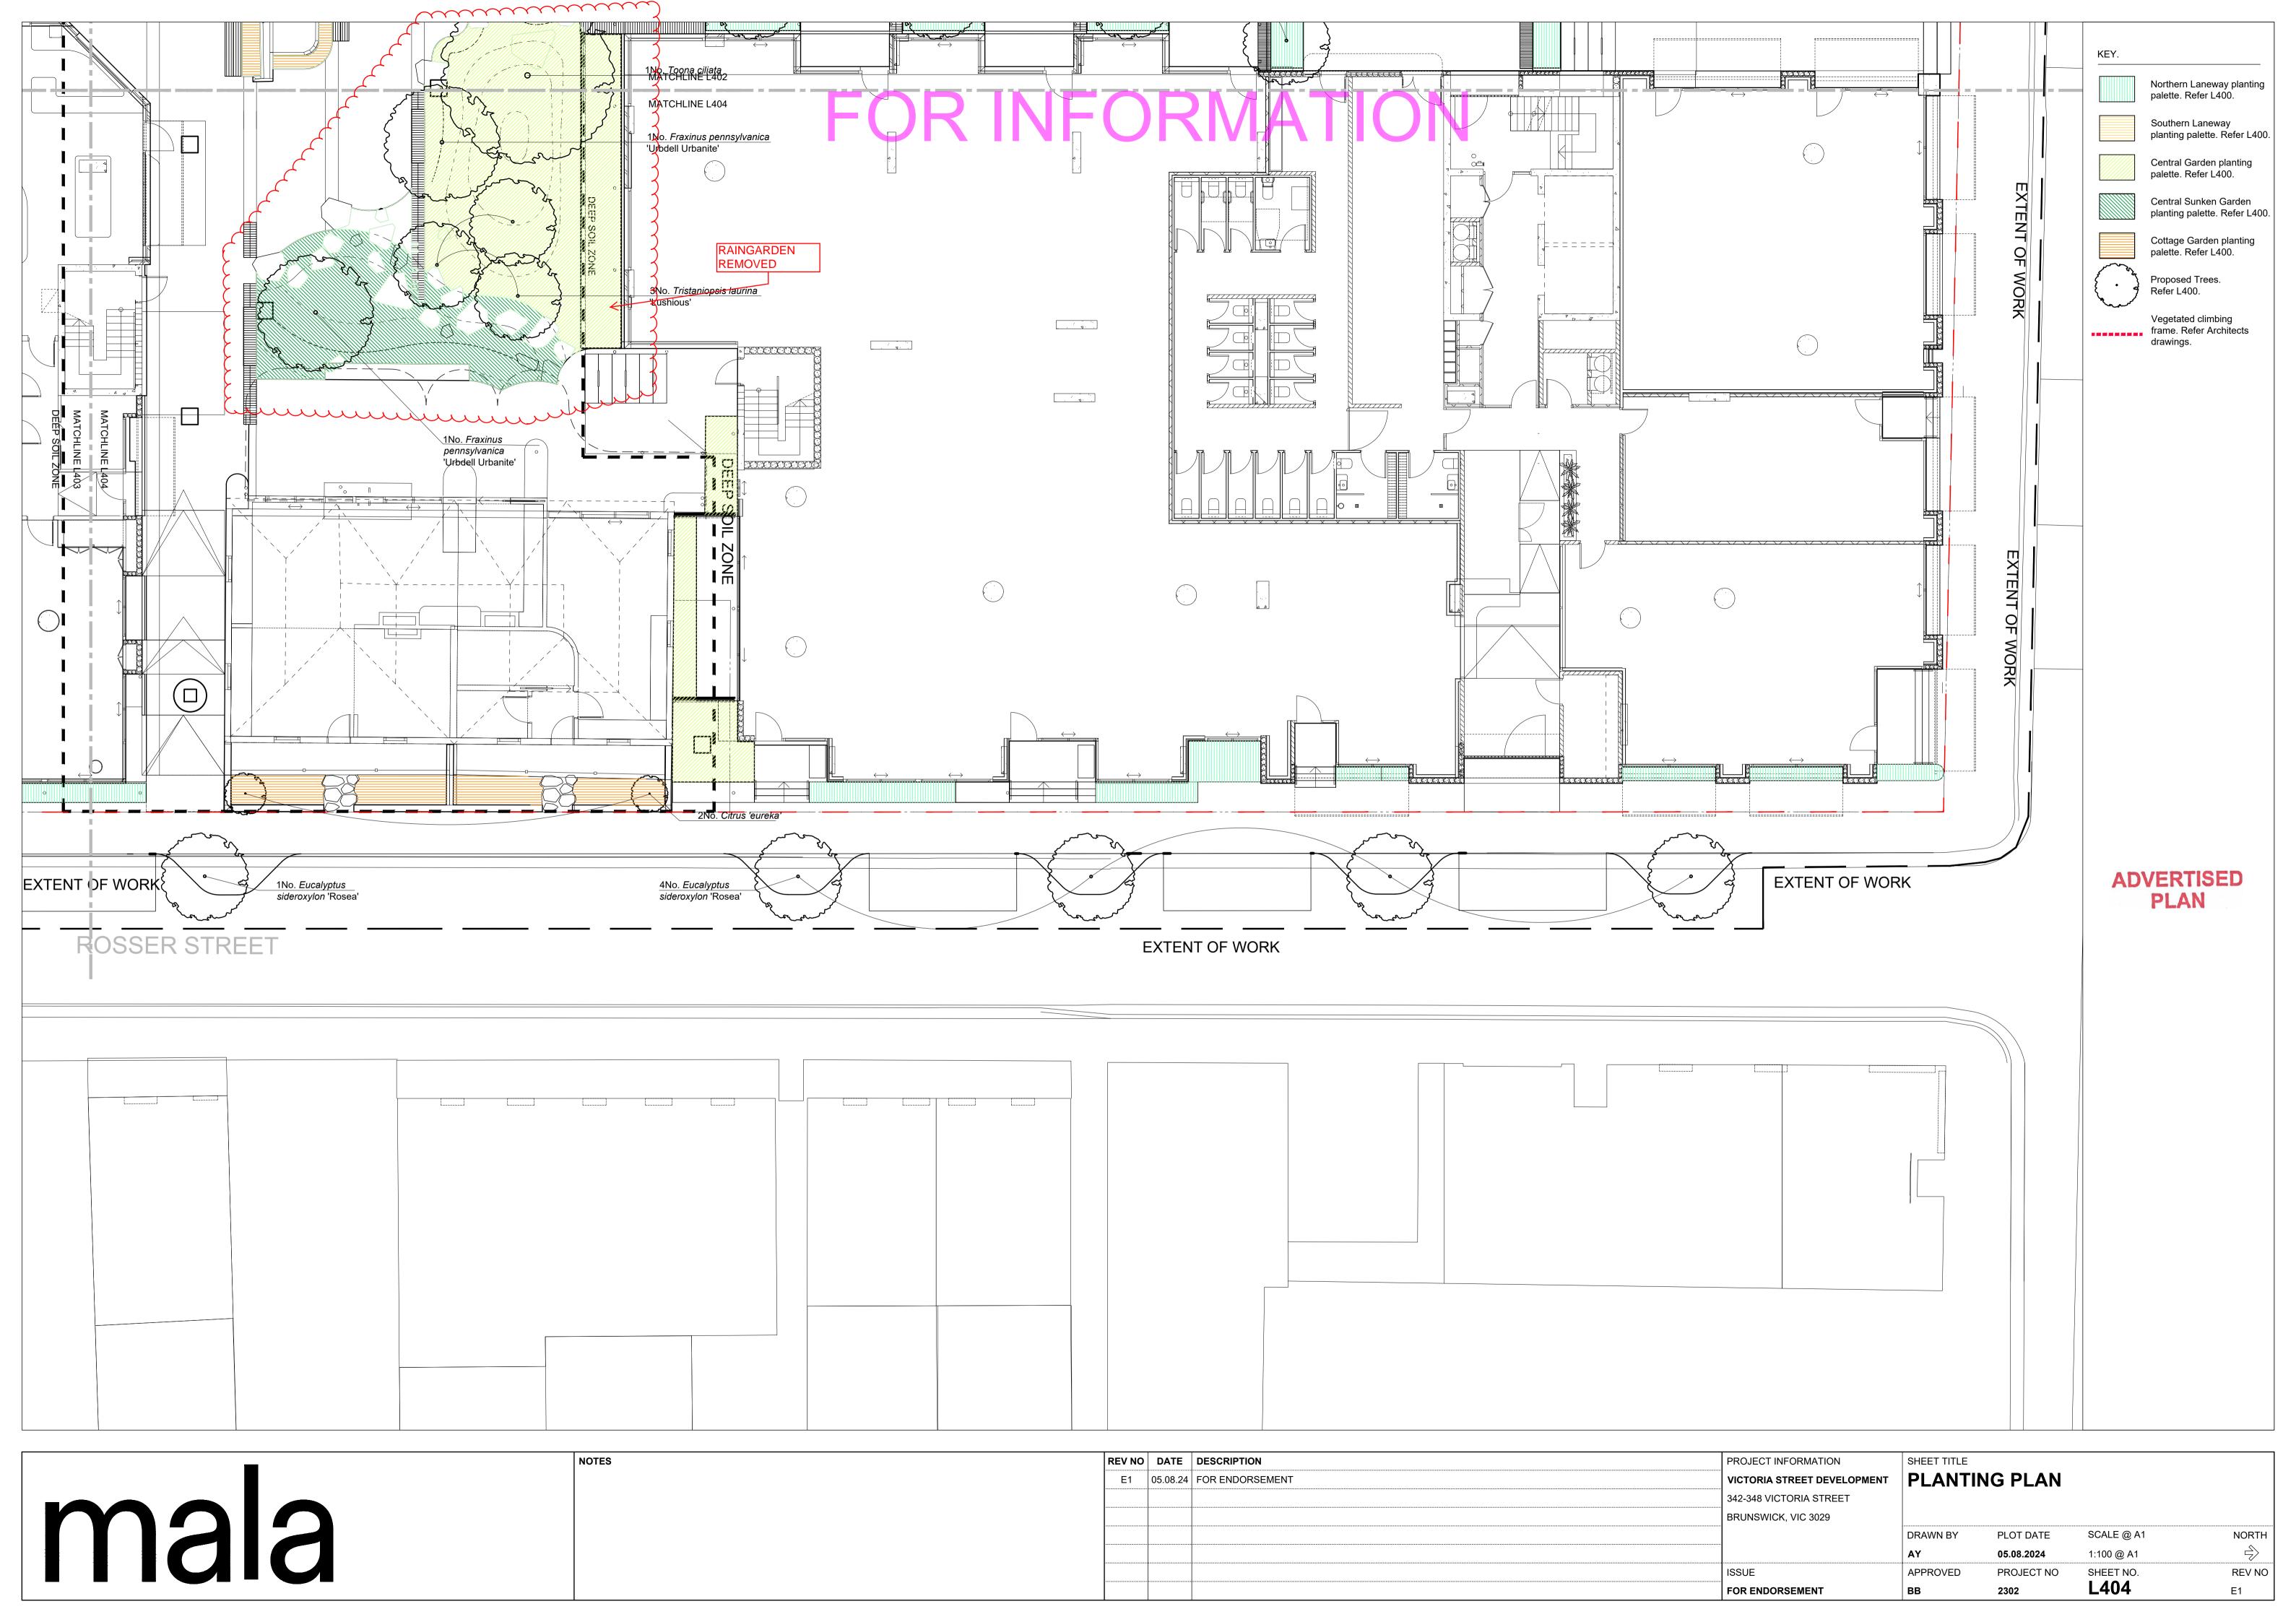


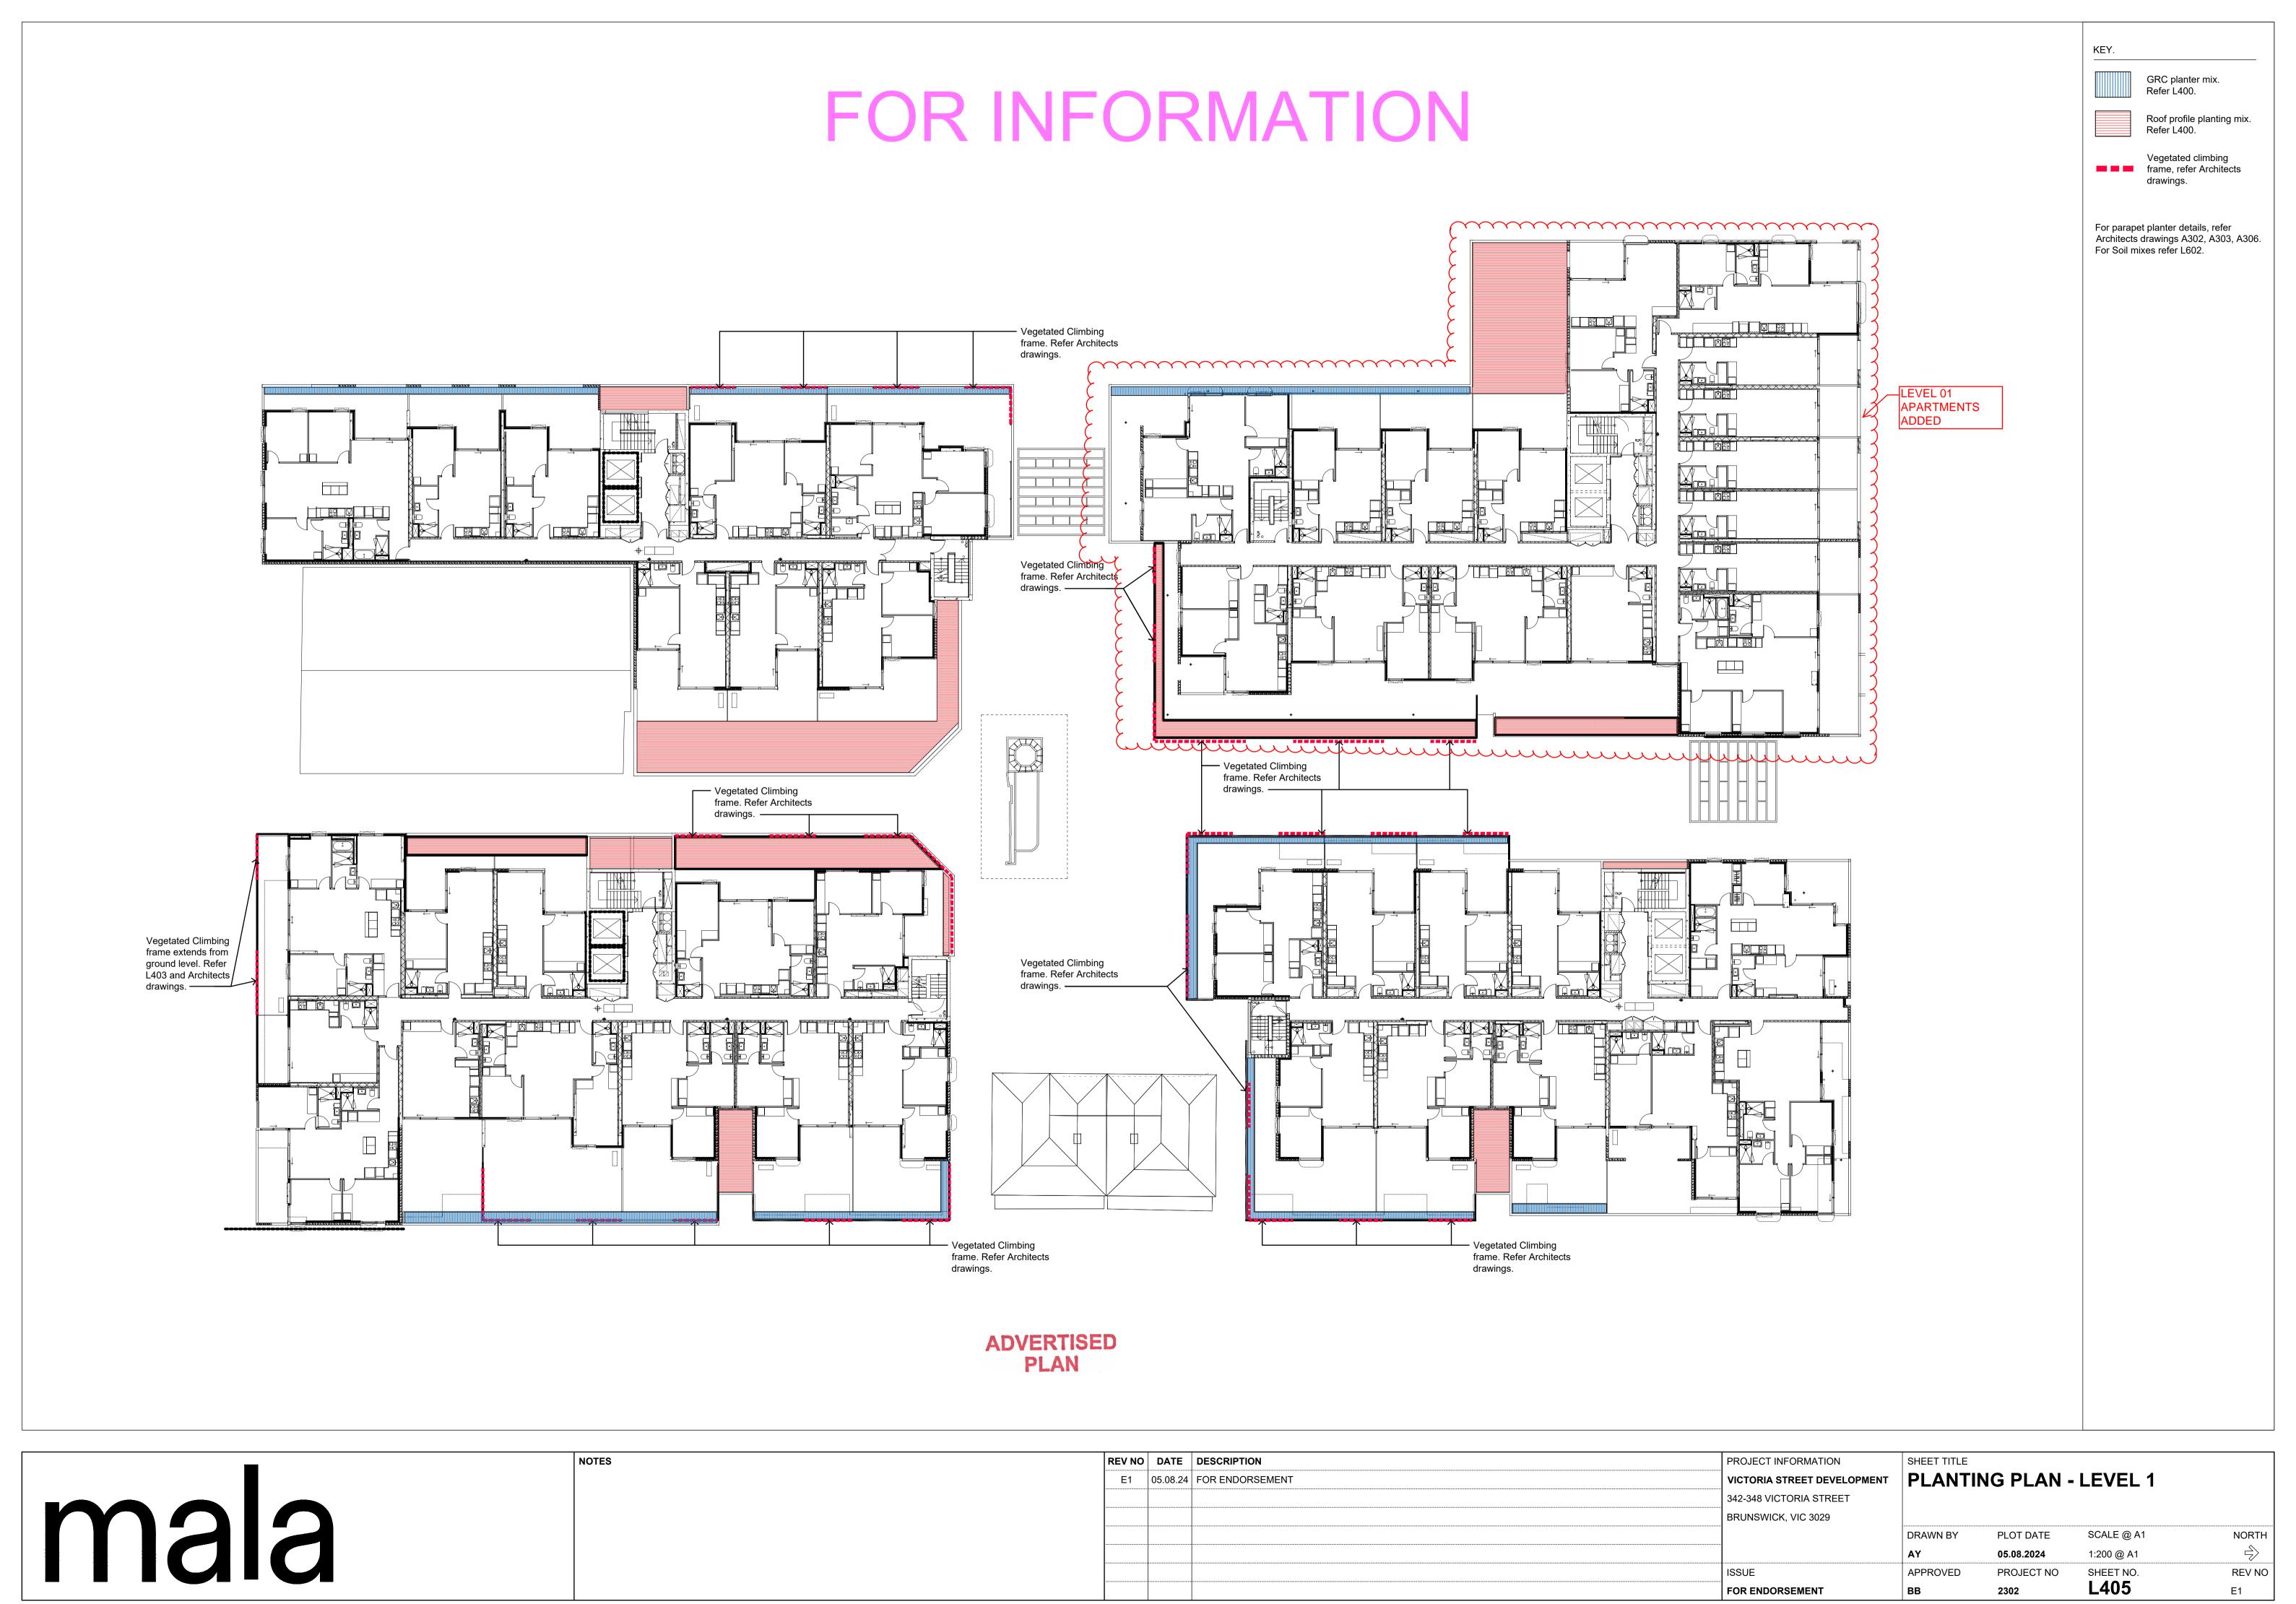


FOR INFORMATION

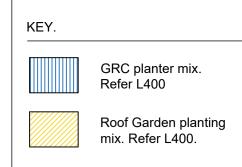



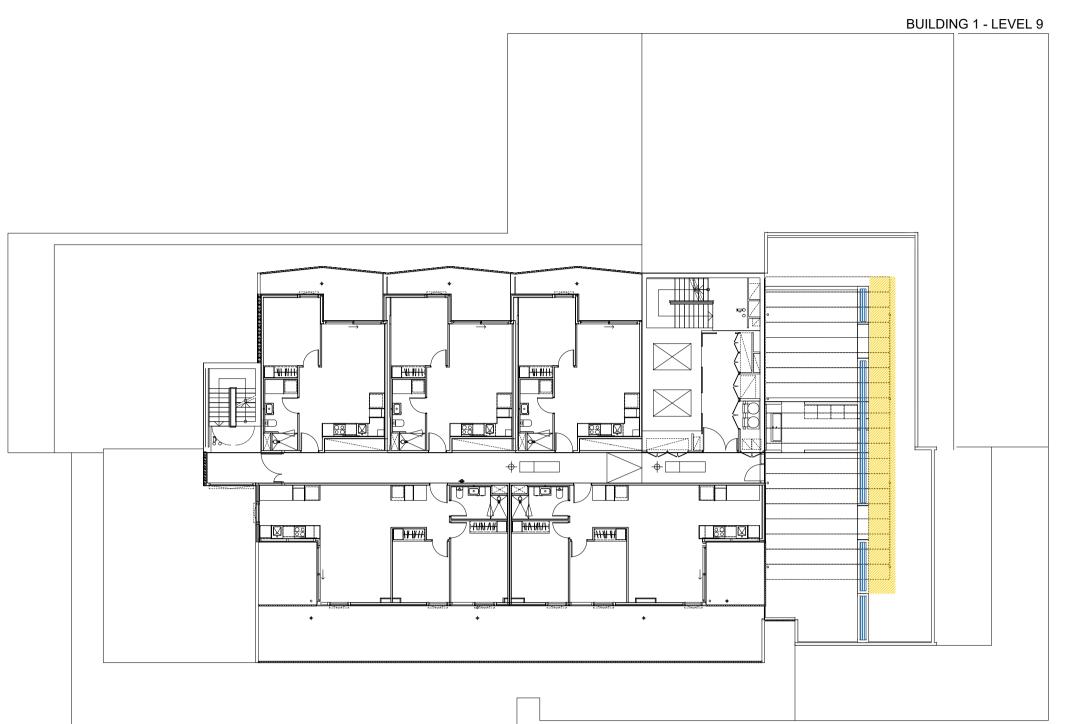


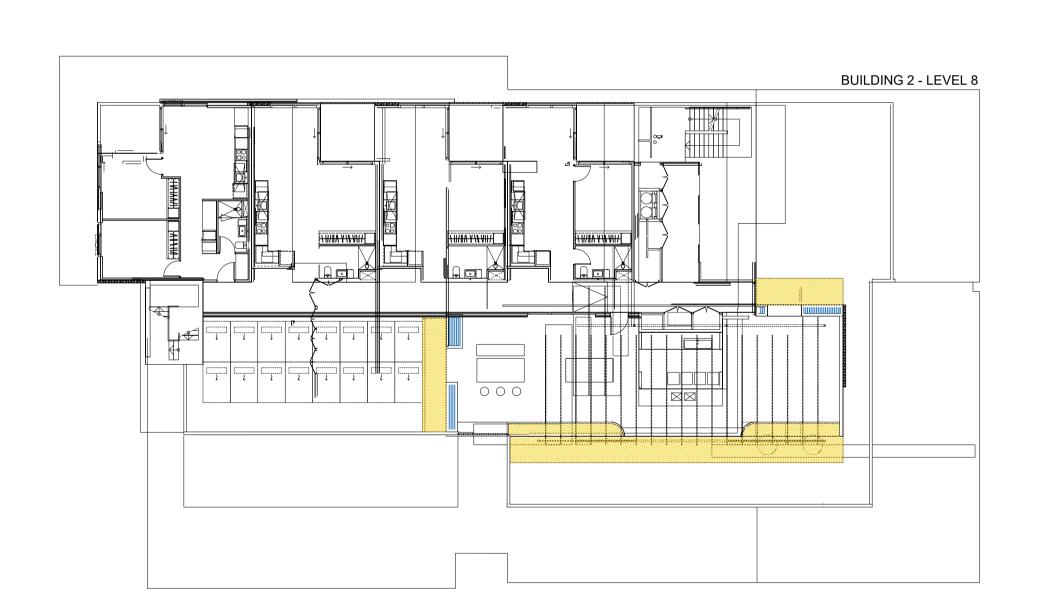


ADVERTISED PLAN

mala


REV NO	DATE	DESCRIPTION	PROJECT INFORMATION	SHEET TITLE			
E1	05.08.24	FOR ENDORSEMENT	VICTORIA STREET DEVELOPMENT	PLANTIN	GPLAN -	ROOFTOP SPA	ACE
			342-348 VICTORIA STREET				
			BRUNSWICK, VIC 3029				
				DRAWN BY	PLOT DATE	SCALE @ A1	N
				AY	05.08.2024	1:200 @ A1	
			ISSUE	APPROVED	PROJECT NO	SHEET NO.	RE
			FOR ENDORSEMENT	ВВ	2302	L406	E1

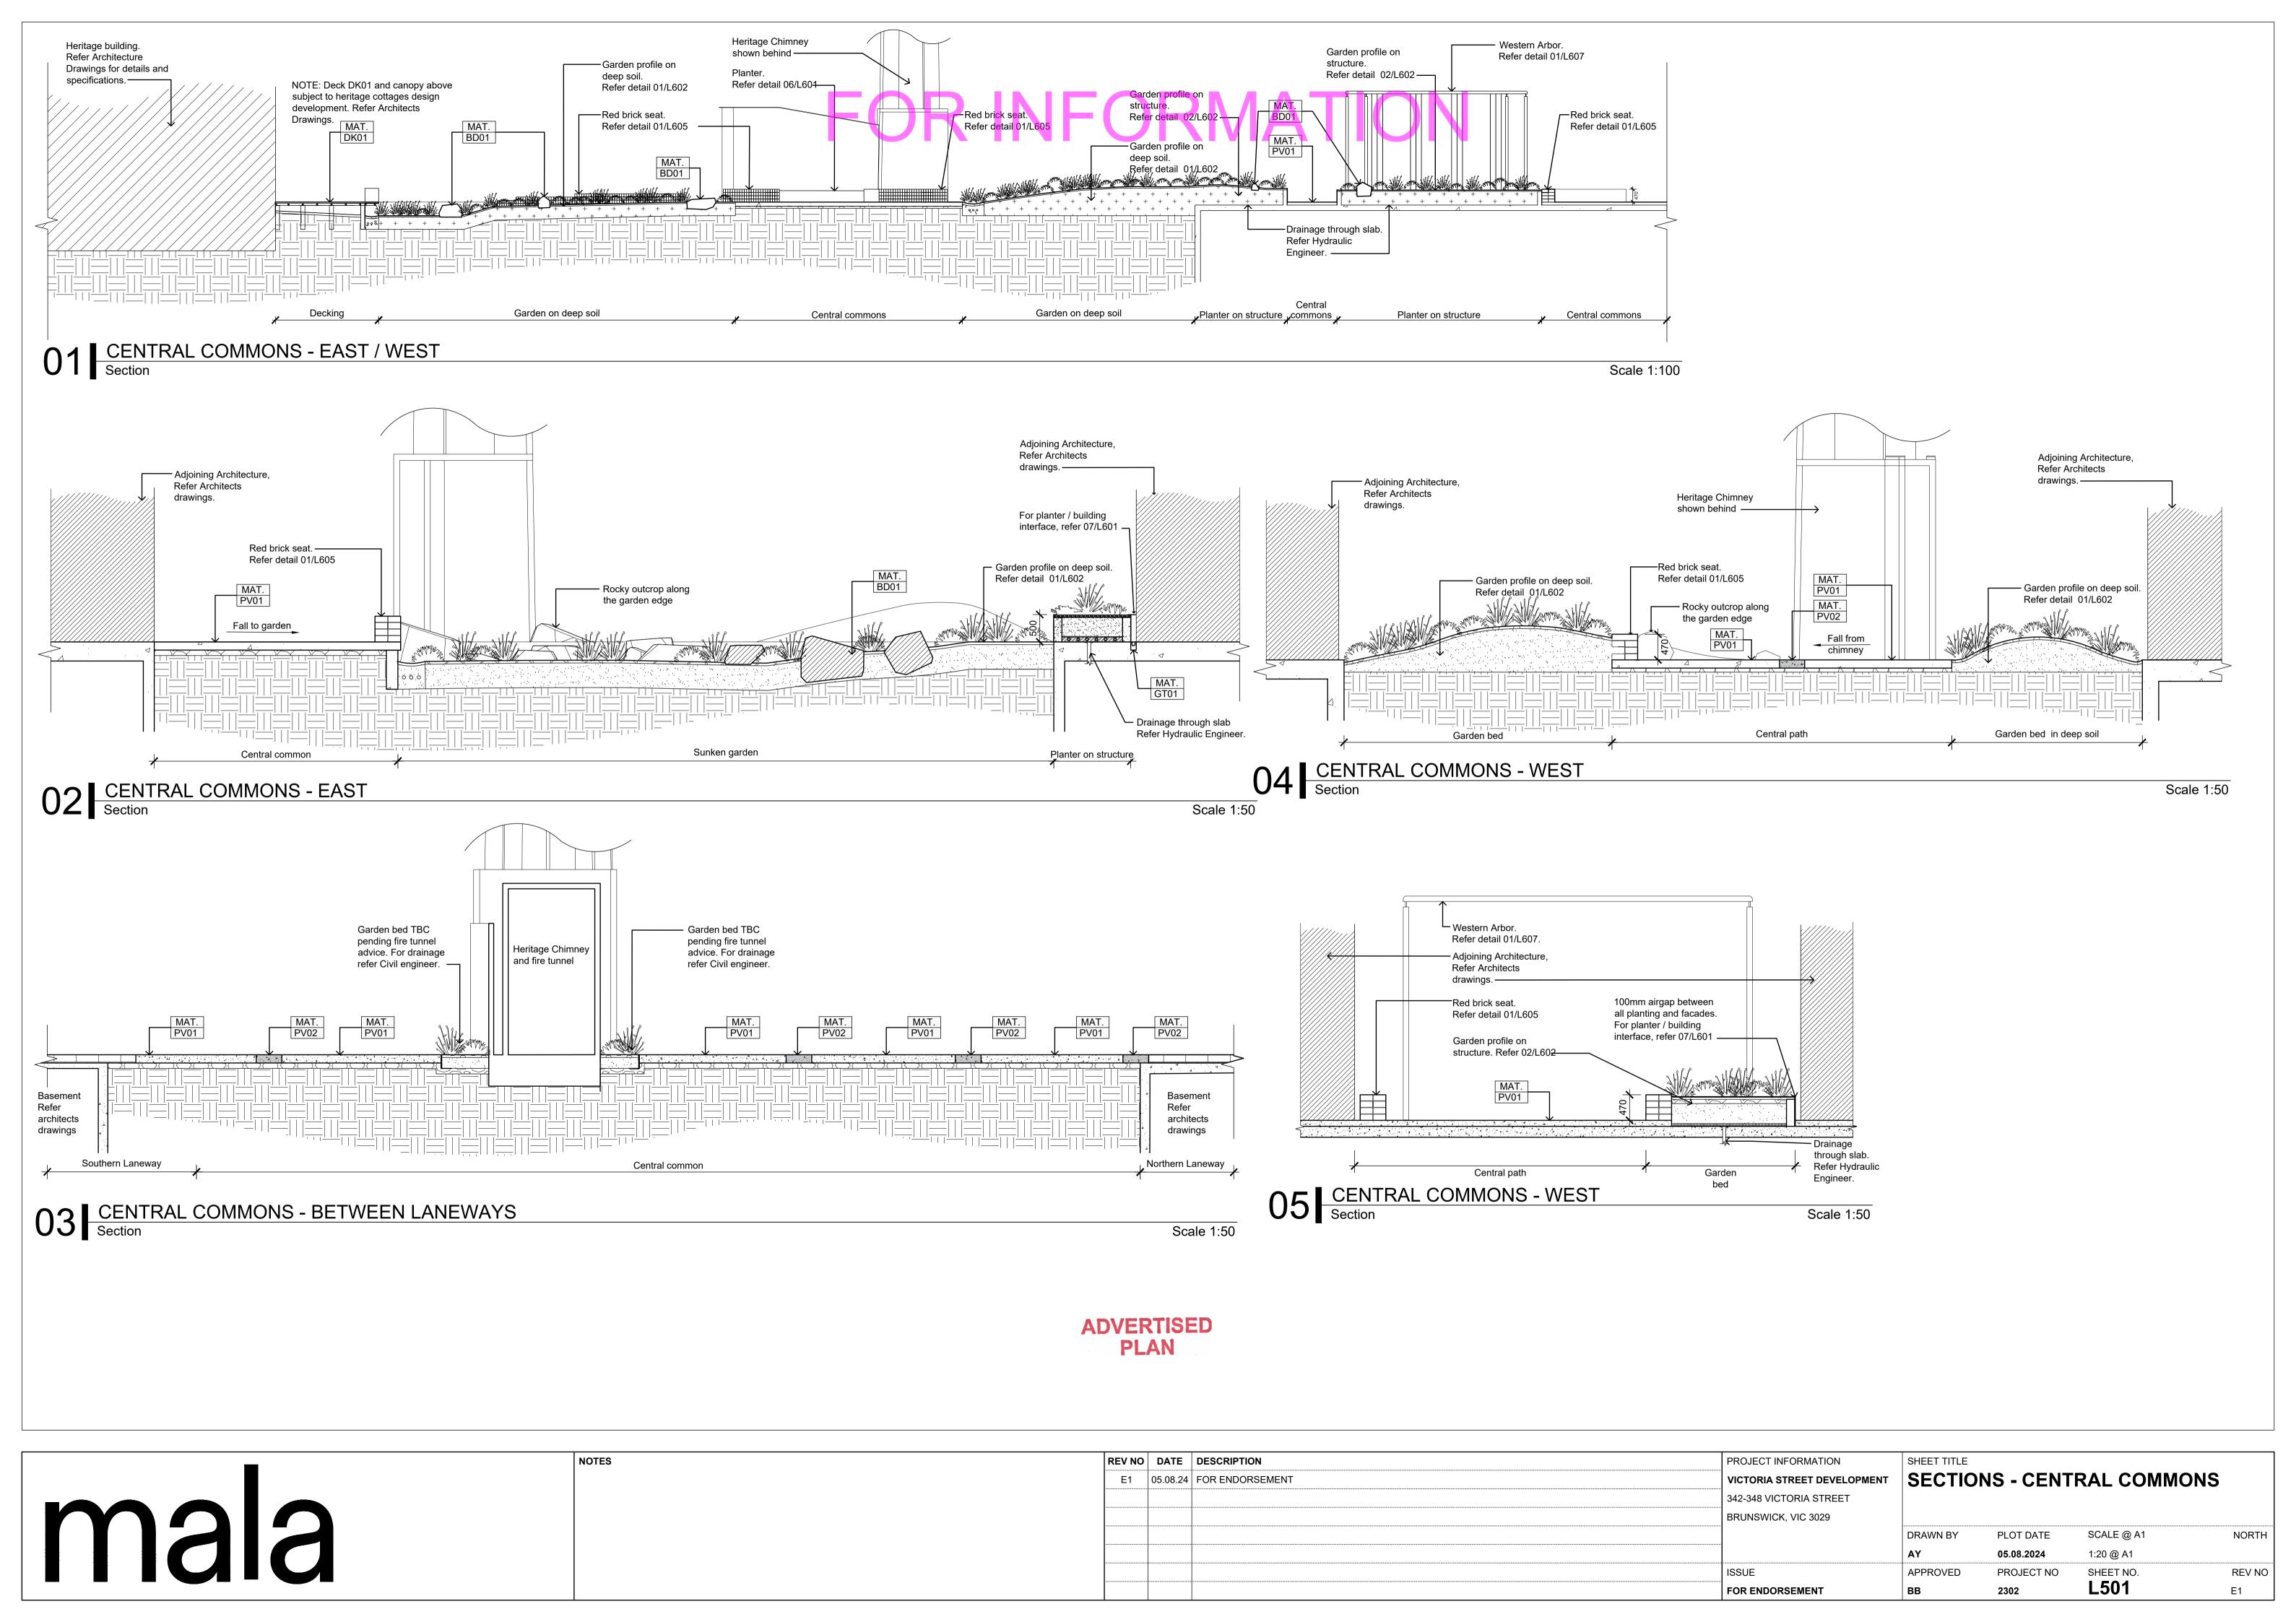

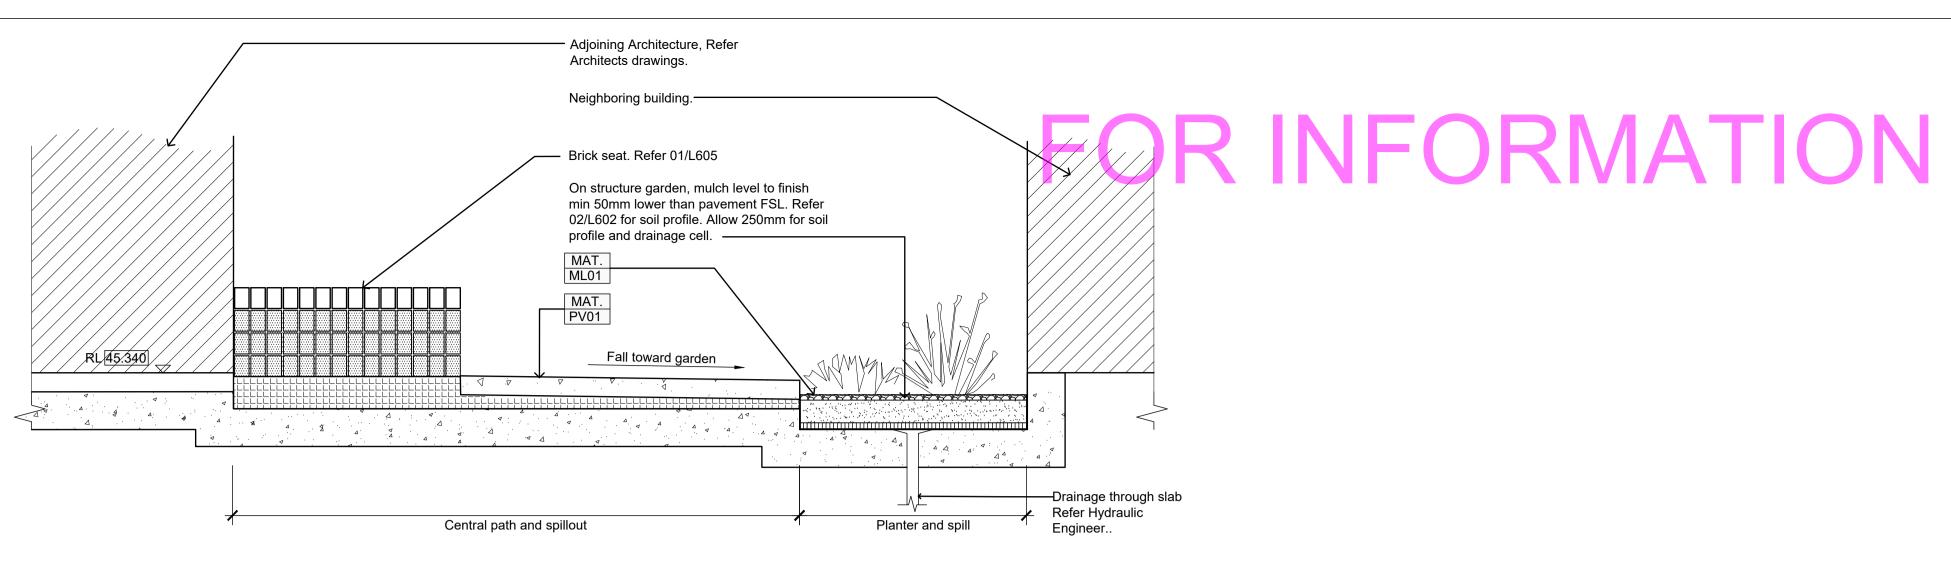


01 SOUTHERN LANEWAY
Section

Scale 1:20

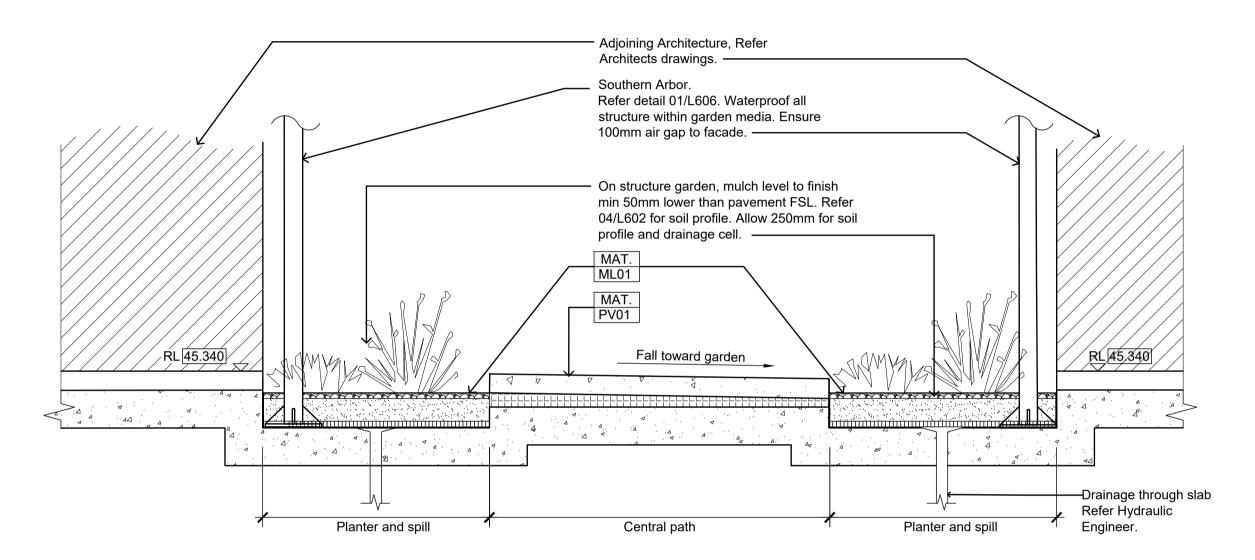

02 SOUTHERN LANEWAY
Section

Scale 1:20

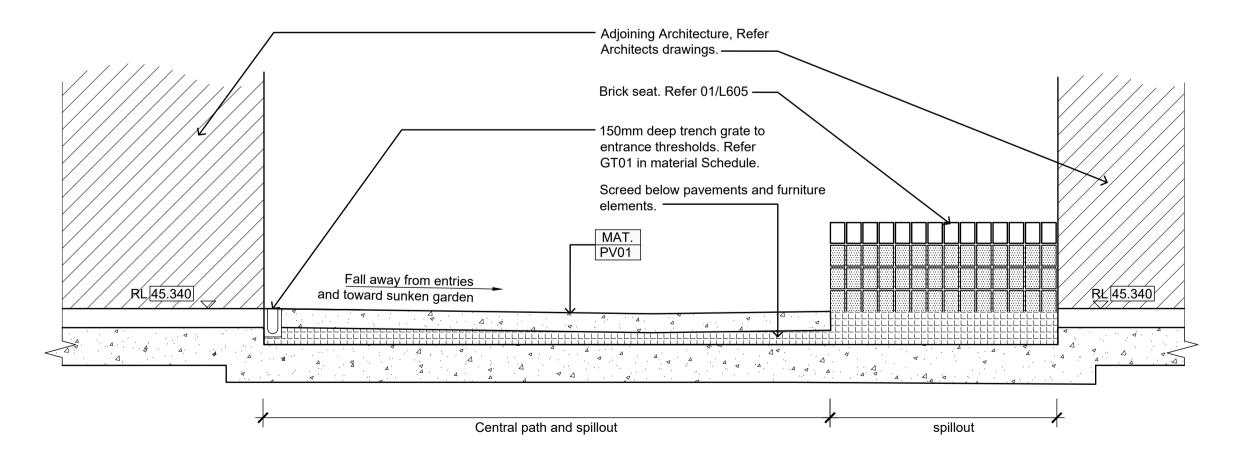

03 Section


Scale 1:20

ADVERTISED PLAN

NORTH


REV NO


_	NOTES	REV NO DATE DESCRIPTION	PROJECT INFORMATION	SHEET TITLE			
		E1 05.08.24 FOR ENDORSEMENT	VICTORIA STREET DEVELOPMEN	SECTIO	NS - SOU	THERN LANEWA	ΛΥ
			342-348 VICTORIA STREET				
			BRUNSWICK, VIC 3029				
				DRAWN BY	PLOT DATE	SCALE @ A1	NOR
				AY	05.08.2024	1:20 @ A1	
			ISSUE	APPROVED	PROJECT NO	SHEET NO.	REV
			FOR ENDORSEMENT	ВВ	2302	L502	E1

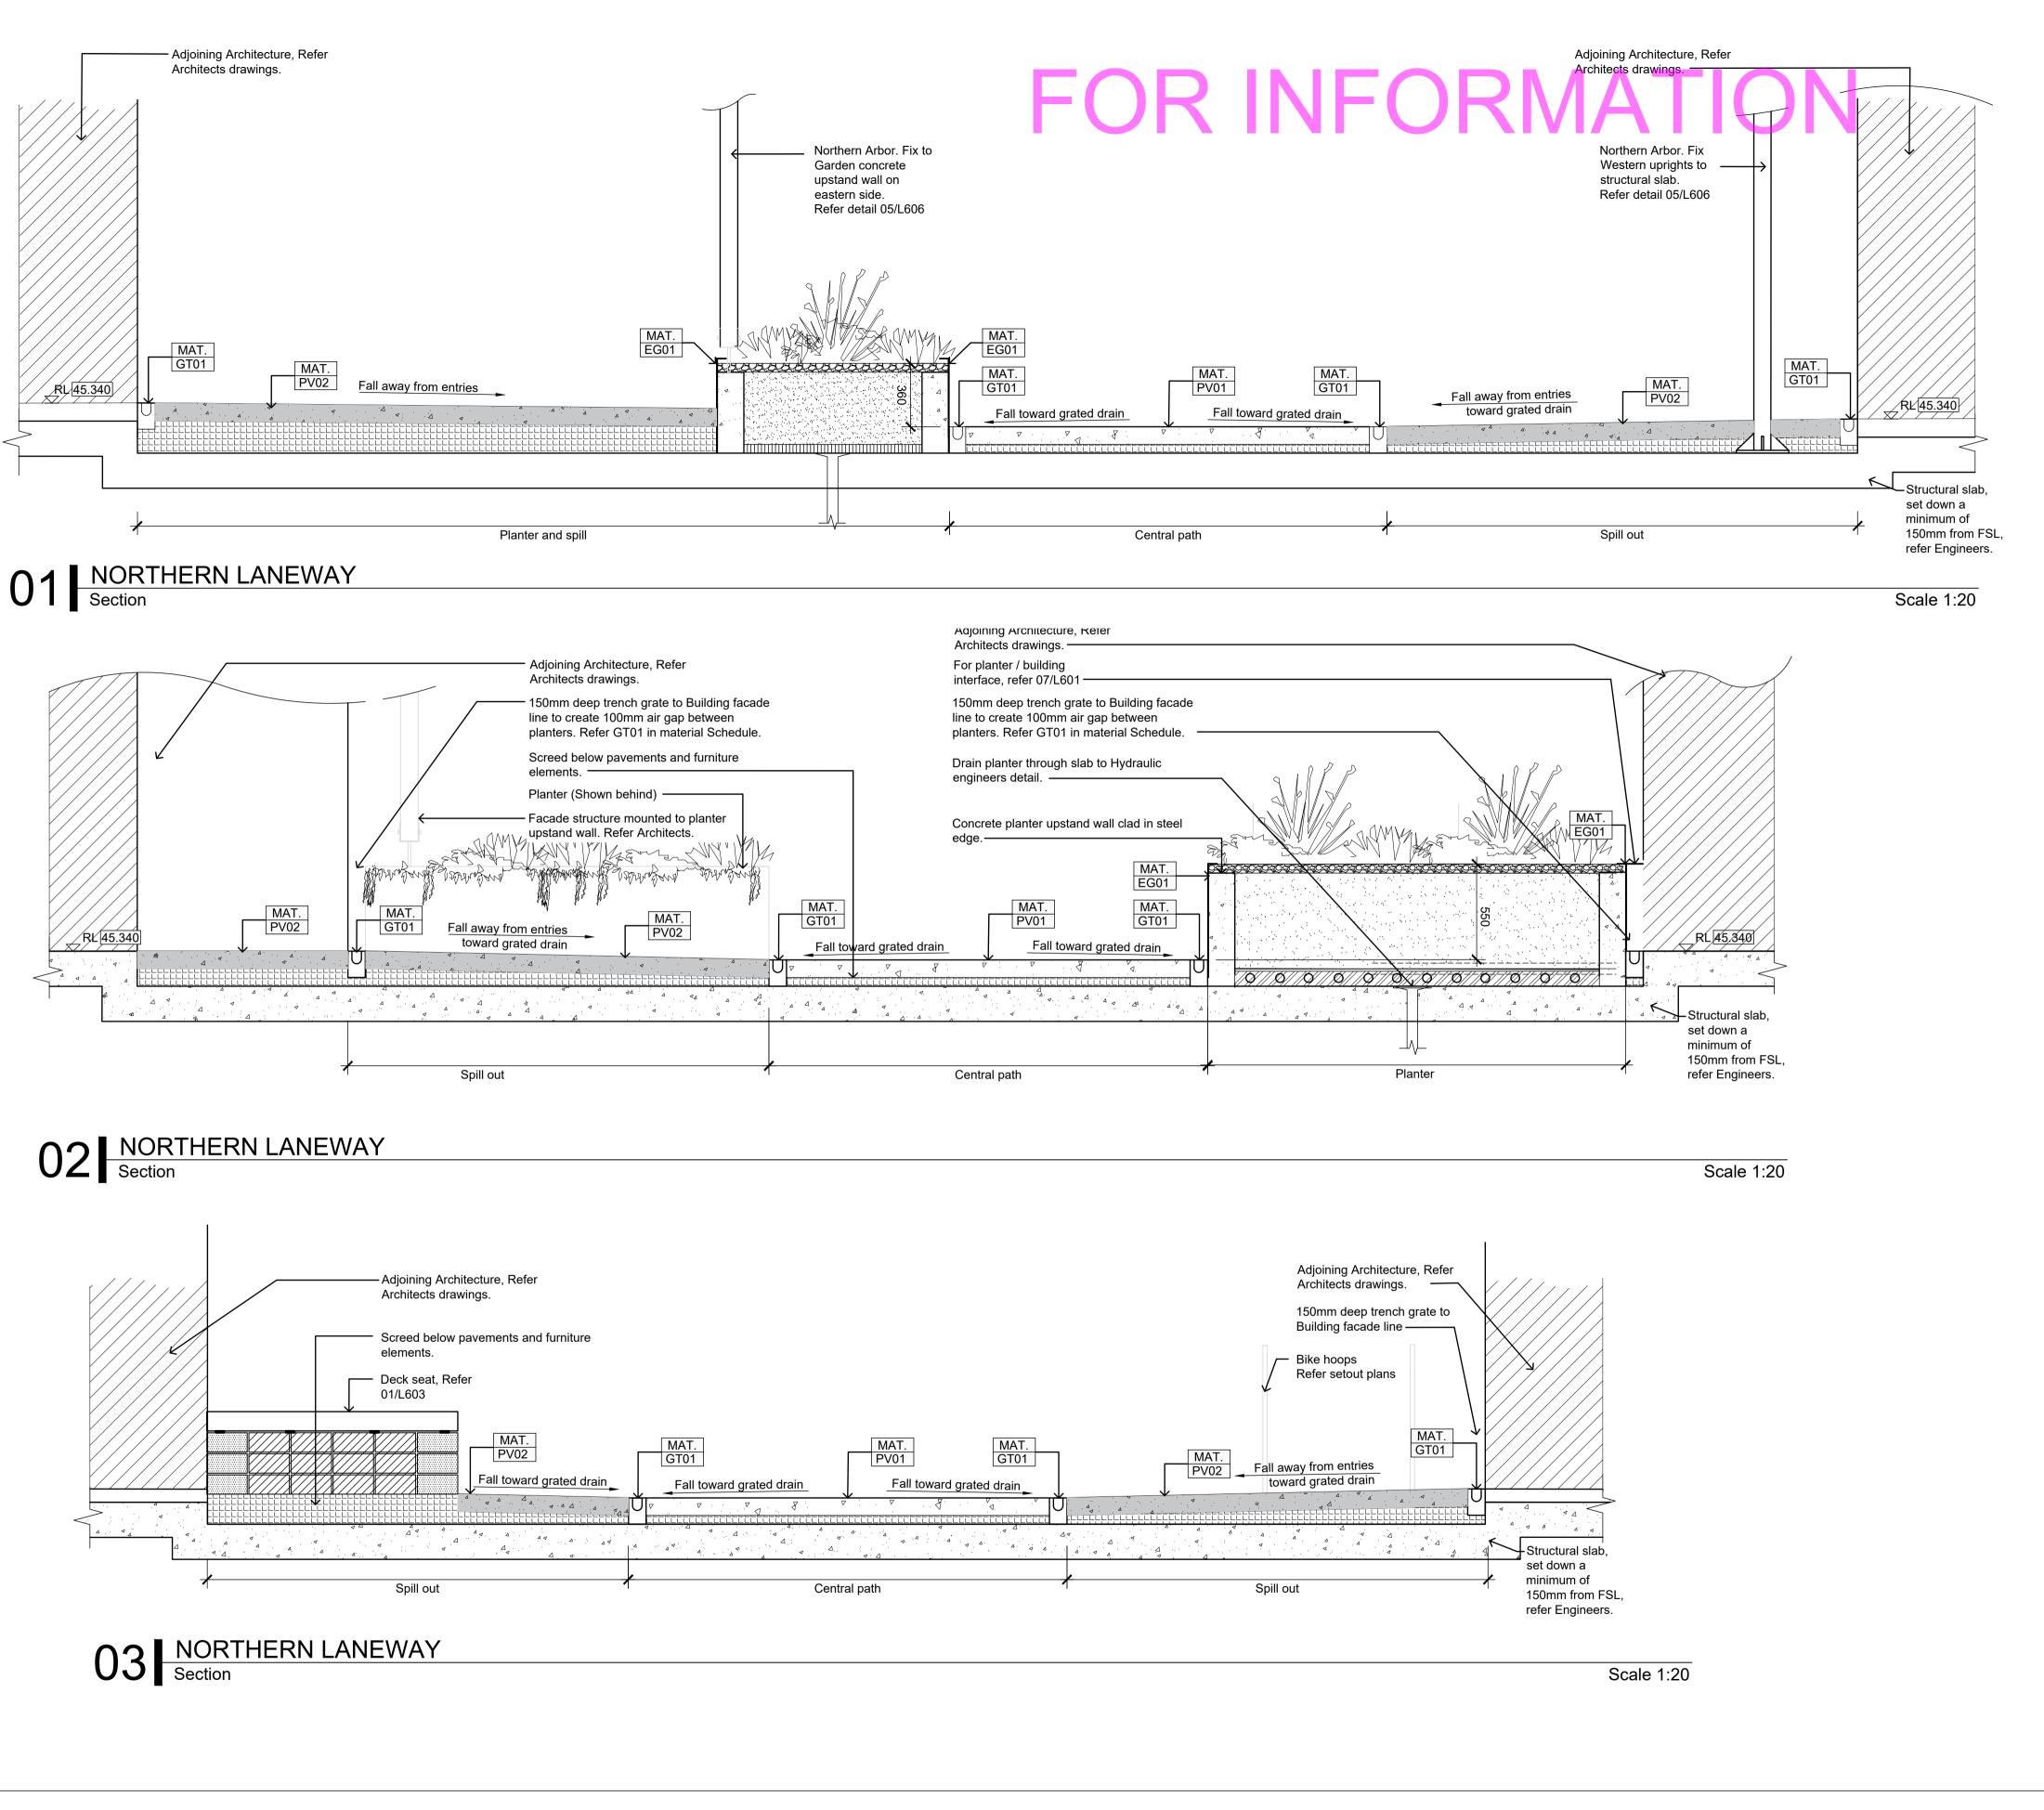

ADVERTISED PLAN


NOTES REV NO DATE DESCRIPTION PROJECT INFORMATION **SECTIONS - NORTHERN LANEWAY** E1 05.08.24 FOR ENDORSEMENT **VICTORIA STREET DEVELOPMEN** mala 342-348 VICTORIA STREET BRUNSWICK, VIC 3029 DRAWN BY PLOT DATE SCALE @ A1 NORTH 1:20 @ A1 05.08.2024 ISSUE APPROVED PROJECT NO SHEET NO. REV NO L503 FOR ENDORSEMENT 2302

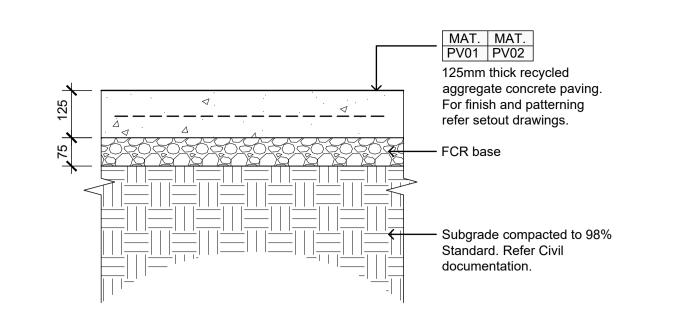

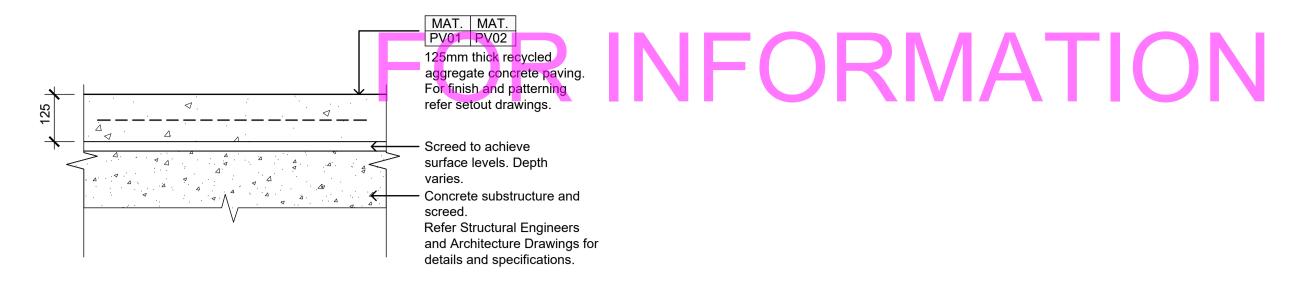


O1 PAVEMENTS PV01 &PV02 - ON DEEP SOIL
Section Scale 1:10

02 PAVEMENTS PV01 & PV02 - ON STRUCTURE
Scale 1:10

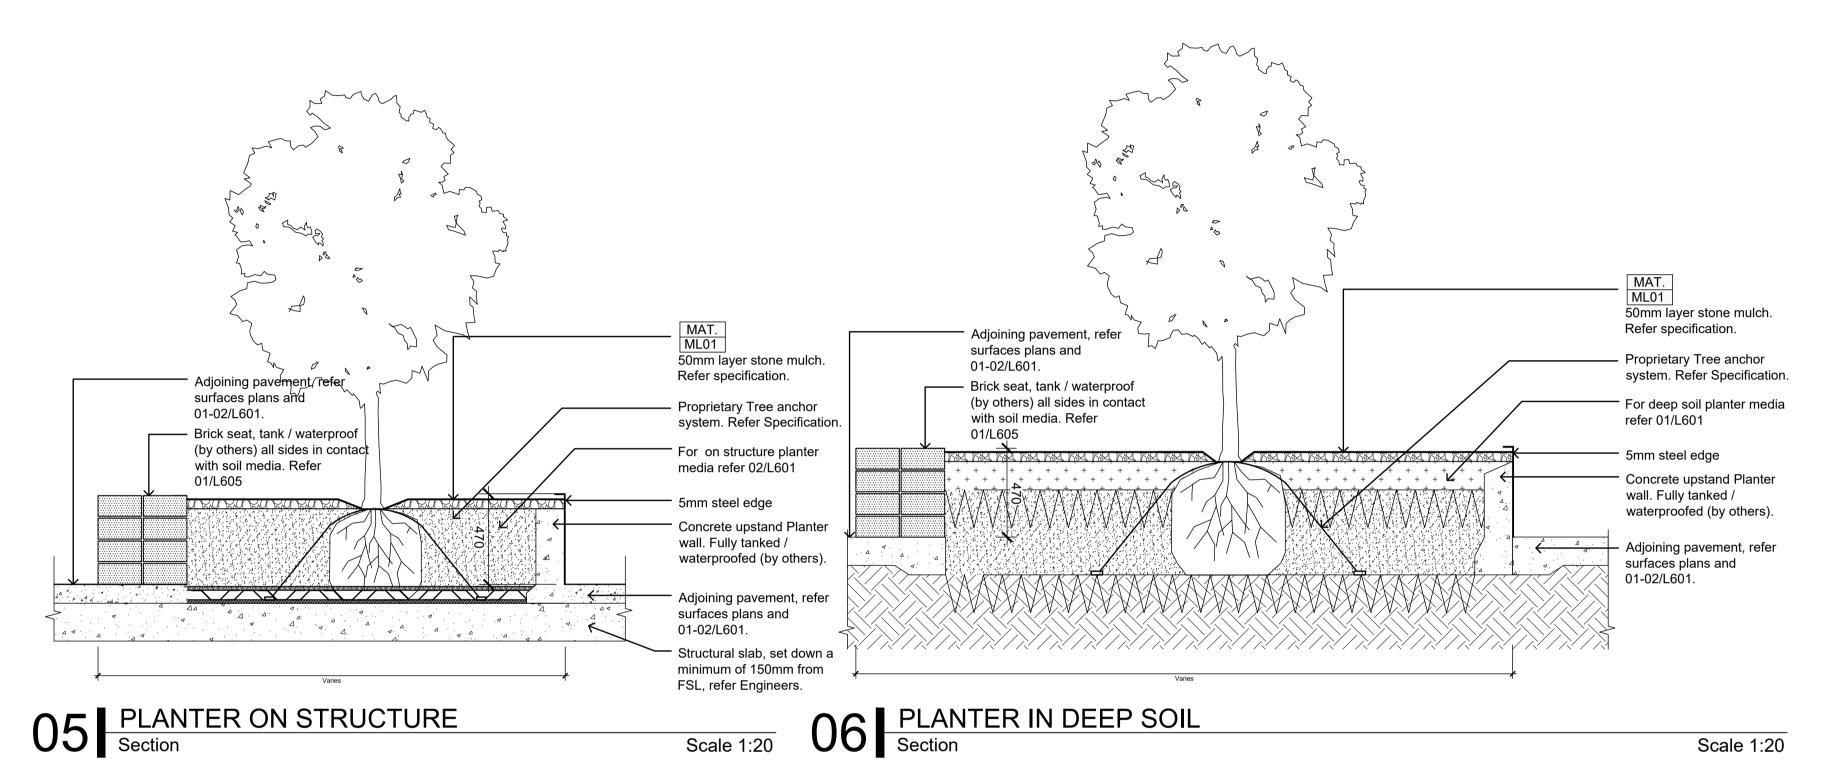

NOTES

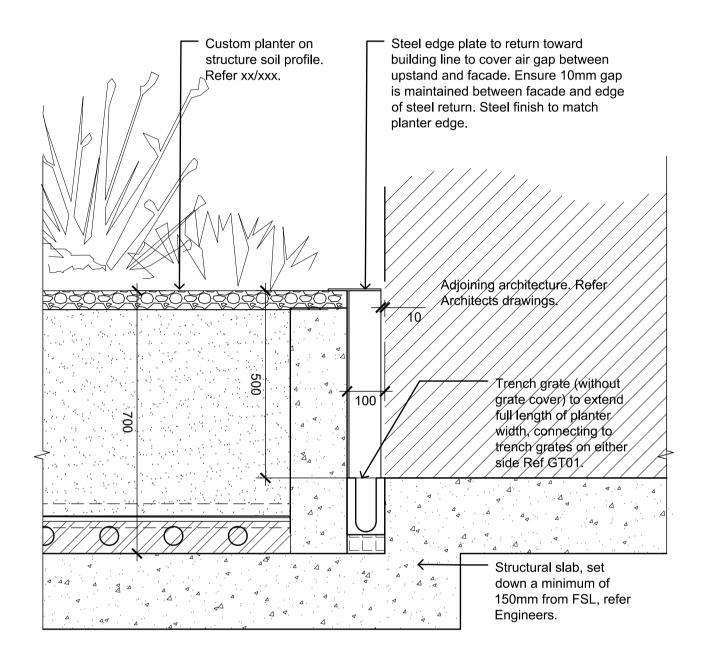



07 RAISED PLANTER / BUILDING INTERFACE
Scale
Scale

ADVERTISED PLAN

mala


REV N	O DATE	DESCRIPTION	PROJECT INFORMATION	SHEET TITLE				
E1	05.08.24	FOR ENDORSEMENT	VICTORIA STREET DEVELOPMENT	DETAILS	DETAILS - HARD DETAILS			
			342-348 VICTORIA STREET					
			BRUNSWICK, VIC 3029					
				DRAWN BY	PLOT DATE	SCALE @ A1	NORTH	
				AY	05.08.2024	1:10 @ A1		
			ISSUE	APPROVED	PROJECT NO	SHEET NO.	REV NO	
			FOR ENDORSEMENT	ВВ	2302	L601	E1	

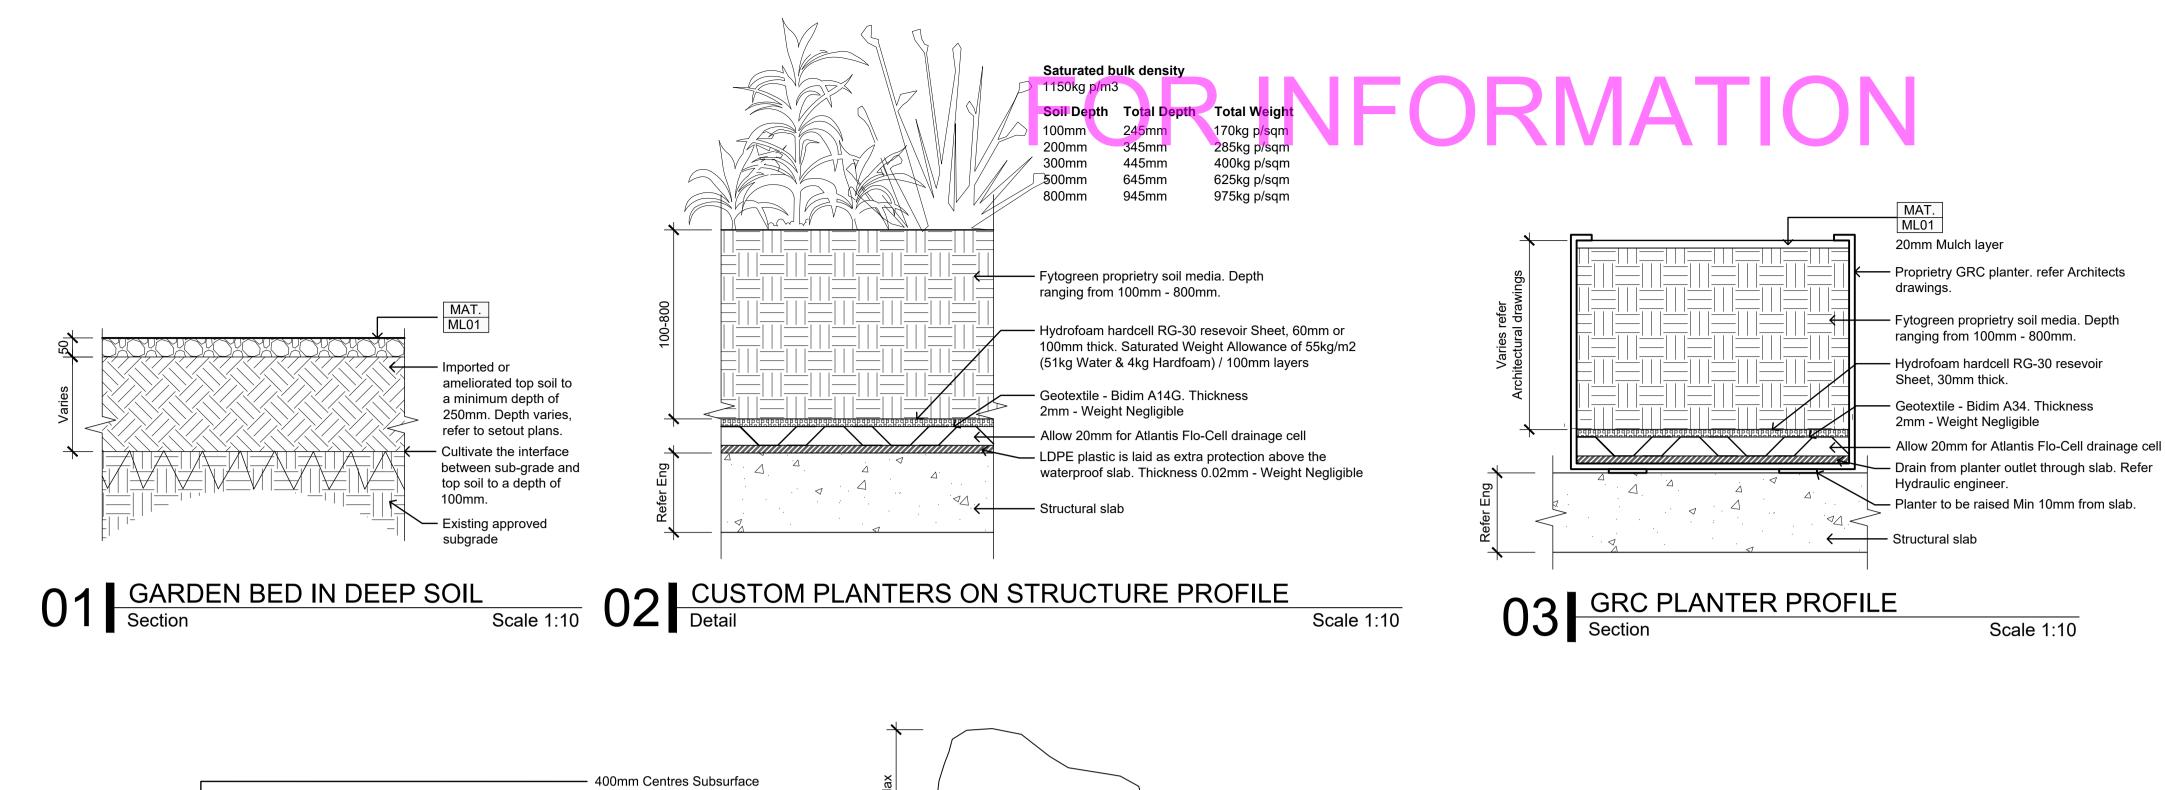


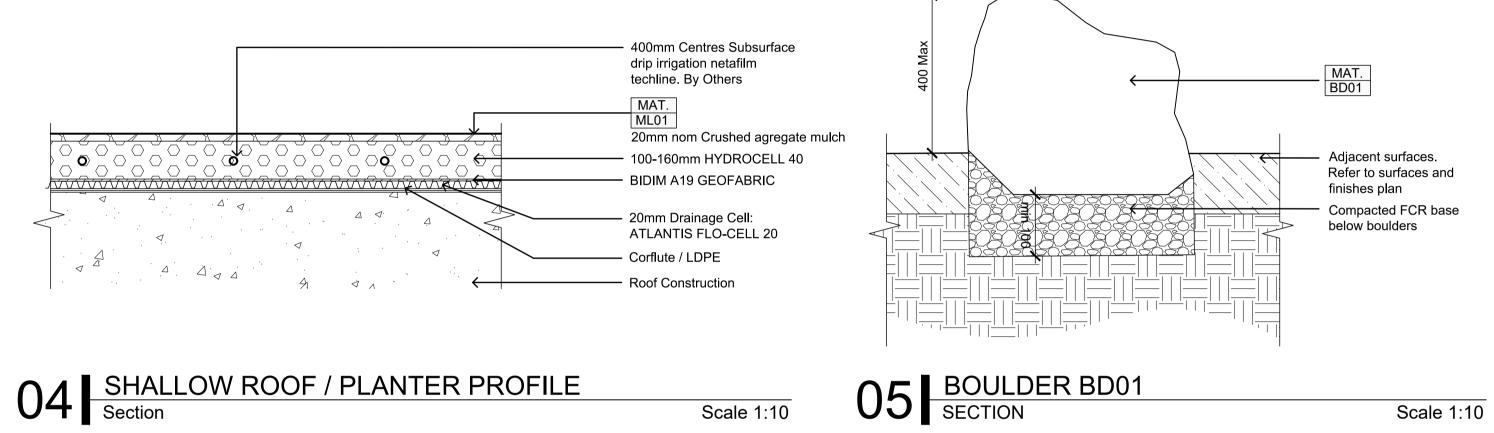


ADVERTISED PLAN

NOTES REV NO DATE DESCRIPTION E1 05.08.24 FOR ENDORSEMENT VICTORIA STREET DEVELOPMENT 342-348 VICTORIA STREET BRUNSWICK, VIC 3029 DRAWN BY PLOT DATE SCALE @ A1						
	E1 05.08.24 FOR ENDORSEMENT	VICTORIA STREET DEVELOPMENT	DETAILS	S-SOFT D	ETAILS	
		342-348 VICTORIA STREET				
		BRUNSWICK, VIC 3029				
			DRAWN BY	PLOT DATE	SCALE @ A1	NORTH
			AY	05.08.2024	1:10 @ A1	
		ISSUE	APPROVED	PROJECT NO	SHEET NO.	REV NO
		FOR ENDORSEMENT	ВВ	2302	L602	E1

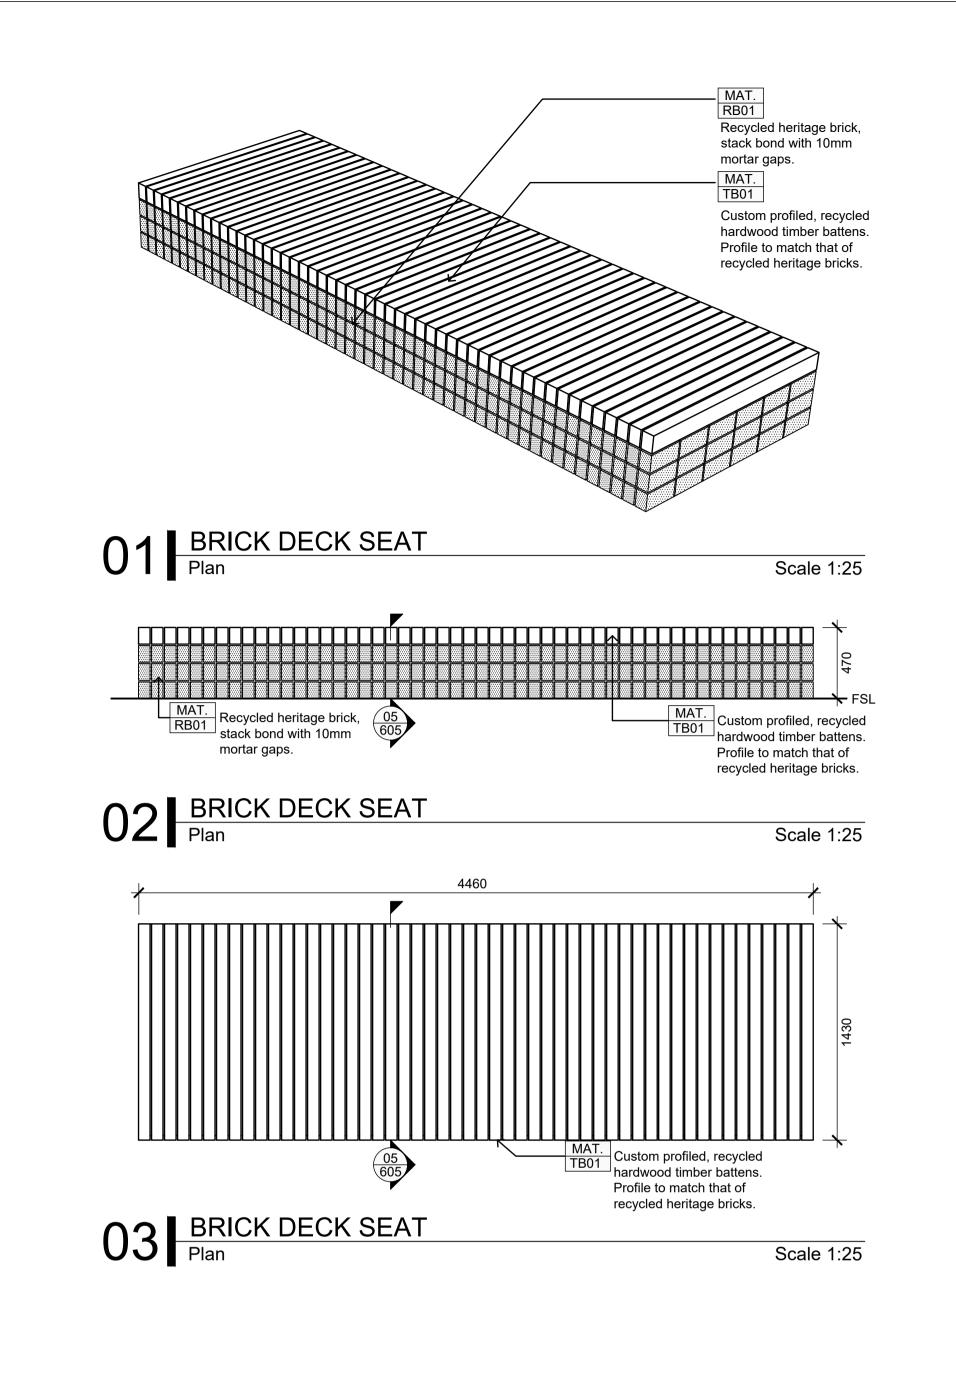

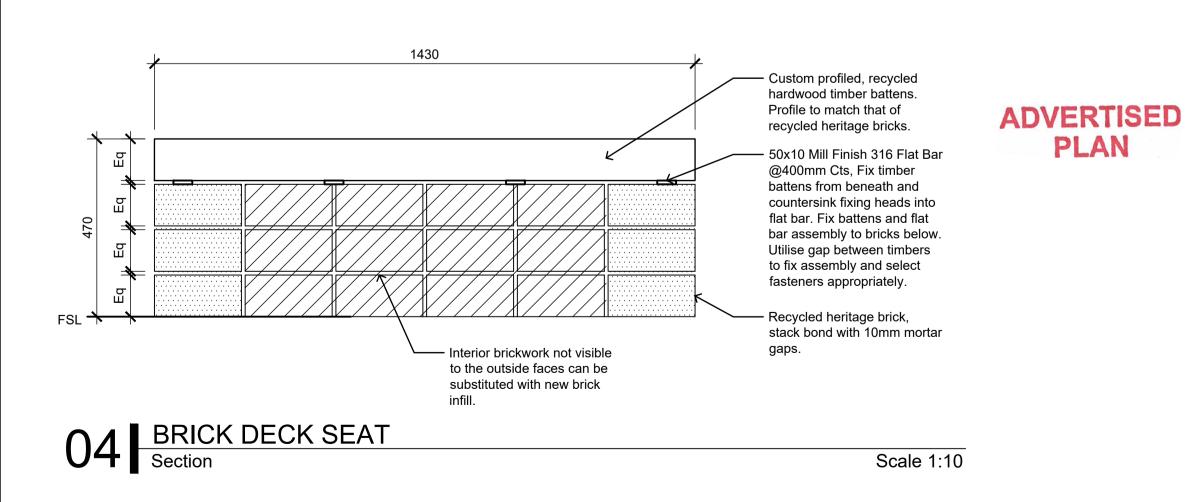


NOTES

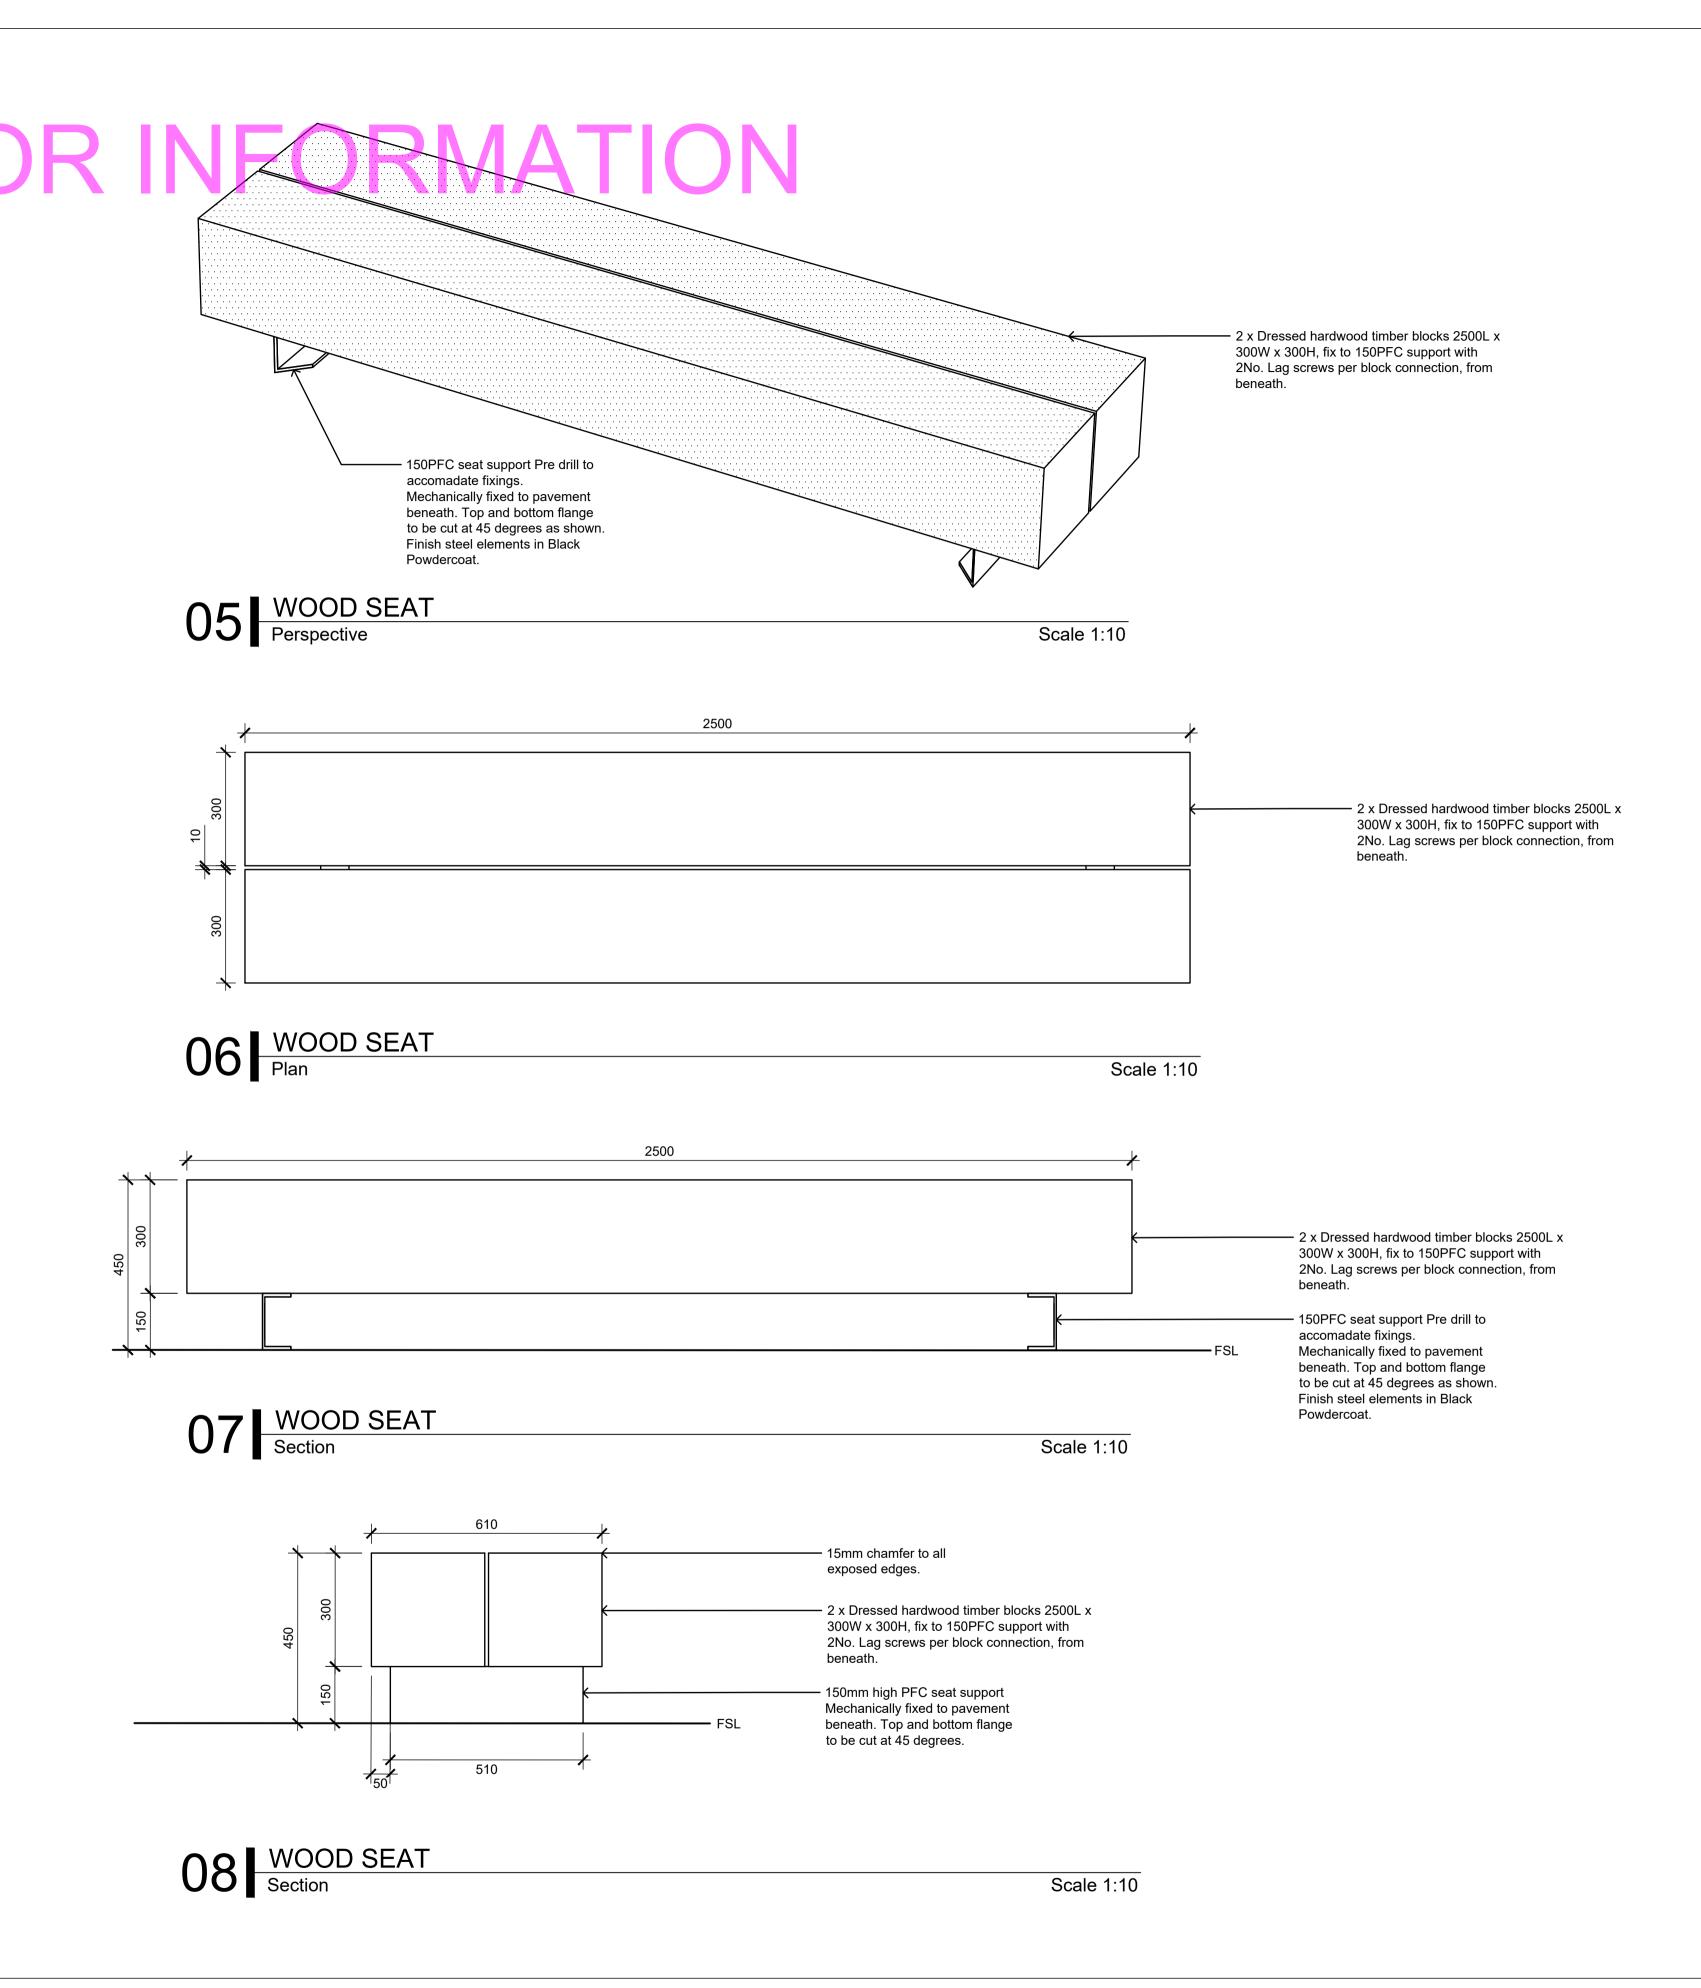




REV NO DATE DESCRIPTION PROJECT INFORMATION SHEET TITLE **DETAILS - DECK SEAT** E1 05.08.24 FOR ENDORSEMENT **VICTORIA STREET DEVELOPMEN** 342-348 VICTORIA STREET BRUNSWICK, VIC 3029 DRAWN BY PLOT DATE SCALE @ A1 NORTH 05.08.2024 Varies ISSUE APPROVED PROJECT NO SHEET NO. **REV NO** L603 FOR ENDORSEMENT 2302 E1

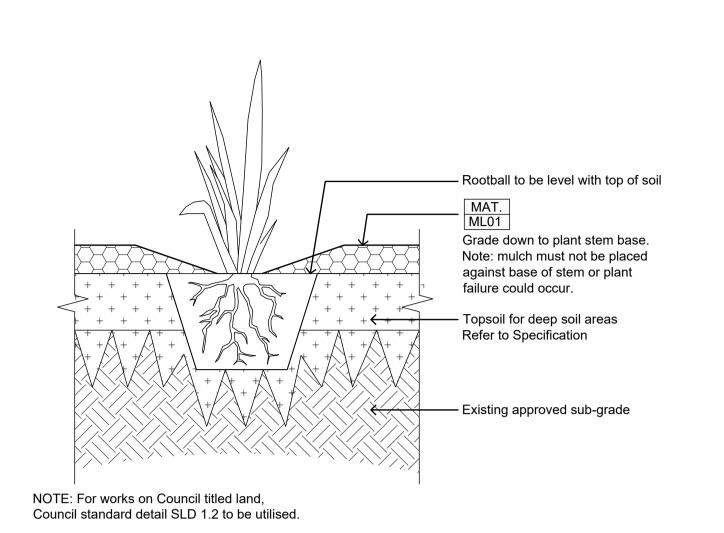


02 SHRUB & GROUNDCOVER PLANTING DEEP SOIL
Section Scale 1:10

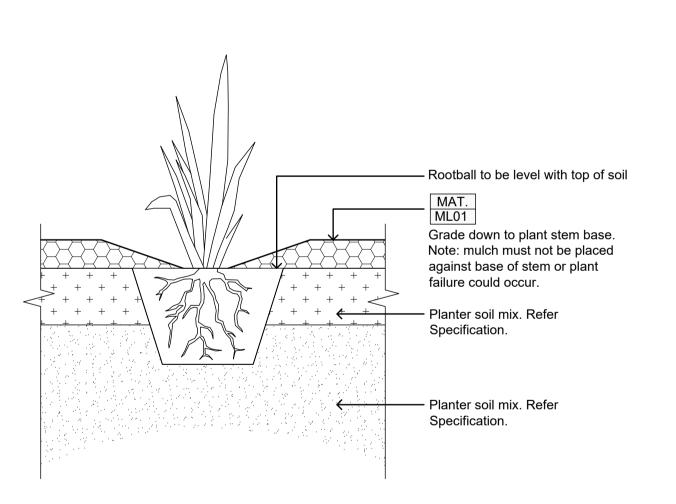

05 Section Scale 1:10

NOTES

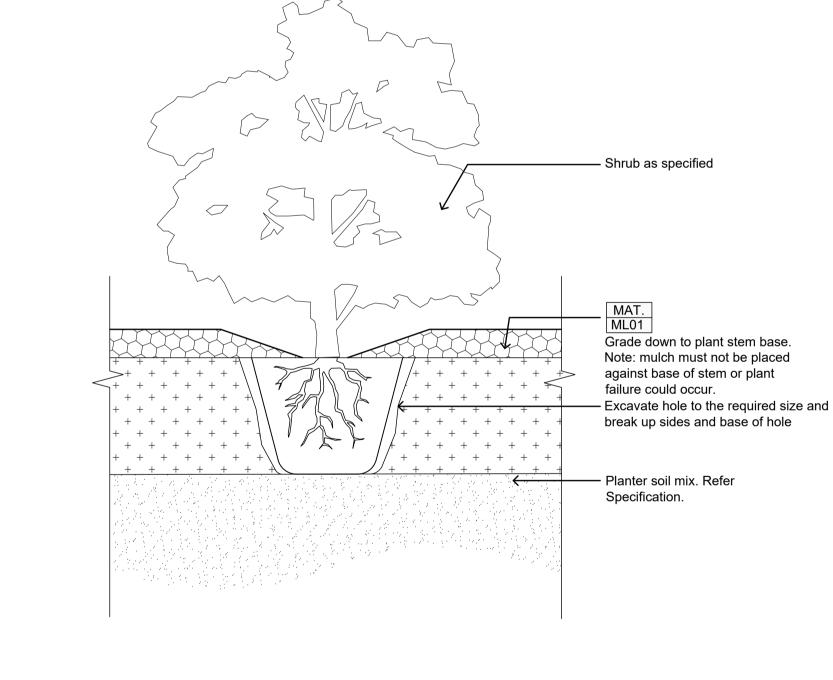

73 TYPICAL SHRUB PLANTING IN DEEP SOIL
Section

+ + + + +

+ + + + + +

Shrub as specified

Grade down to plant stem base.

Note: mulch must not be placed against base of stem or plant

break up sides and base of hole

Topsoil fordeep soil areas


Refer to Specification

- Excavate hole to the required size and

Scale 1:10

failure could occur.




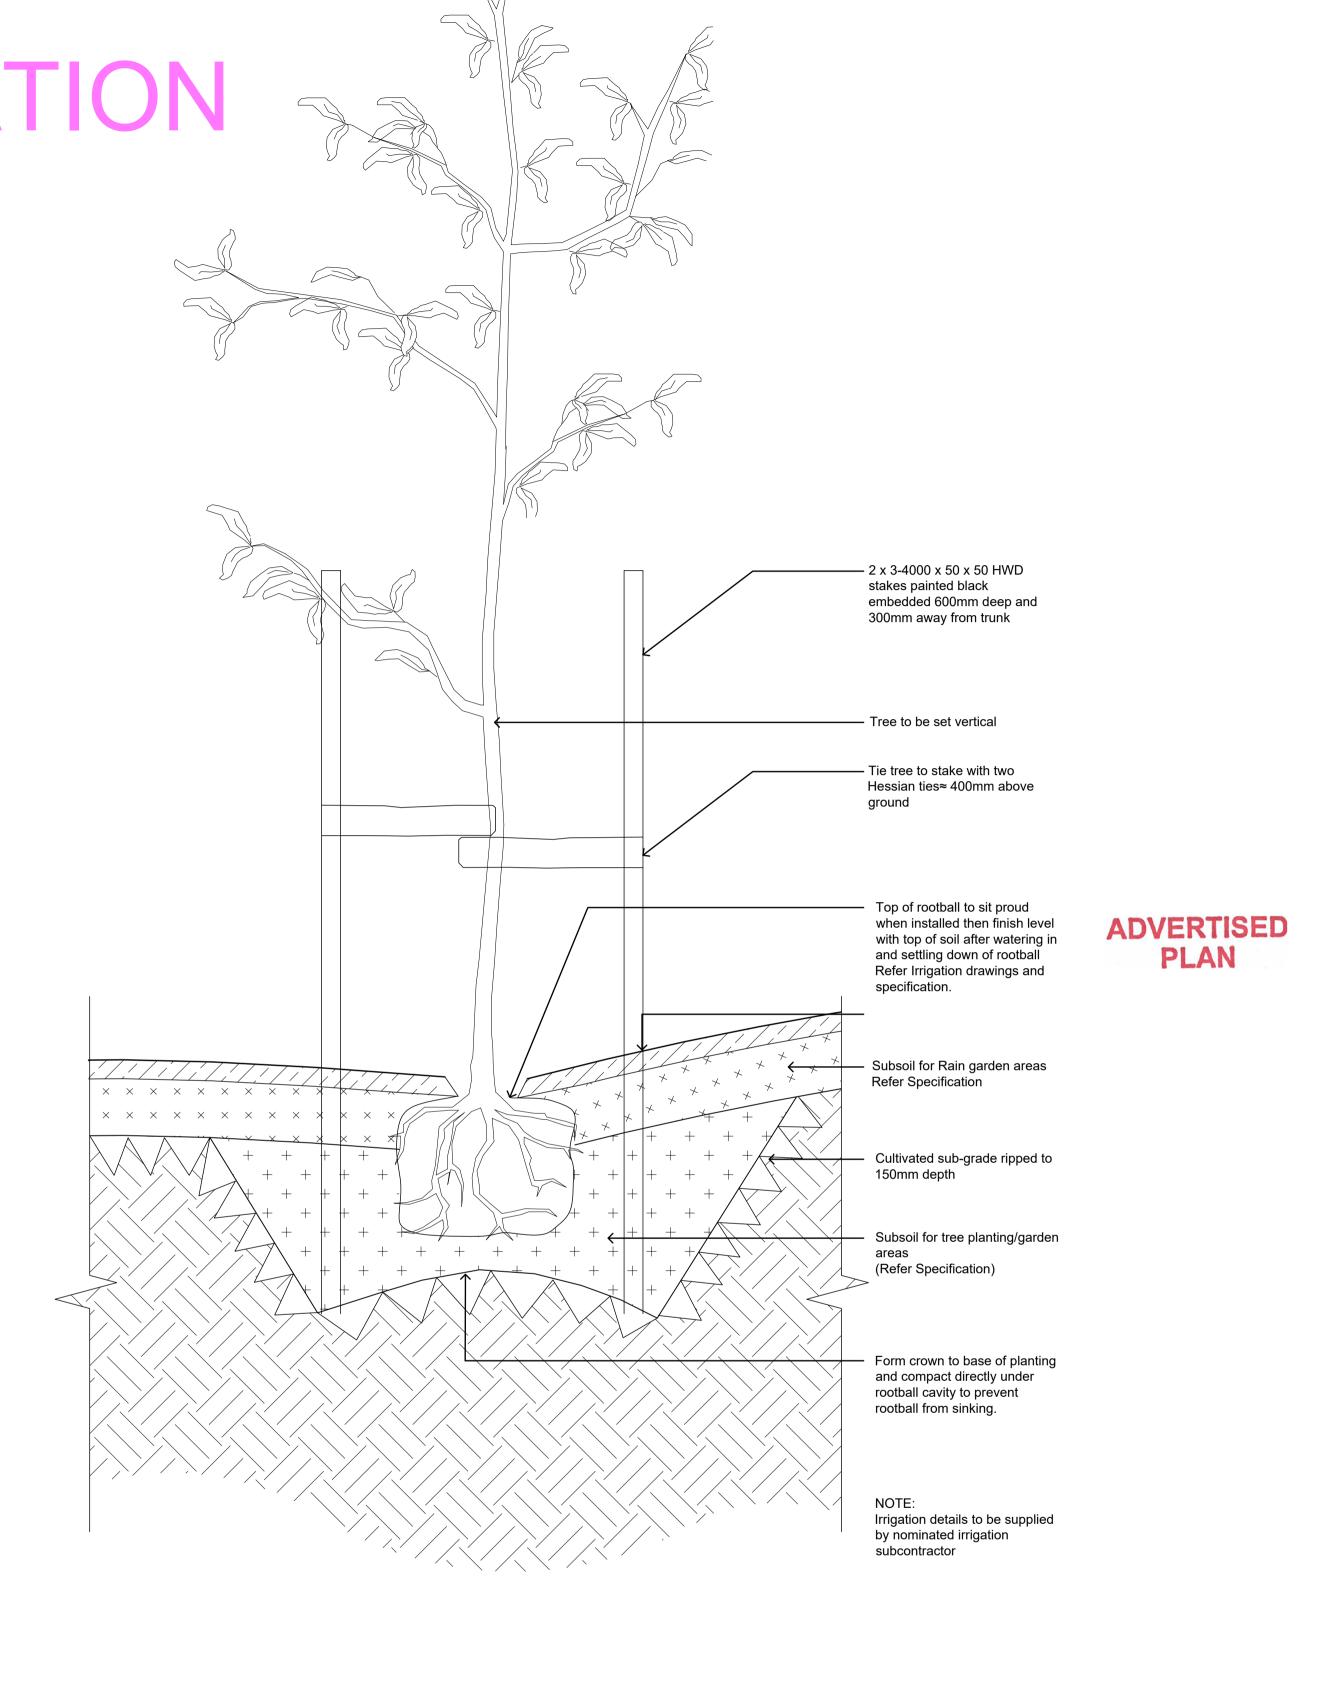

02 TREE PLANTING IN DEEP SOIL GARDEN
Scale 1:10



SHEET TITLE REV NO DATE DESCRIPTION PROJECT INFORMATION **DETAILS - PLANTING** E1 05.08.24 FOR ENDORSEMENT **VICTORIA STREET DEVELOPMEN** 342-348 VICTORIA STREET BRUNSWICK, VIC 3029 DRAWN BY PLOT DATE SCALE @ A1 NORTH 05.08.2024 1:10@A1 ISSUE APPROVED PROJECT NO SHEET NO. **REV NO** L604 2302 E1 FOR ENDORSEMENT

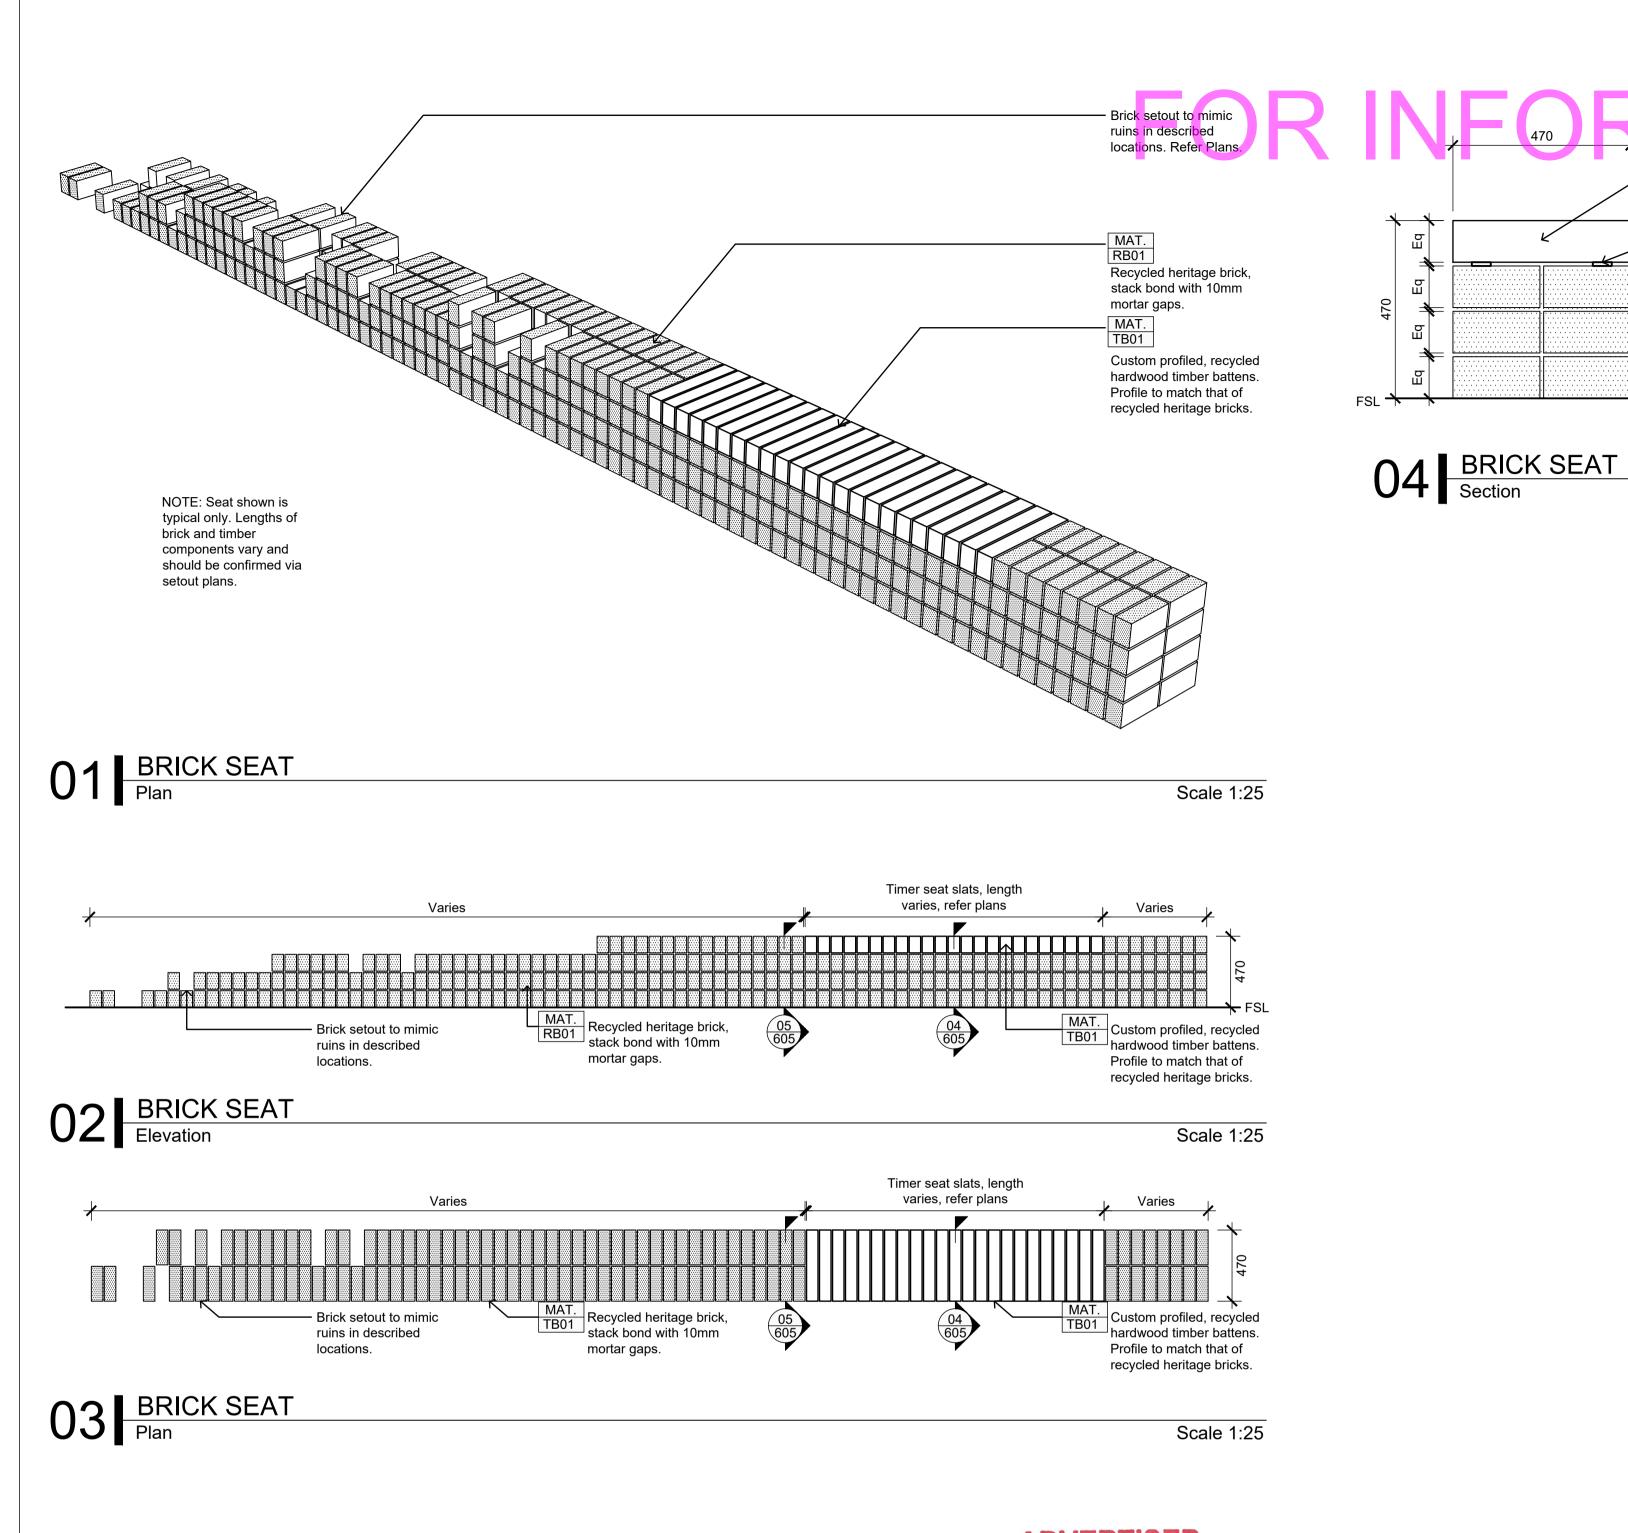

NOTES

mala

ADVERTISED PLAN

RE	V NO	DATE	DESCRIPTION	PROJECT INFORMATION	SHEET TITLE			
	E1	05.08.24	FOR ENDORSEMENT	VICTORIA STREET DEVELOPMENT	DETAILS - BRICK SEATS			
				342-348 VICTORIA STREET				
				BRUNSWICK, VIC 3029				
					DRAWN BY	PLOT DATE	SCALE @ A1	NORTH
					AY	05.08.2024	As Shown	
				ISSUE	APPROVED	PROJECT NO	SHEET NO.	REV NO
				FOR ENDORSEMENT	ВВ	2302	L614	E1

 Custom profiled, recycled hardwood timber battens.
 Profile to match that of recycled heritage bricks.

- 50x10 Mill Finish 316 Flat Bar, Fix timber battens from beneath and countersink fixing heads into flat bar. Fix

battens and flat bar assembly

to bricks below. Utilise gap

between timbers to fix

fasteners appropriately.

Recycled heritage brick,

gaps.

stack bond with 10mm mortar

Scale 1:10

assembly and select

470


05 BRICK SEAT
Section

Recycled heritage brick,


stack bond with 10mm mortar

Scale 1:10


FOR INFORMATION

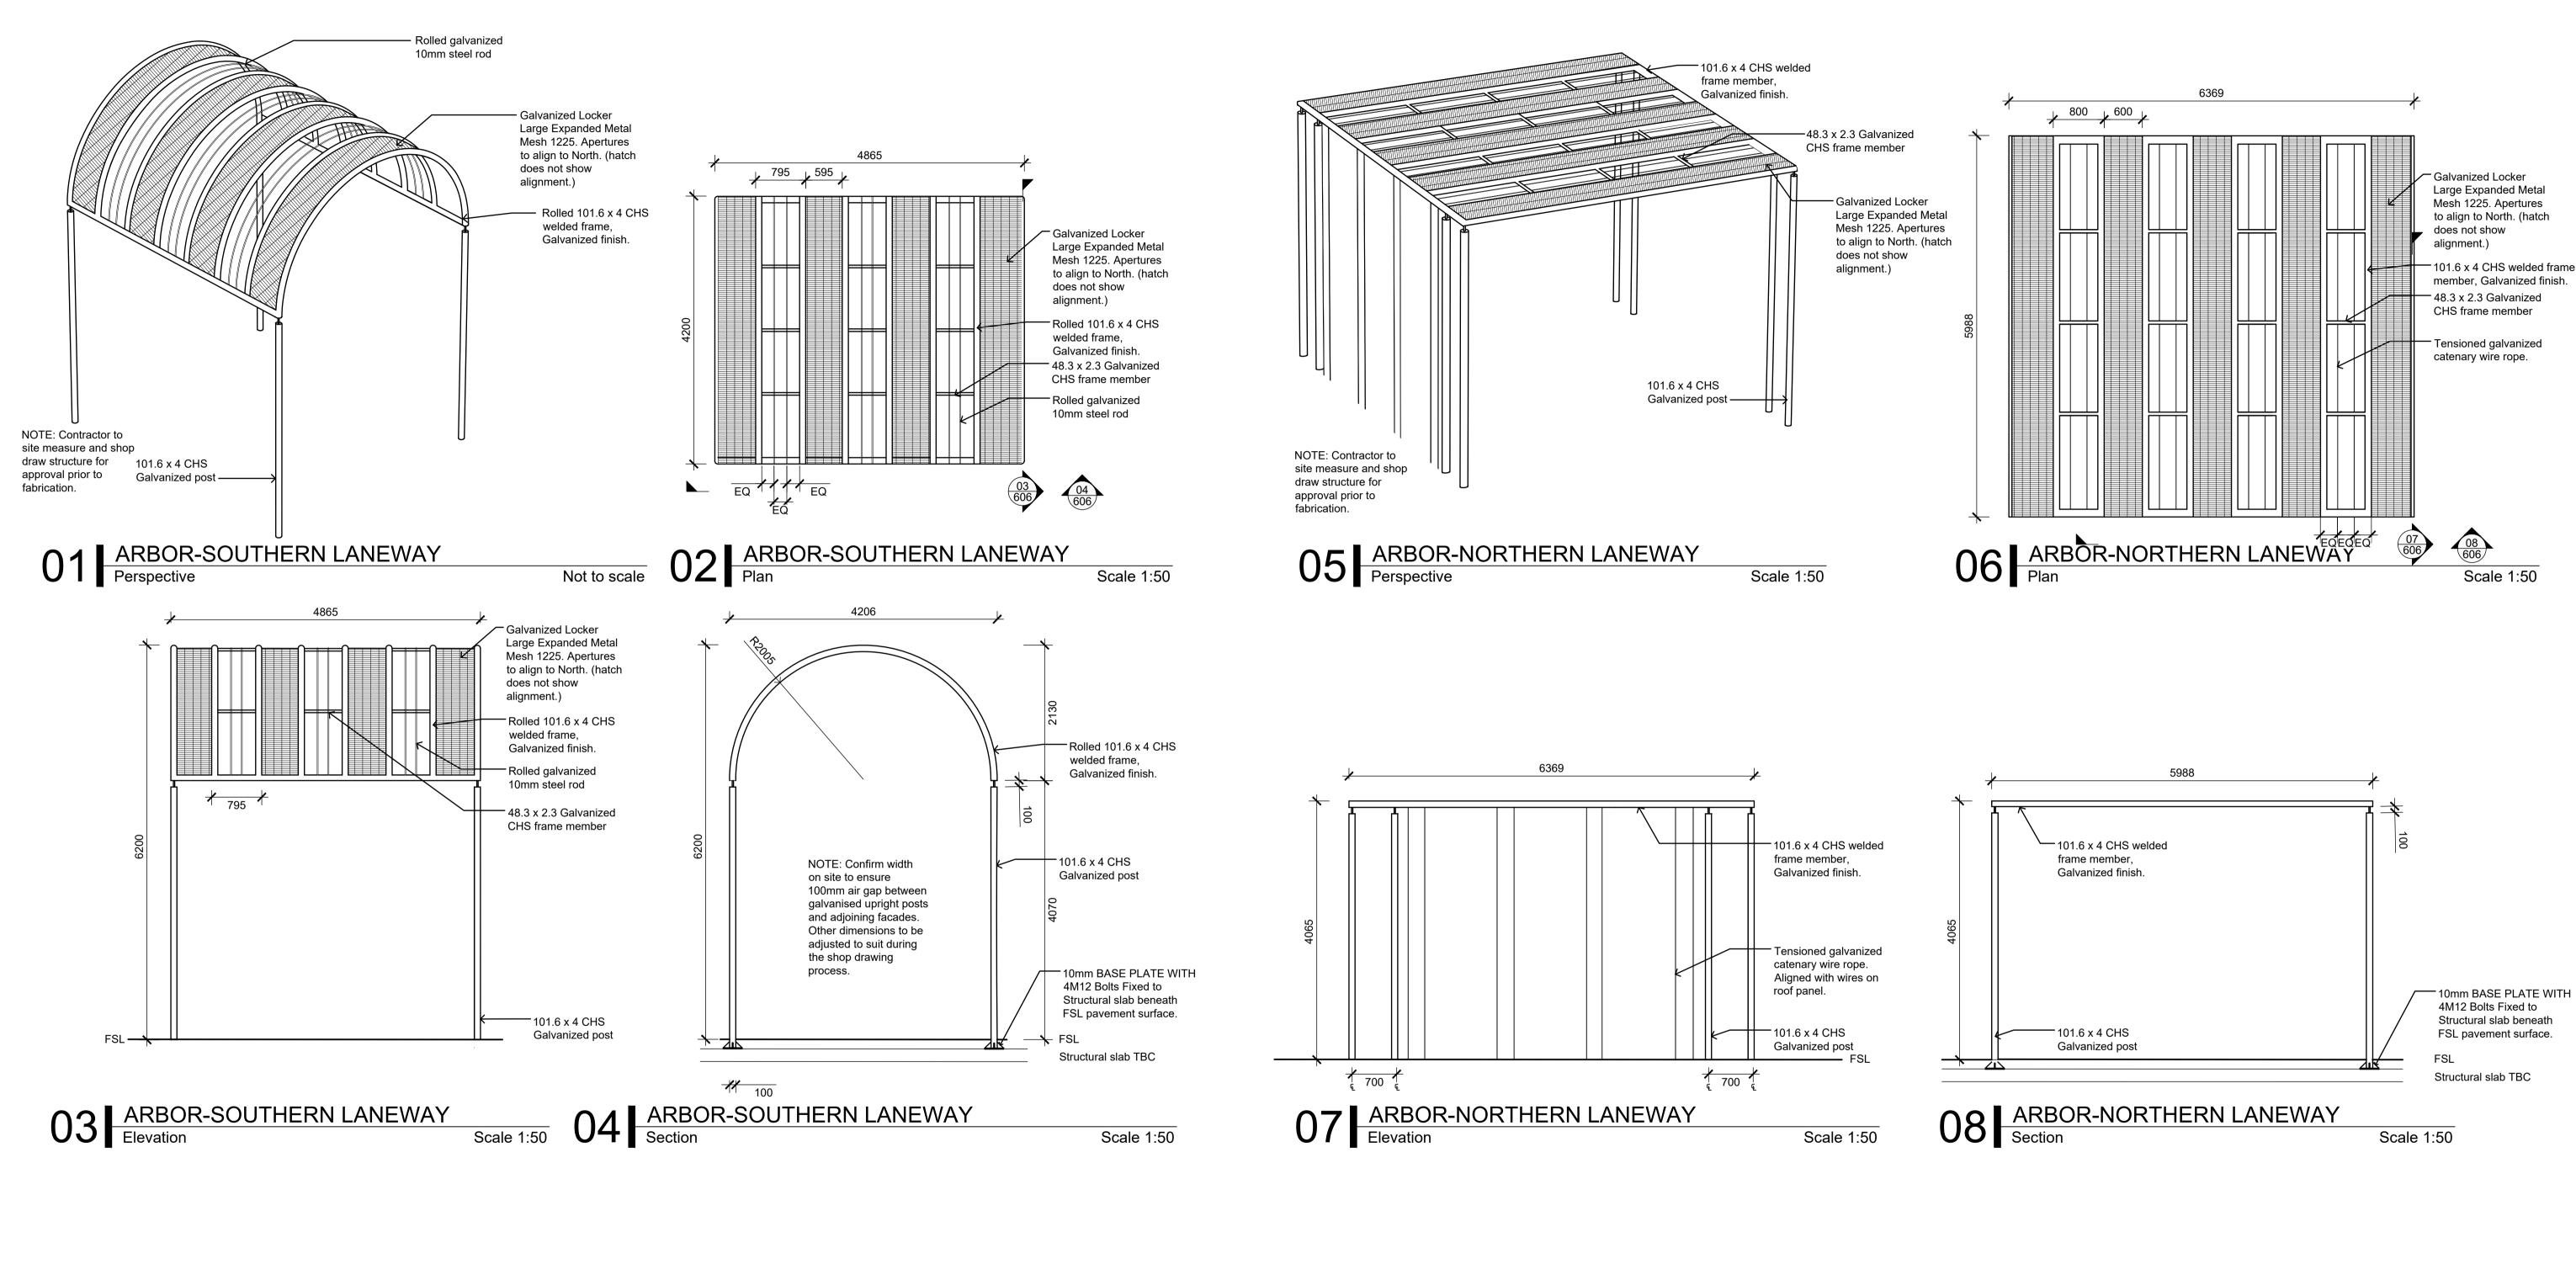


ADVERTISED PLAN

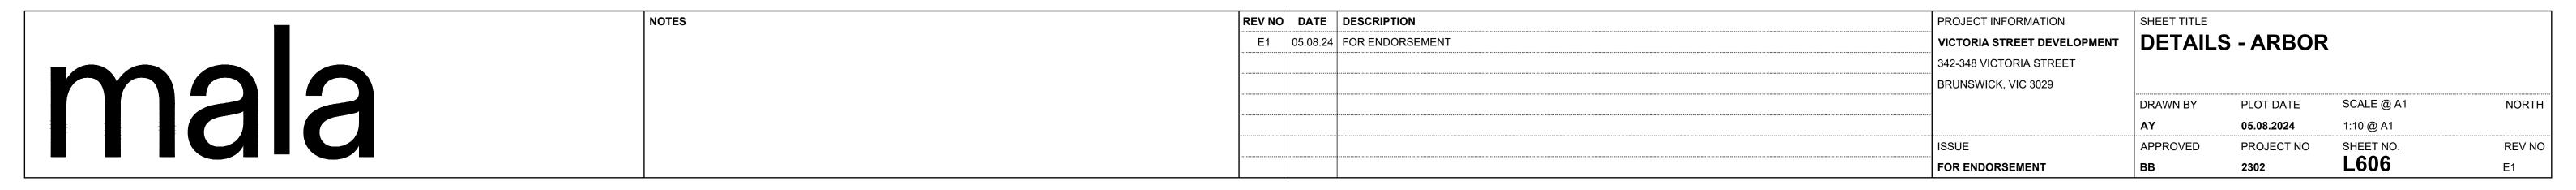



FOR INFORMATION

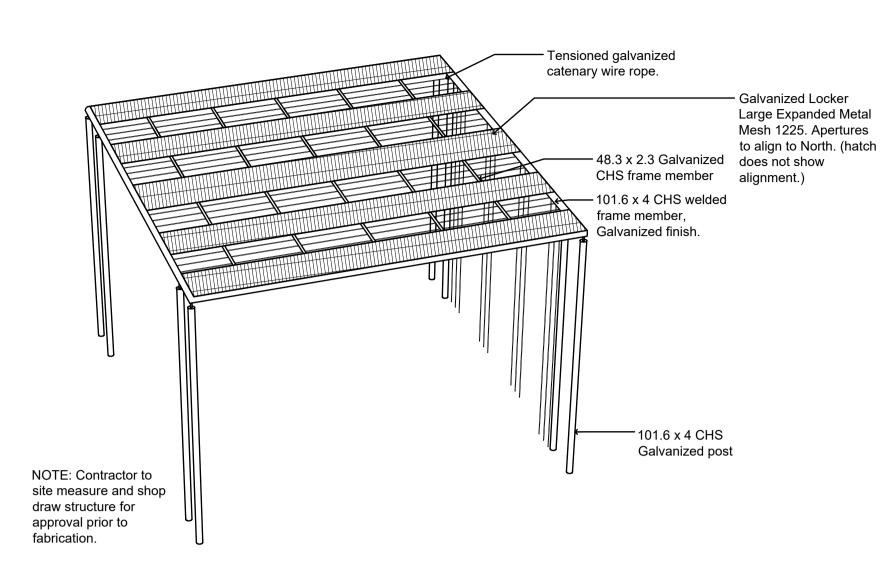

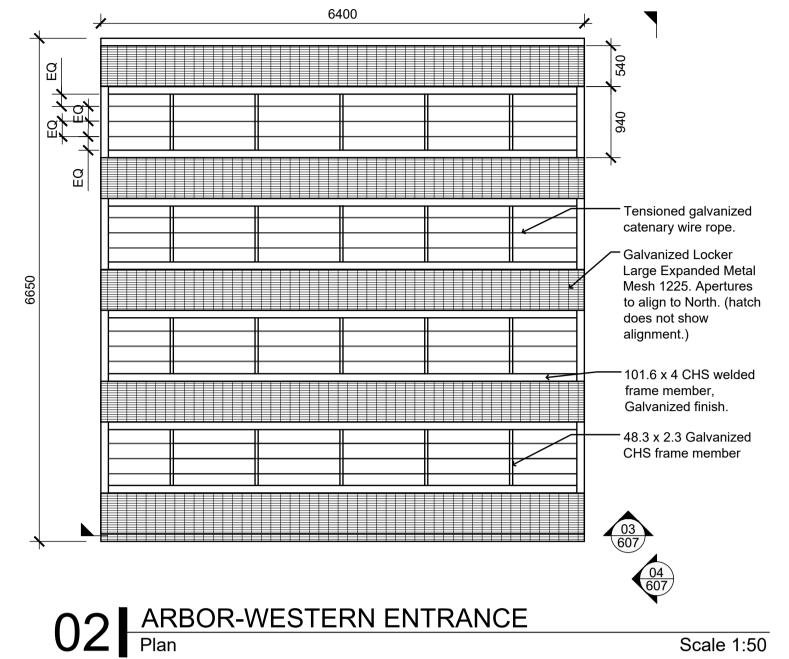

01 ARBOR-WESTERN ENTRANCE
Perspective Scale 1:50

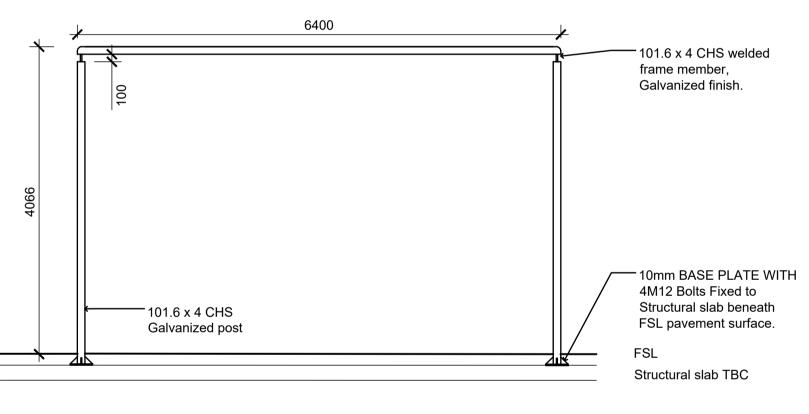

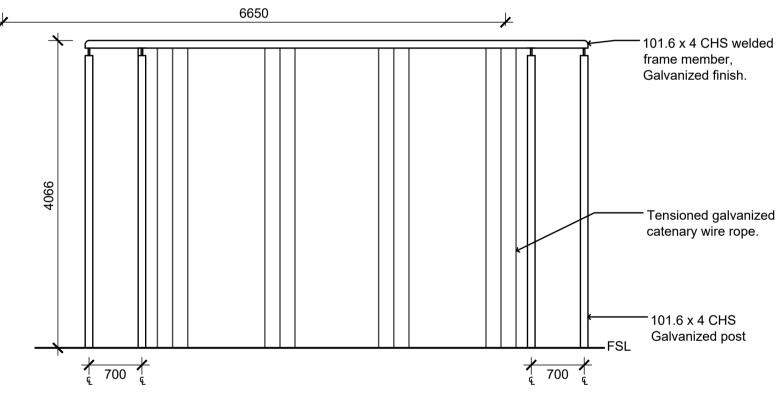

Scale 1:50

03 ARBOR-WESTERN ENTRANCE
Section

04 ARBOR-WESTERN ENTRANCE
Elevation

ADVERTISED PLAN

Scale 1:50

NOTES

REV NO	DATE	DESCRIPTION	PROJECT INFORMATION	SHEET TITLE			
E1	05.08.24	FOR ENDORSEMENT	VICTORIA STREET DEVELOPMENT	DETAILS	- ARBOR		
			342-348 VICTORIA STREET				
			BRUNSWICK, VIC 3029				
				DRAWN BY	PLOT DATE	SCALE @ A1	NORTH
				AY	05.08.2024	As Shown	
			ISSUE	APPROVED	PROJECT NO	SHEET NO.	REV NO
			FOR ENDORSEMENT	ВВ	2302	L607	E1