VICTORIA STREET DEVELOPMENT LANDSCAPE DRAWINGS FOR ENDORSEMENT AUGUST 2024

PREPARED BY:

MALA STUDIO

1/11 AMSTERDAM STREET RICHMOND VICTORIA 3047

FOR:

Assemble Victoria Street Development

342-348 VICTORIA STREET BRUNSWICK, VICTORIA 3056

ADVERTISED PLAN

LANDSCAPE DRAWINGS

No.	Title	Sheet	Scale
L000	TITLE SHEET	TITLE	N/A
L001	GENERAL NOTES & SCHEDULES	INFORMATION	N/A
L002	SITE PLAN - GROUND FLOOR	PLAN	1:200 @ <i>P</i>
L003	SITE PLAN - LEVEL 1	PLAN	1:200 @ <i>A</i>
L004	SITE PLAN - ROOF PLAN	PLAN	1:200 @ <i>F</i>
L101	SETOUT - SHEET 1/4	PLAN	1:100 @ A
L102	SETOUT - SHEET 2/4	PLAN	1:100 @ <i>F</i>
L103	SETOUT - SHEET 3/4	PLAN	1:100 @ <i>A</i>
L104	SETOUT - SHEET 4/4	PLAN	1:100 @ <i>F</i>
L201	GRADING - SHEET 1/4	PLAN	1:100 @ <i>F</i>
L202	GRADING - SHEET 2/4	PLAN	1:100 @ <i>F</i>
L203	GRADING - SHEET 3/4	PLAN	1:100 @ <i>A</i>
L204	GRADING - SHEET 4/4	PLAN	1:100 @ <i>A</i>
L301	SURFACES - SHEET1/4	PLAN	1:100 @ <i>A</i>
L302	SURFACES - SHEET2/4	PLAN	1:100 @ <i>F</i>
L303	SURFACES - SHEET3/4	PLAN	1:100 @ <i>A</i>
L304	SURFACES - SHEET4/4	PLAN	1:100 @ <i>F</i>
L400	PLANTING SCHEDULES	SCHEDULE	N/A
L401	PLANTING - SHEET 1/4	PLAN	1:100 @ <i>F</i>
L402	PLANTING - SHEET 2/4	PLAN	1:100 @ <i>A</i>
L403	PLANTING - SHEET 3/4	PLAN	1:100 @ <i>A</i>
L404	PLANTING - SHEET 4/4	PLAN	1:100 @ <i>F</i>
L405	PLANTING - LEVEL 1	PLAN	1:200 @ <i>F</i>
L406	PLANTING - ROOF SPACES	PLAN	1:200 @ <i>A</i>

LANDSCAPE DETAILS, SCHEDULES & DOCUMENTS

No.	Title	Sheet	Scale
L501	SECTIONS - CENTRAL COMMONS	SECTION	AS SHOWN
L502	SECTIONS - SOUTHERN LANEWAY	SECTION	AS SHOWN
L503	SECTIONS - NORTHERN LANEWAY	SECTION	AS SHOWN
L601	DETAILS - HARD DETAILS	DETAIL	AS SHOWN
L602	DETAILS - SOFT DETAILS	DETAIL	AS SHOWN
L603	DETAILS - DECK SEAT	DETAIL	AS SHOWN
L604	DETAILS - PLANTING	DETAIL	AS SHOWN
L605	DETAILS - BRICK SEATS	DETAIL	AS SHOWN
L606	DETAILS - ARBORS	DETAIL	AS SHOWN
L607	DETAILS - ARBOR	DETAIL	AS SHOWN
L700	MATERIAL SCHEDULE	SCHEDULE	N/A

ATTACHMENTS

Sheets	litle	Issue	Scale
1 - 4	IRRIGATION DRAWINGS	P1	AS SHOWN

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NORTH

REV NO

NOTES	NO D	DATE DESCRIPTION	PROJECT INFORMATION	SHEET TITLE		
E1	1 05	5.08.24 FOR ENDORSEMENT	VICTORIA STREET DEVELOPMENT	TITLE SI	HEET	
			342-348 VICTORIA STREET			
			BRUNSWICK, VIC 3029			
				DRAWN BY	PLOT DATE	SCALE @ A1
				AY	05.08.2024	N/A
			ISSUE	APPROVED	PROJECT NO	SHEET NO.
			FOR ENDORSEMENT	ВВ	2302	L000

TECHNICAL NOTES

Plan General Notes

- These drawing shall be read in conjunction with documentation provided by other consultants.
- These drawing shall be read in conjunction with the Landscape Specification (L800)
- Plan drawings containing general set out information can be obtained in Autocad format upon request from the contractor.
- The contractor and subcontractors shall verify all dimensions, lines, levels, and existing service locations prior to commencement on site, preparation of detail/ shop drawings and fabrication of construction/building components.
- Digital Setout to be provided for accurate setout of all landscape items on request.

Detail General Notes

- The contractor and subcontractors shall verify all dimensions, lines, levels, and existing service locations prior to commencement on site, preparation of detail/ shop drawings and fabrication of construction/building components.
- The contractor must verify all dimensions prior to fabrication and installation. If any anomalies arise the contractor is to advise the superintendent immediately.
- All dimensions are in mm. Do not scale off drawings.
- Contractor is to provide shop drawings (CAD drafted to scale with adequate notes and dimensions for review and fabrication) to the Engineer and Landscape Architect for approval. Fixing components and details to be confirmed through shop drawing process.
- Contractor is to dispose of any contaminated material removed from site
- All proprietary items are to be installed and fixed in accordance with the manufacturers specifications and instructions.
- All work is to be carried out in accordance with all Work-cover requirements and occupational health and safety act regulations.

Australian Standards:

Unless specified to the contrary, materials, installation and construction practice shall be in accordance with the requirements of the latest editions of the following standards as appropriate:

Steel materials, construction, fabrication and erection: To AS 4100.

Concrete materials, construction, fabrication and erection: To AS 3600. Formwork design and construction, formed surfaces: To AS 3610 and AS 3610.1.

Plywood formwork: To AS 6669.

concrete handbook).

Profiled steel sheeting, including shear connectors: To AS 2327.1.

Residential ground slabs and footings: To AS 2870.

Concrete structures for retaining liquids: To AS 3735.

Precast members: Conform to the recommendations of NP:PCH (Precast

- Transport, erection and installation: To AS 3850.
- Precast flooring: To AS 3600.
- Strand, bar and wire: To AS/NZS 4672.1
- AS 1012 Methods of Testing Concrete
- AS 1302 Steel Reinforcing Bars for Concrete
- AS 1379 The Specification and Manufacture of Concrete
- AS 1554 SAA Structural Steel Welding Code
- AS 3600 Concrete Structures
- AS4100 Steel Structures

Where there are differences between the requirements of the Specification or the Drawings and the above Standards, the Specification or Drawings shall take precedence where more onerous.

Materials or operations not covered by the above Standard Codes and Specifications shall conform to the appropriate Australian Standard, or if no such Standard exists they shall conform to the Standards laid down by the ASTM.

Soil: On structure and raised planter

All soil profiles shall be to a proprietary Fytogreen system or approved equivalent. Refer Specification.

Soil : Deep soil

High quality imported soil, suitable for the establishment and on going viability of the selected vegetation, free of weed propagules and of contaminants and meeting all the criteria of natural soil and soil blends in AS4419 unless specified differently in this document.

Irrigation

Sub-surface irrigation is to be designed and installed to <u>all</u> planted garden beds within public and private areas on title, including those on structure (across all levels) and those in deep soil areas, as documented by Irrigation Contractor.

The Irrigation Contractor shall determine the water demands, available water supply location, size, pressures and flows and design an automatic sub-surface irrigation system to service the garden bed areas and planters designated on the drawings.

The Irrigation Contractor is to coordinate with The Contractor to ensure the provision for all pipes and conduits from points of water supply to garden bed areas in order to facilitate the construction of the irrigation system.

The irrigation design will need to consider the joint use of mains water supply and collected stored water as per the Sustainability management plan. Refer to Civil documentation for storage tank, drainage and connection locations.

The Irrigation contractor is to design and supply a maintenance schedule compatible with the long term, successful use of the irrigation system including tasks such as inspection intervals, flushing requirements and any other routine maintenance activities required through the life of the system.

Drainage

It is the responsibility of the contractor to ensure that all drainage meets manufacturers specifications. Refer Civil documentation for all drainage items.

Refer Engineers Drawings and Specifications for all Concrete performance strength, reinforcement and sub-base requirements.

Landscape Architect is responsible for colour and finish specifications only.

Planting

All plants must be laid out in accordance with planting plans and approved by Landscape architect prior to installation.

Stakes and ties

Generally: If plants are unable to be self supported or if stakes are damaged, stake or restake the plants as follows:

Drive stakes into the ground at least one third of their length, avoiding damage to the root system.

Stake sizes:

- For plants ≥ 2.5 m high: Three 50 x 50 x 3000mm stakes per plant [finalise length on site]
- For plants 1 2.5 m high: Two 50 x 50 x 1800 mm stakes per plant.
- For plants < 1 m high: One 38 x 38 x 1200 mm stake per plant.

Do not single stake large plants.

Removal: If plants are robust with well developed systems and are strong enough to no longer require support, remove stakes and ties.

Tree anchoring system: Plant using nominated tree anchoring system and stake as shown on Landscape Architect's drawings.

Weeding

Weeds: Unwanted plants and grasses considered invasive to the locality.

Program:

Trees and shrubs: As required for planted, paved and mulched areas to be weed free when observed at bi-weekly intervals.

Method: Clear and keep clear vigorous ground covers 200 mm from the base of any shrub or tree.

Small areas: By hand.

Herbicide application: Avoid windy days or if rain is likely to follow within 12 hours. Apply: To the manufacturer's instructions and material data and safety sheets. When the weather is humid with moderate temperatures and maximum sunlight.

Bicycle Parking

Bicycle parking dimensioned in accordance with Australian Standard for Parking Facilities – Bicycle Parking (AS2890.3) or otherwise justified by a suitably qualified professional to the satisfaction of the Responsible Authority.

Existing Trees:

All trees west of the site marked on the endorsed plans as being retained must have a Tree Protection Zone (TPZ) to the satisfaction of the Responsible Authority. The fencing associated with this TPZ must meet the following requirements:

Extent

The tree protection fencing (TPF) is to be provided to the extent of the identified TPZ.

If works are shown on any endorsed plan of this permit within the confines of the calculated TPZ, then the TPF must be taken in to only the minimum amount necessary to allow the works to be completed.

Fencing

All tree protection fencing required by this permit must be erected in accordance with the approved TPZ.

The TPF must be erected to form a visual and physical barrier and must be a minimum height of 1.5 metres and of chain mesh or similar fence with 1.8 metre support posts (e.g. treated pine or similar) every 3-4 metres, including a top line of high visibility plastic hazard tape erected around the perimeter of the fence.

Signage

Fixed signs are to be provided on all visible sides of the TPF clearly stating "Tree Protection Zone – No Entry", to the satisfaction of the Responsible Authority.

Irrigation

The area within the TPZ and TPF must be irrigated during the summer months with 1 litre of clean water for every 1cm of trunk girth measured at the soil/trunk interface on a weekly basis.

Access to TPZ

Should temporary access be necessary within the Tree Protection Zone during the period of construction, the Responsible Authority must be informed prior to relocating the fence (as it may be necessary to undertake additional root protection measures such as bridging over with timber).

Raised Planters:

Raised planter construction is to include, but not necessarily be limited to, the supply and installation of agricultural drains, waterproofing membranes, drainage cells at base, filter fabric, planting medium, mulch and irrigation. Planters must be effectively tanked and lined with core flute to prevent leaking. Drainage cells are to be provided at the base of the planter and are to be covered with a layer of filter fabric and a 100mm deep layer of Hydrocell Hard foam RG30.

A drainage outlet is to be installed in the base of the planter with the floor of the planter sloped towards it. Supply soil mix and spread evenly. Compact lightly and evenly in 150mm layers. Avoid differential subsidence and excess compaction and produce a finished surface that is graded evenly and ready for planting. Allow for min 50mm layer of specified mulch to top of beds and a finished level 25-50mm below the planter rim. Drip irrigation as specified is to be installed beneath the mulch layer.

WARNING AND DISCLAIMER

Beware of underground services.

The locations of underground services are approximate only and their exact location and level shall be proven on site by contractor prior to commencing works. No guarantee is given that all existing services are show.

Site setout shall be to Australian Map Grid (AMG). An electronic format of the drawings will be issued as an Autocad 2D file for the purposes of surveyed setout. Such files shall be issued under Superintendent written instruction.

All levels grades and dimensions shall be confirmed onsite prior to construction of works. If any discrepancies arise such instances shall be directed to the Superintendent for clarification and written confirmation.


Landscape Drawings shall be read in conjunction with all other consultant drawings and specifications and other written instructions as may be issued through the course of the tender and contract.


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ADVERTISED PLAN


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		342-348 VICTORIA STREET				
		BRUNSWICK, VIC 3029				
			DRAWN BY	PLOT DATE	SCALE @ A1	NORTH
			AY	05.08.2024	N/A	
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		FOR ENDORSEMENT	ВВ	2302	L001	E1





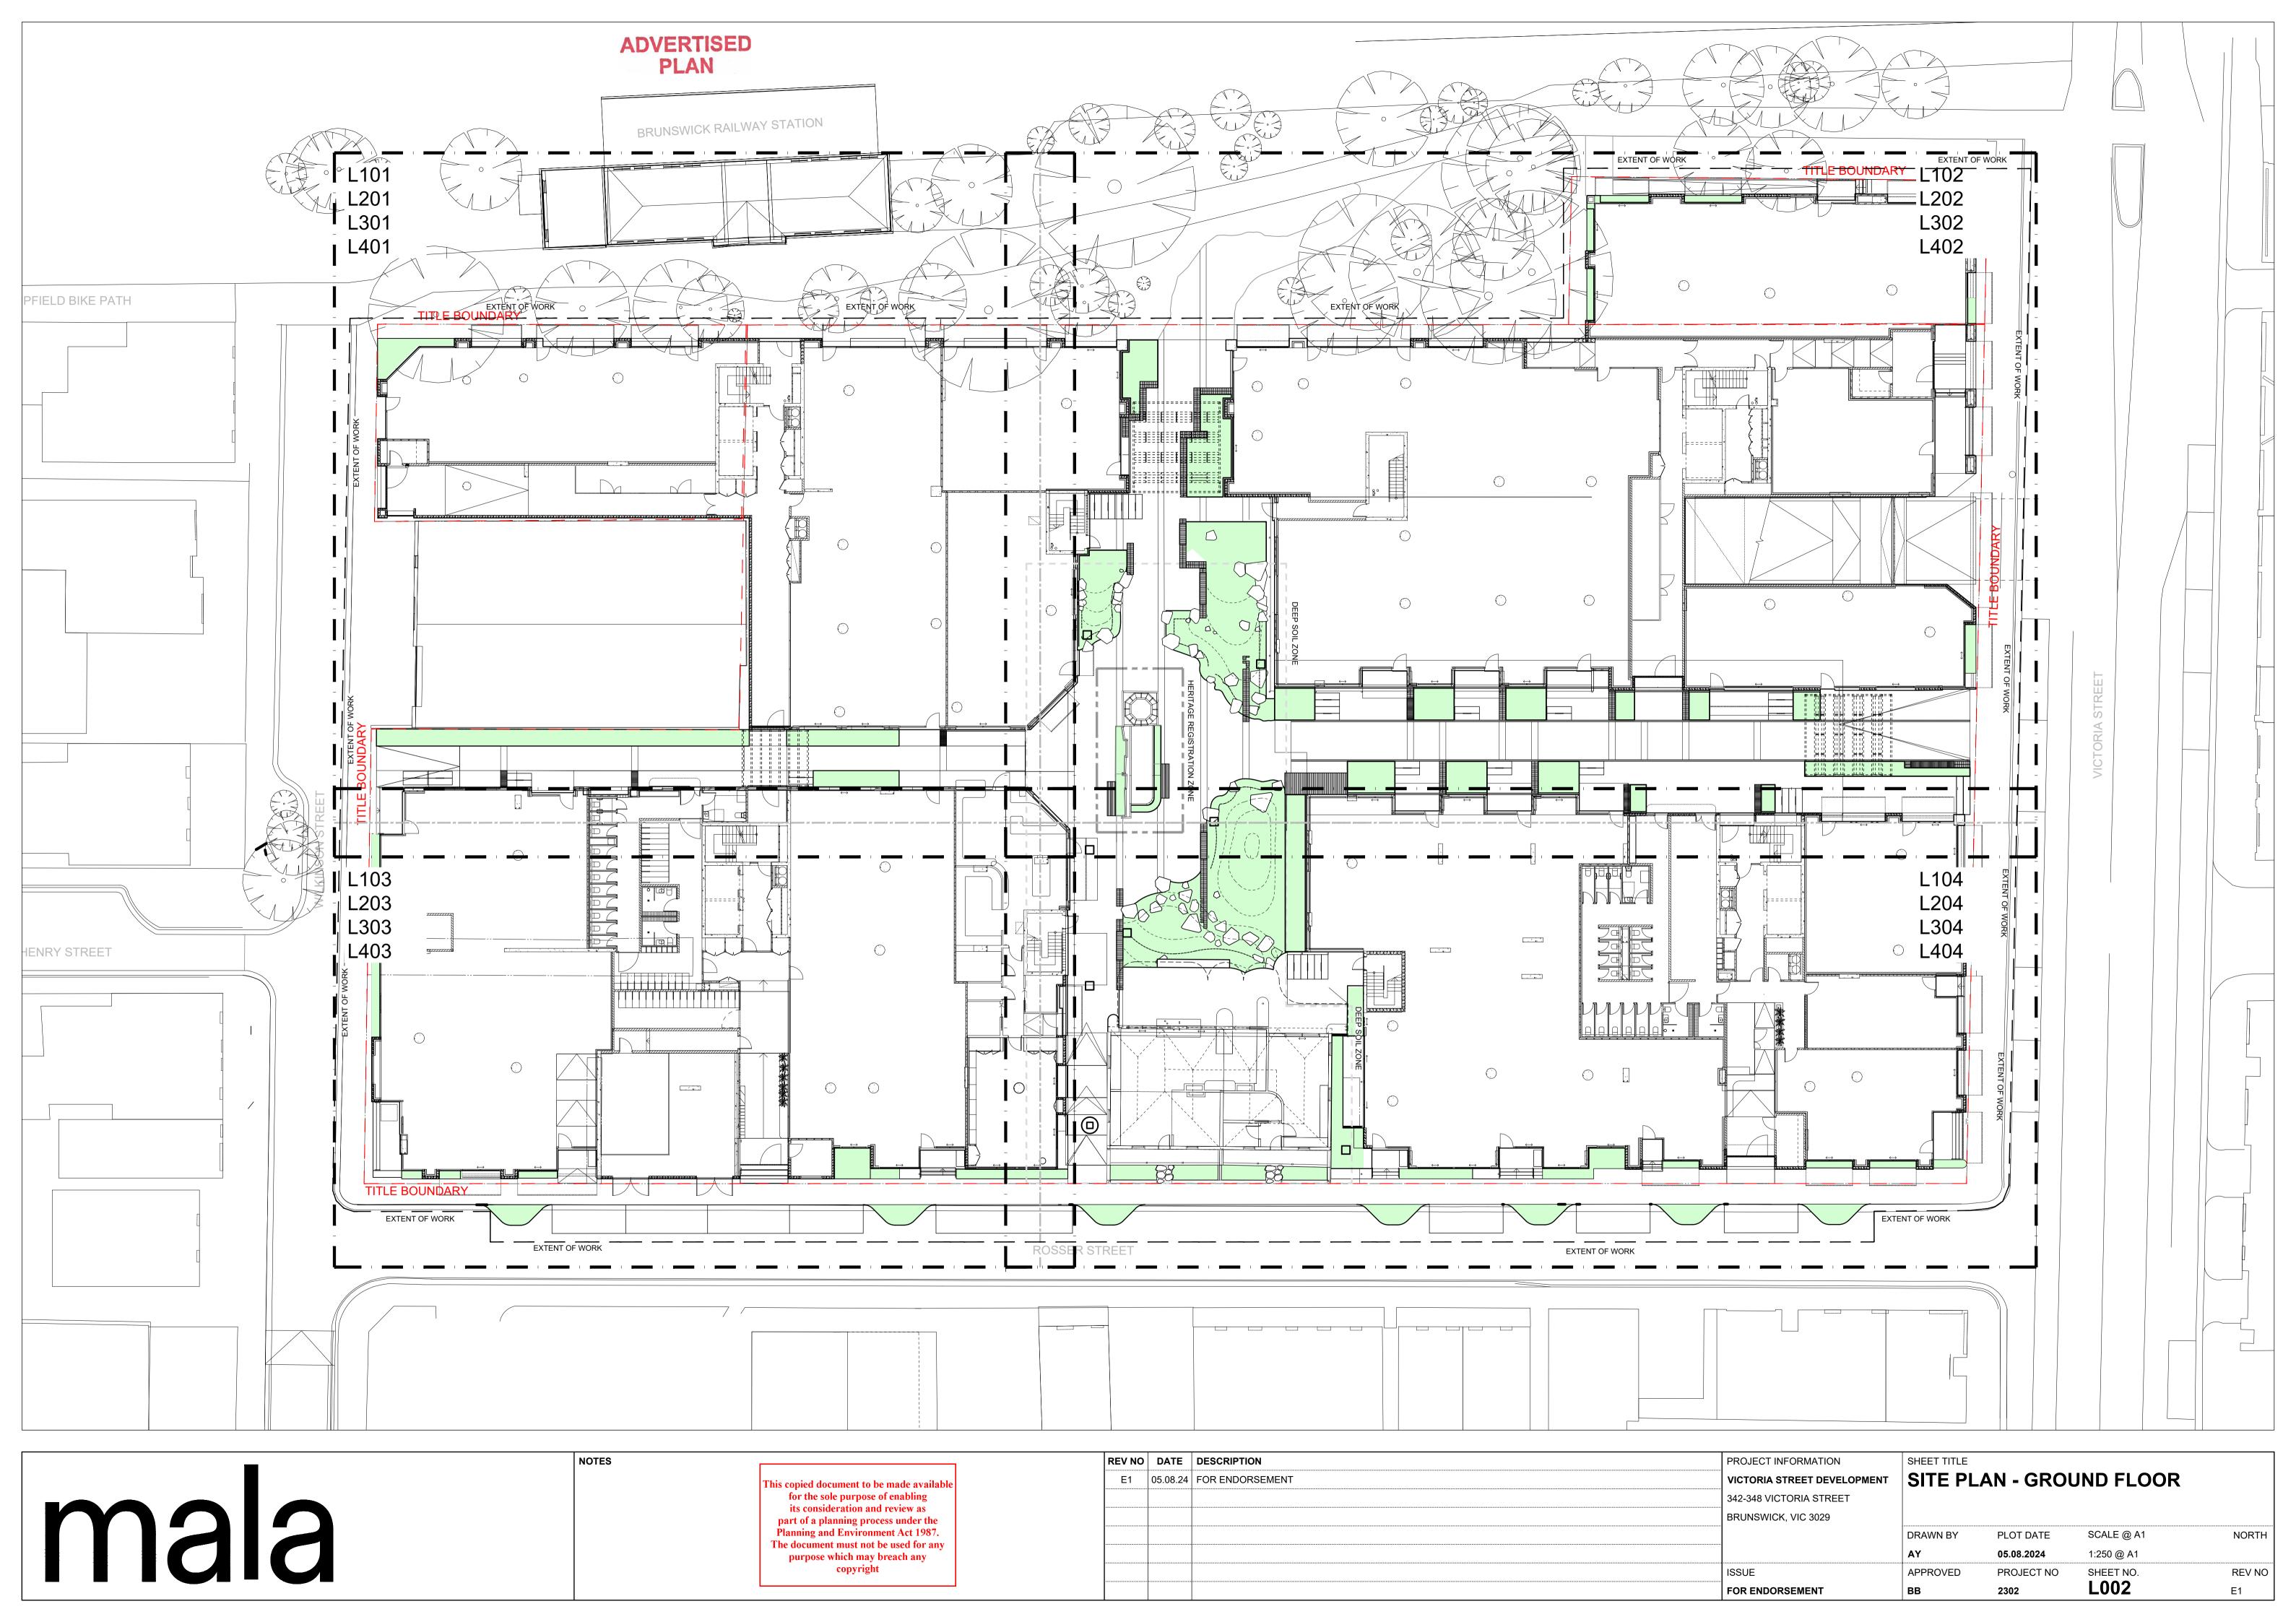

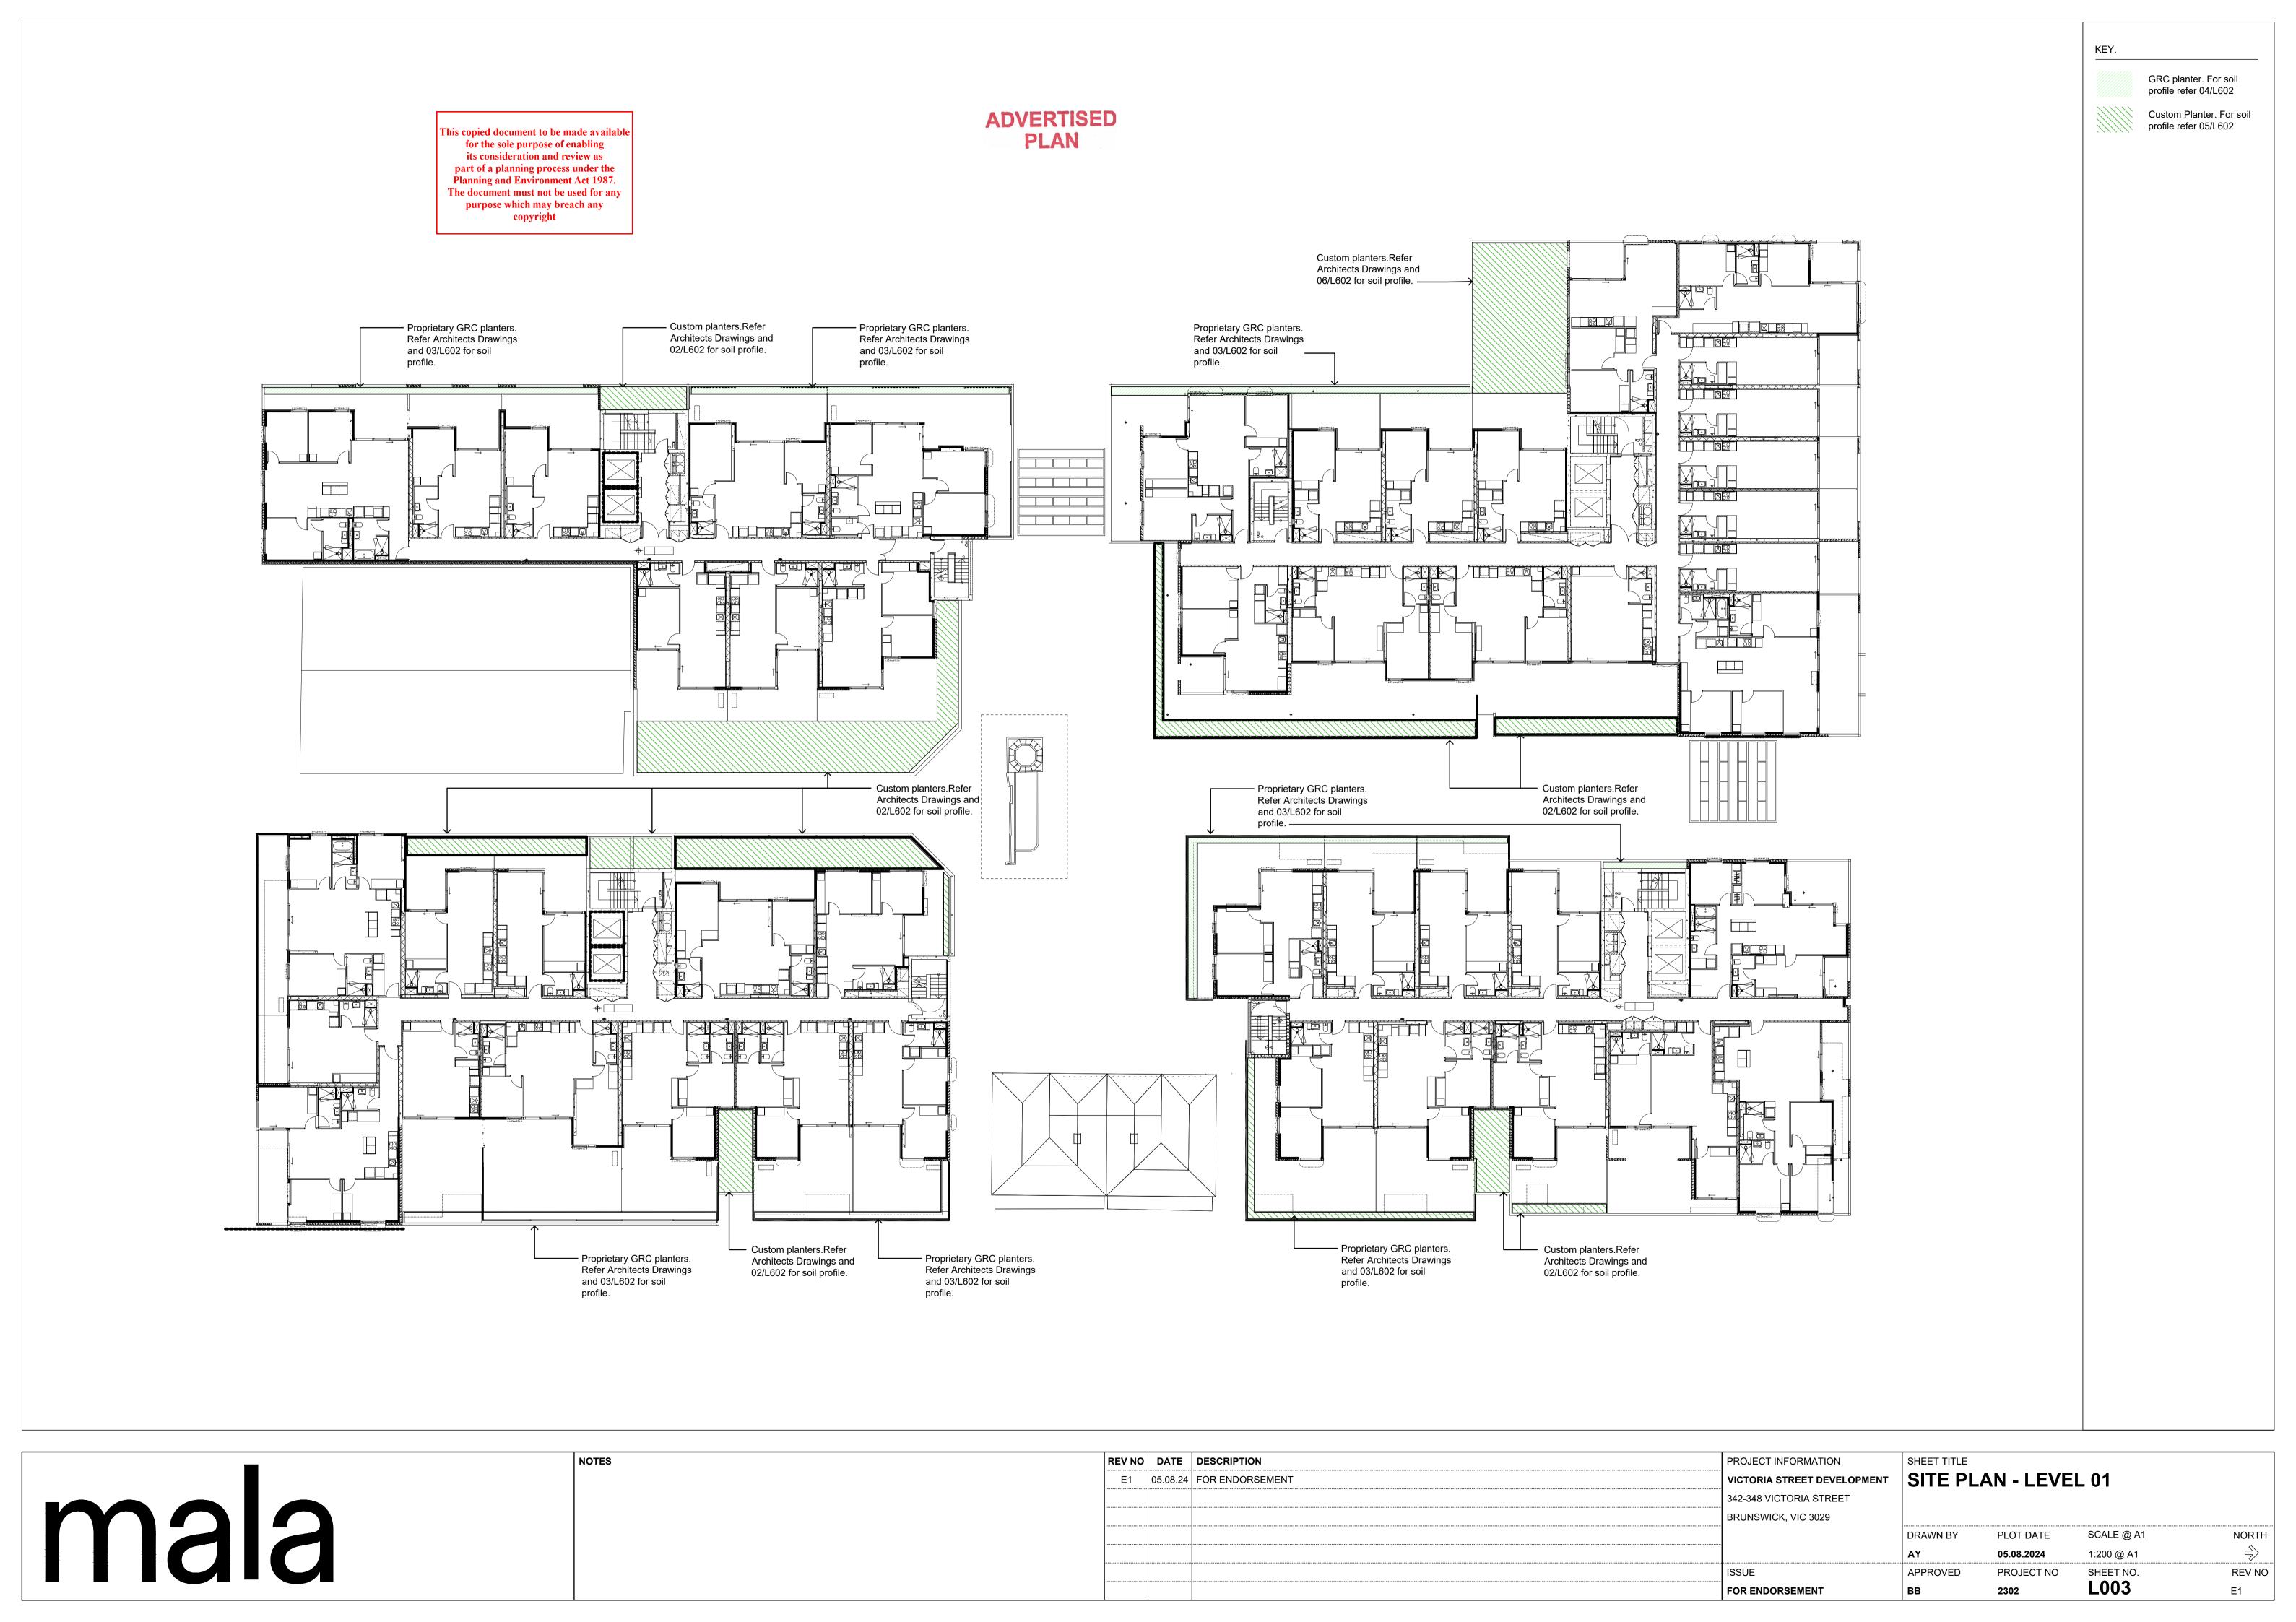


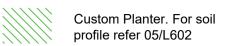


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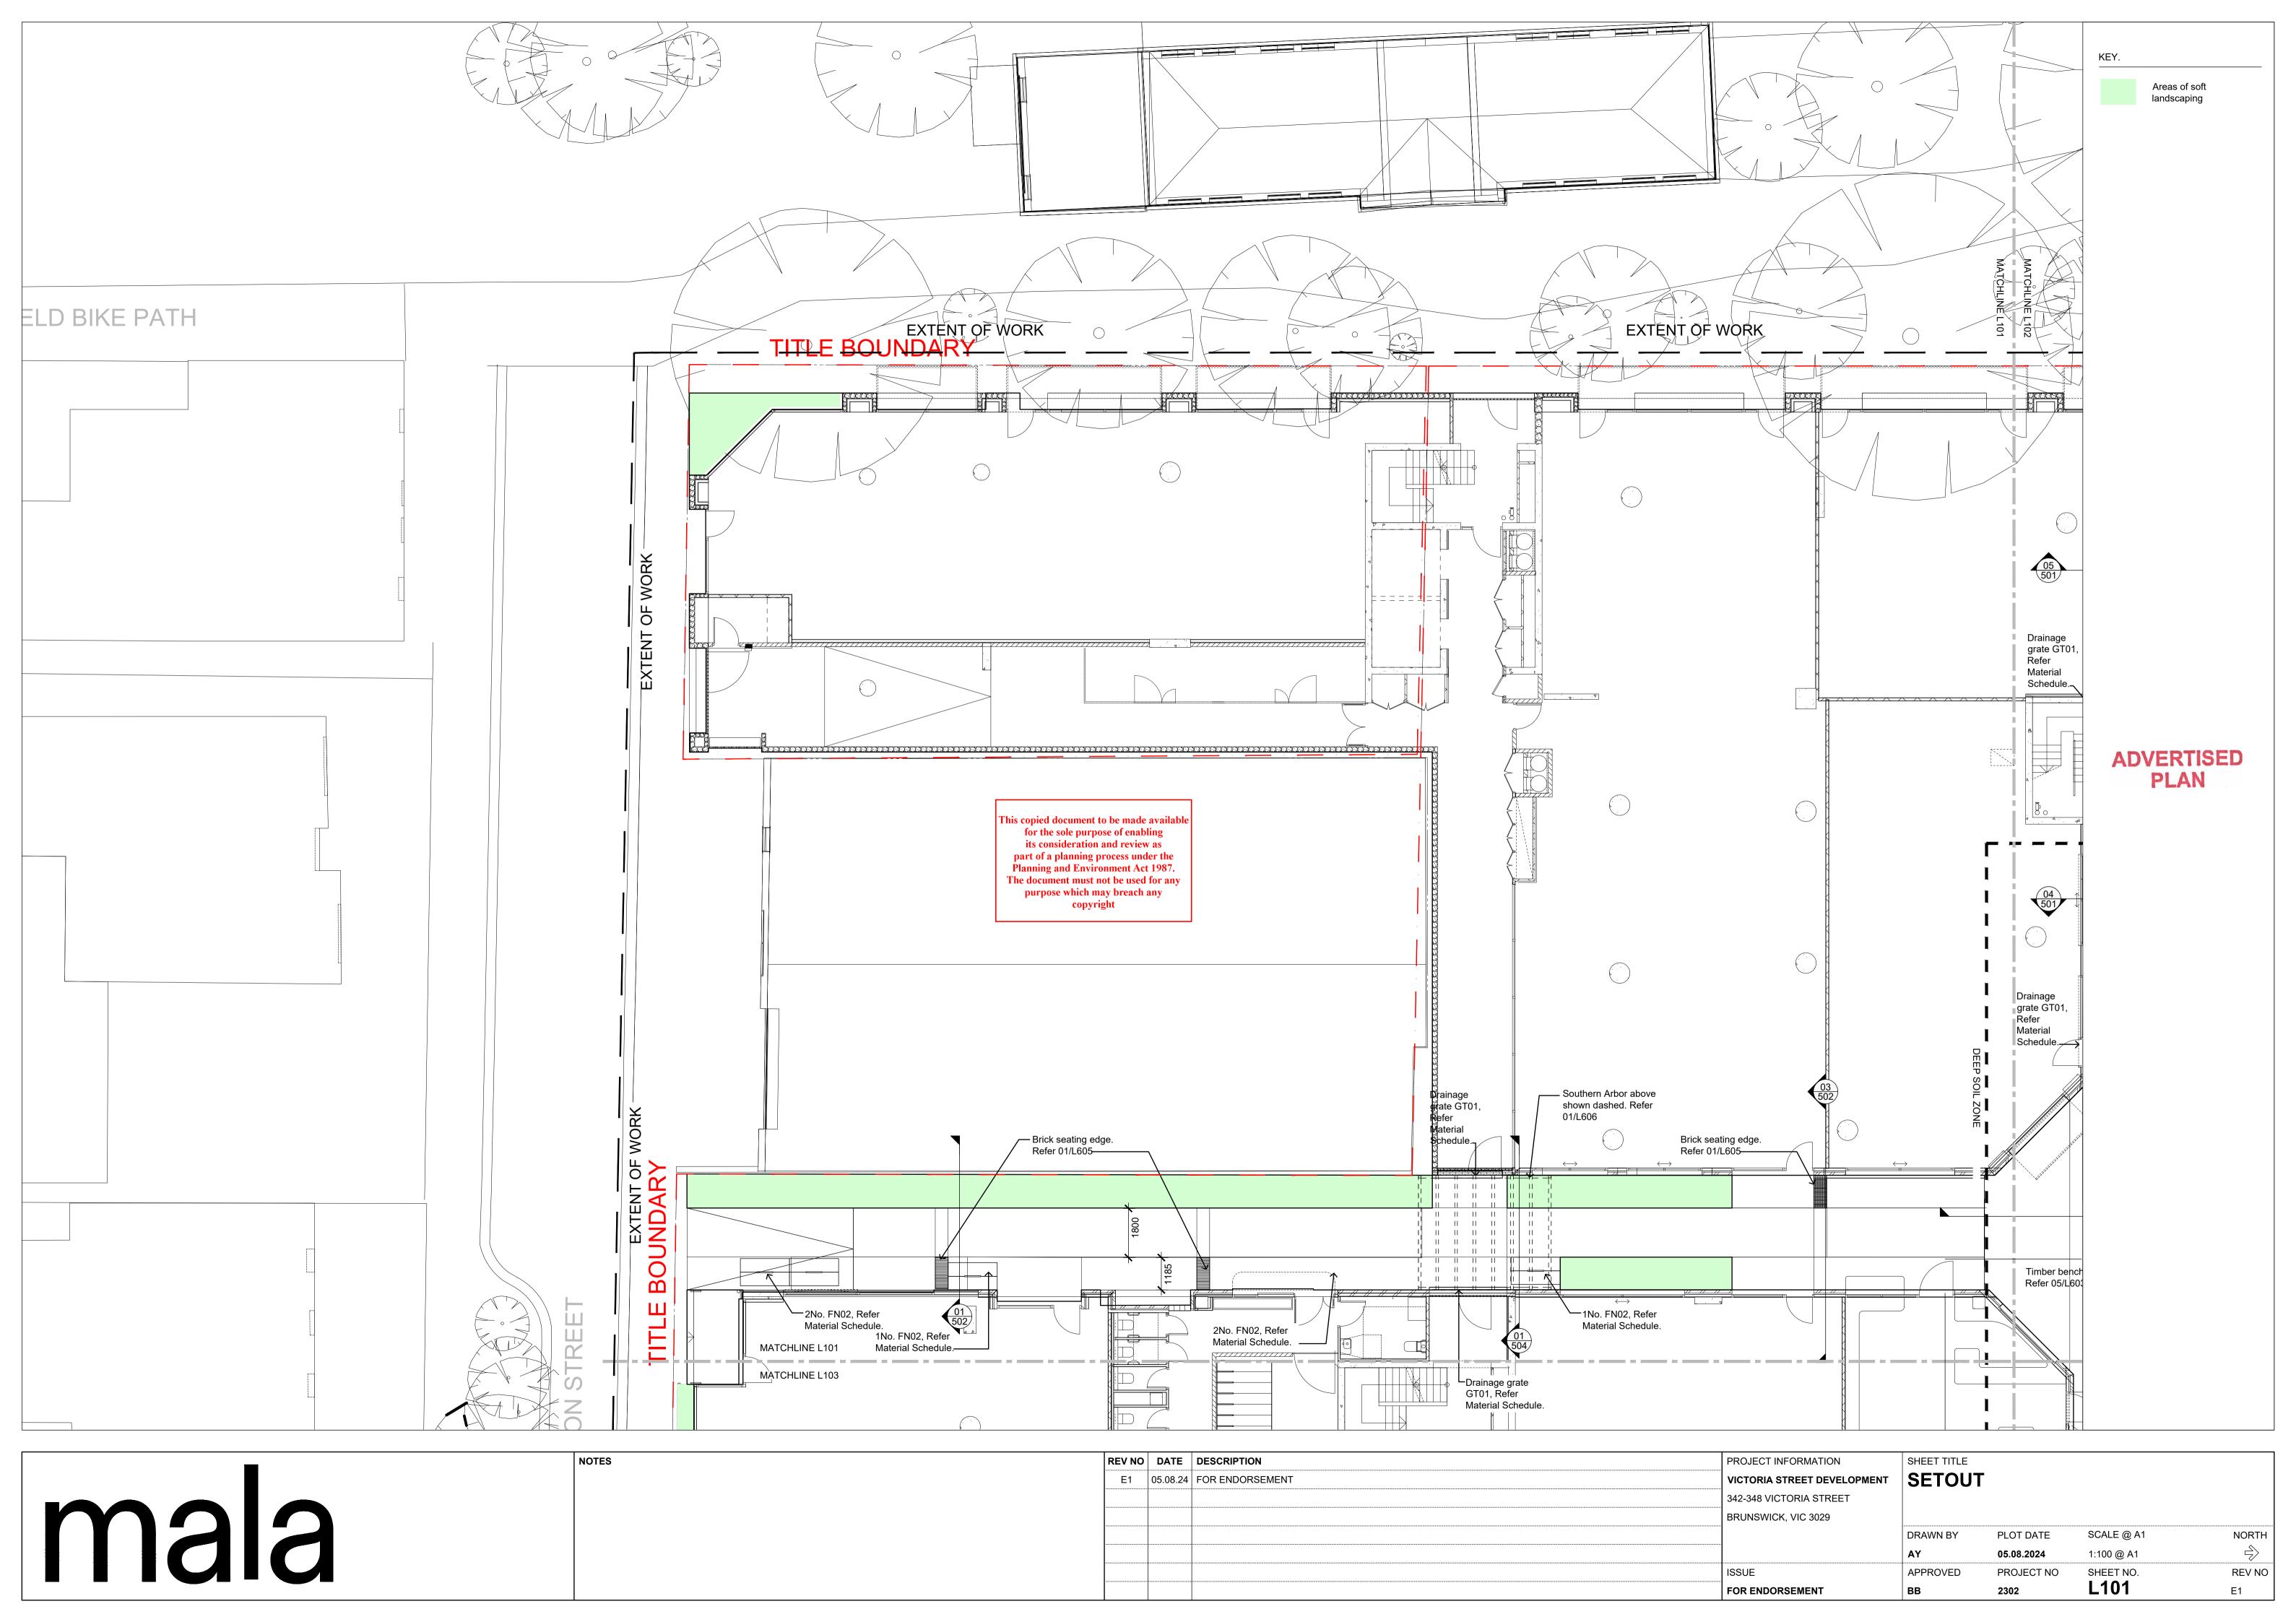






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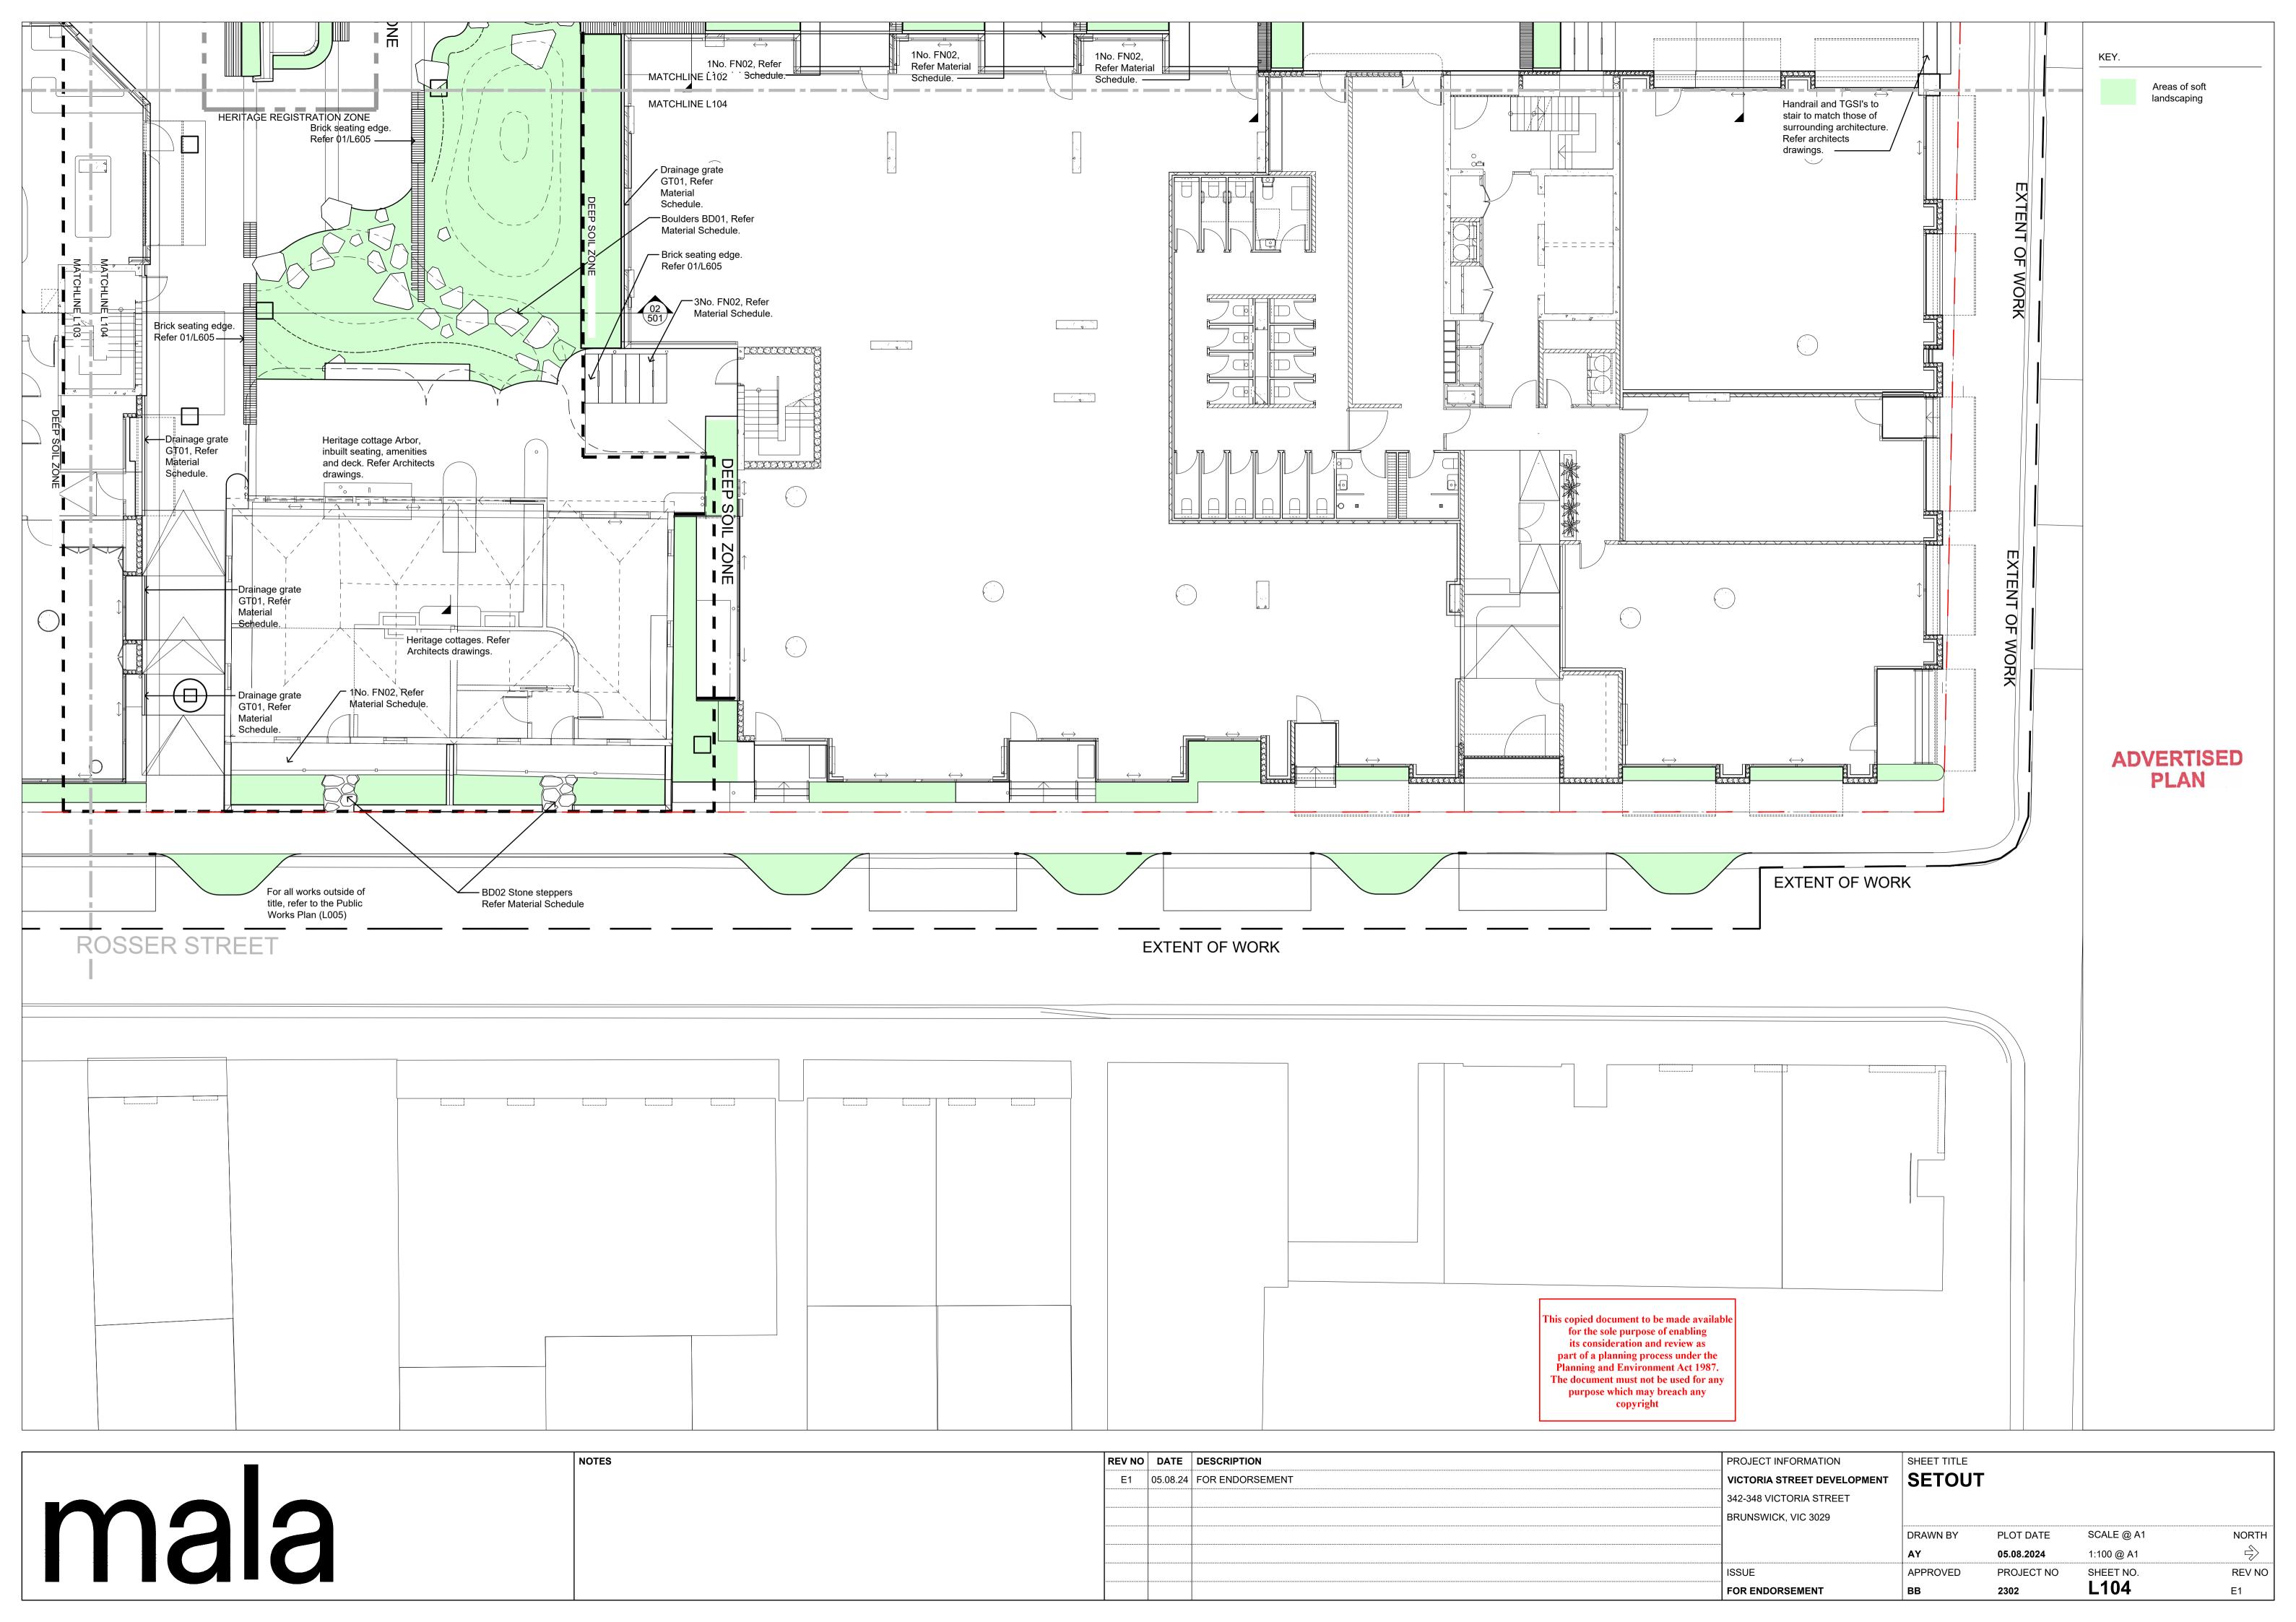
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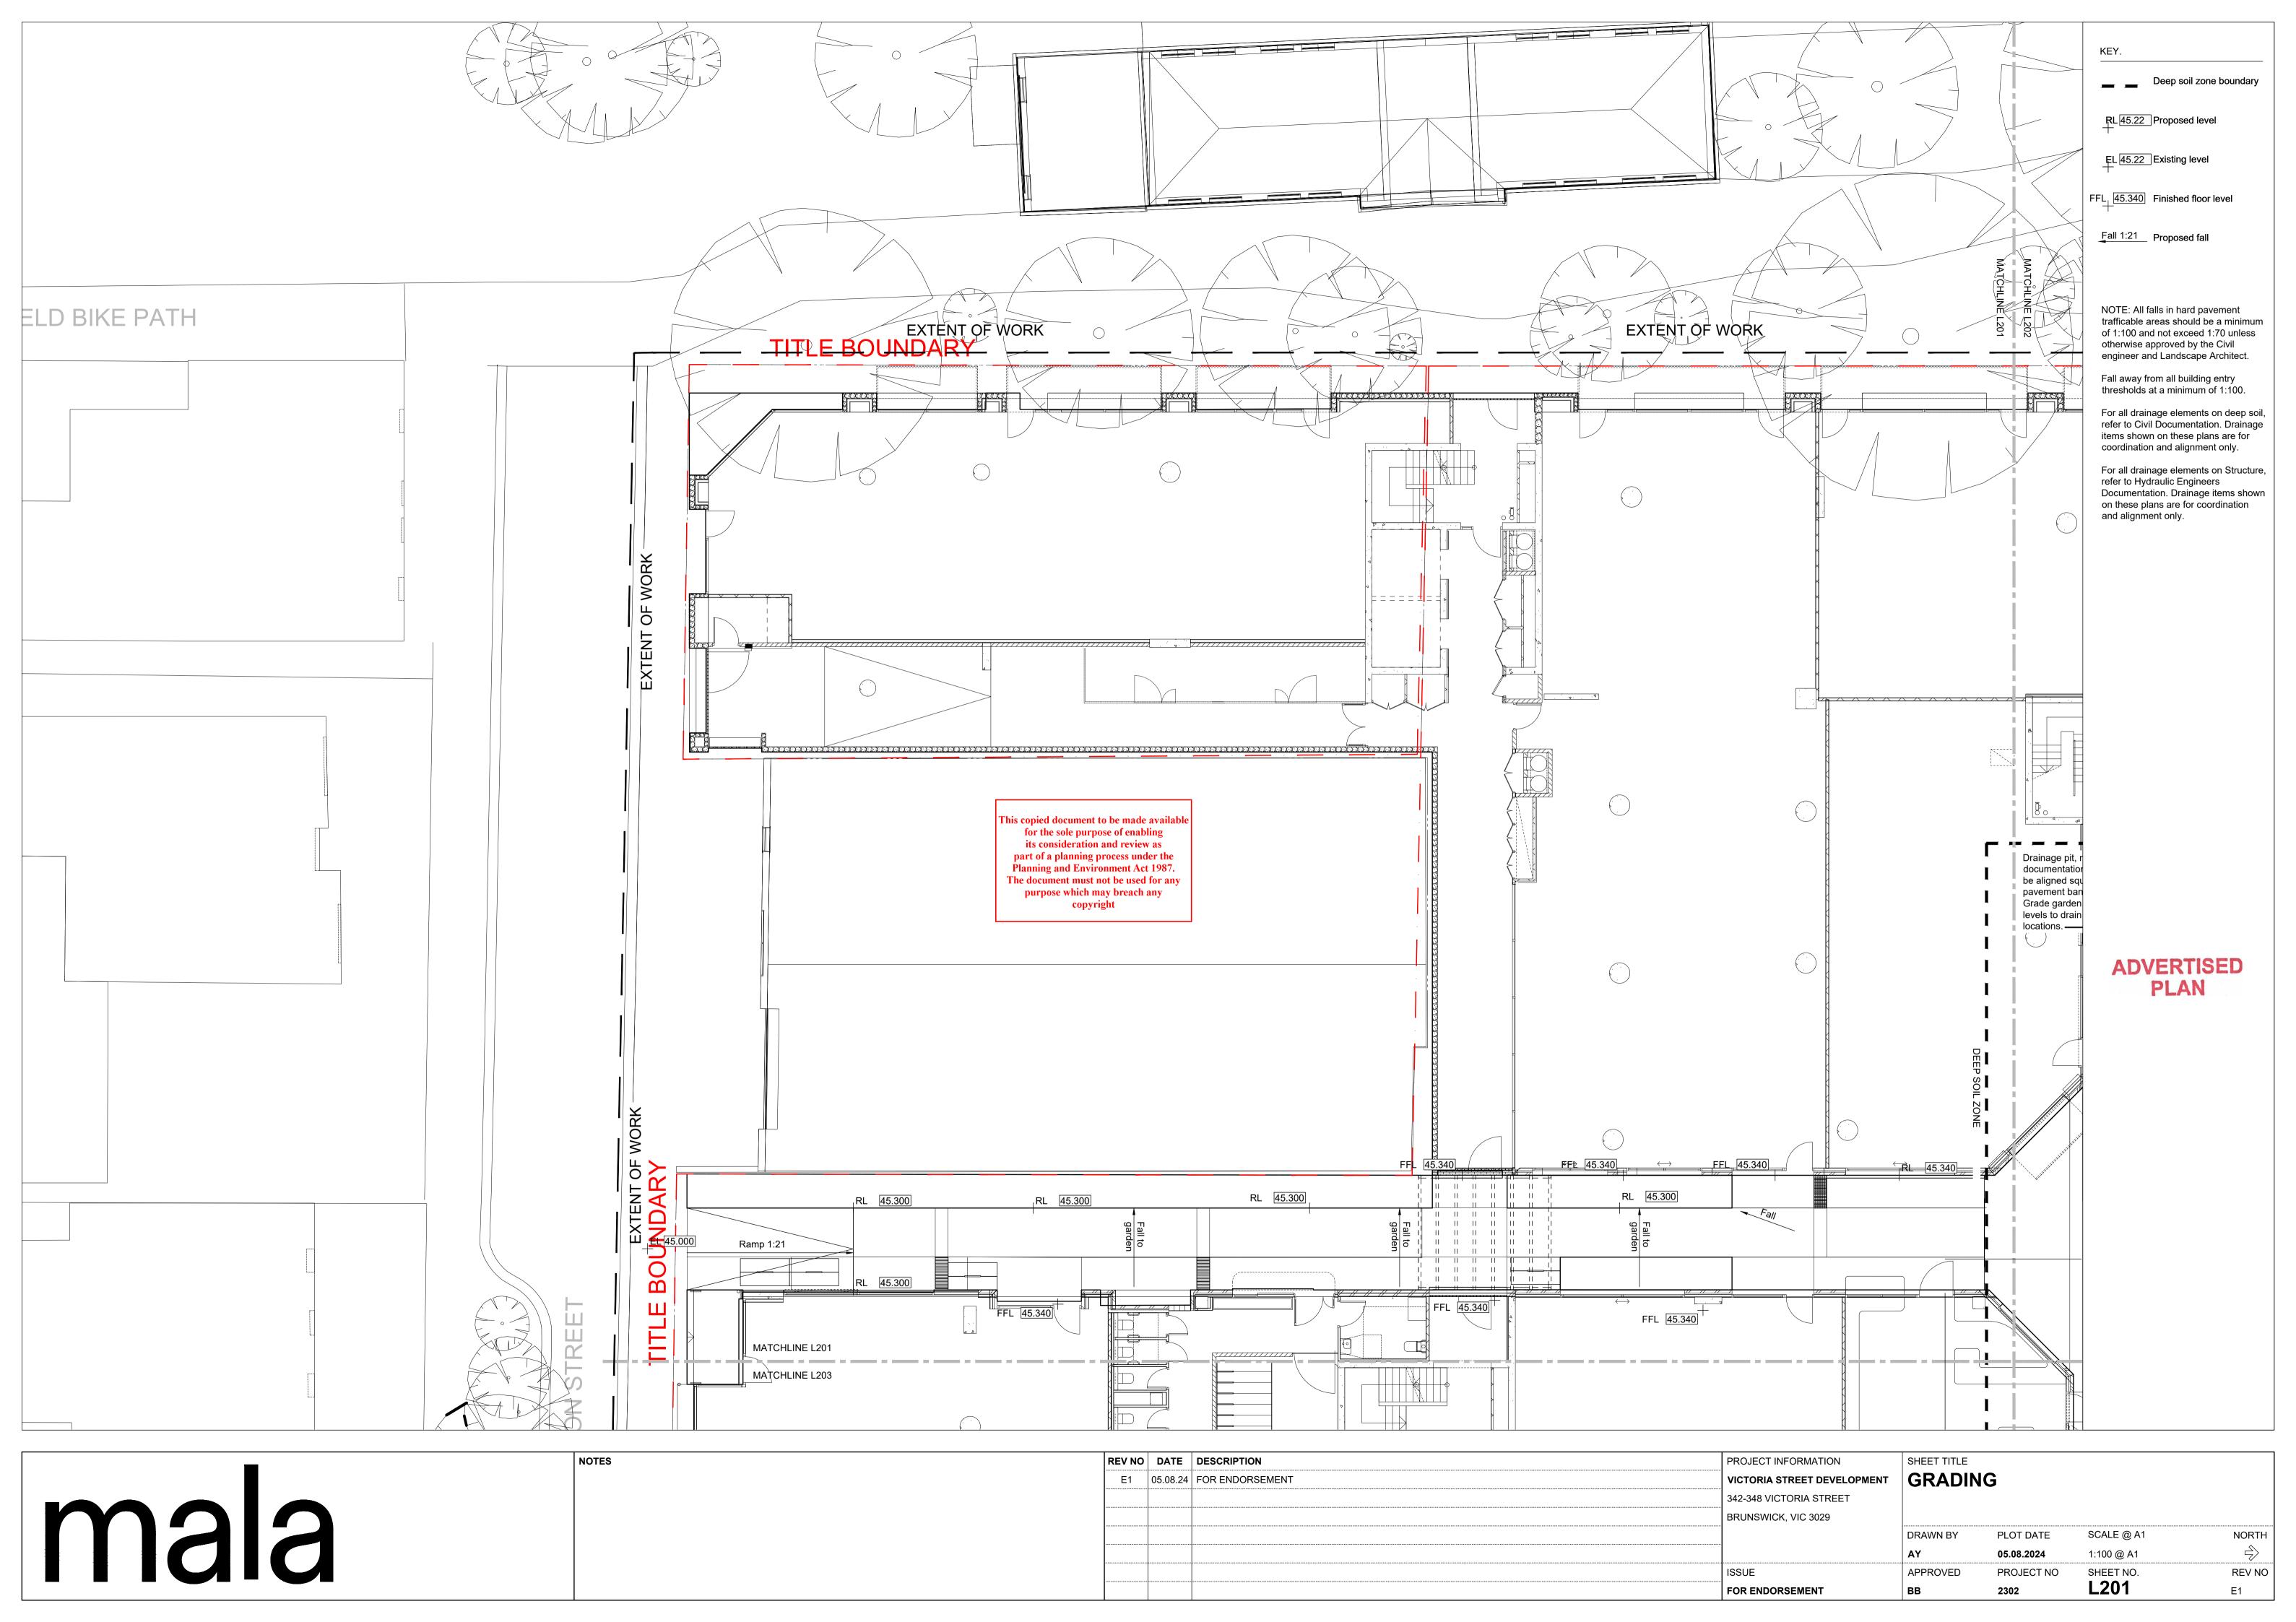
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E1	05.08.24	FOR ENDORSEMENT	VICTORIA STREET DEVELOPMENT	SITE PLA	N - ROOF	PLAN	
			342-348 VICTORIA STREET				
			BRUNSWICK, VIC 3029				
				DRAWN BY	PLOT DATE	SCALE @ A1	NORTH
				AY	05.08.2024	1:200 @ A1	
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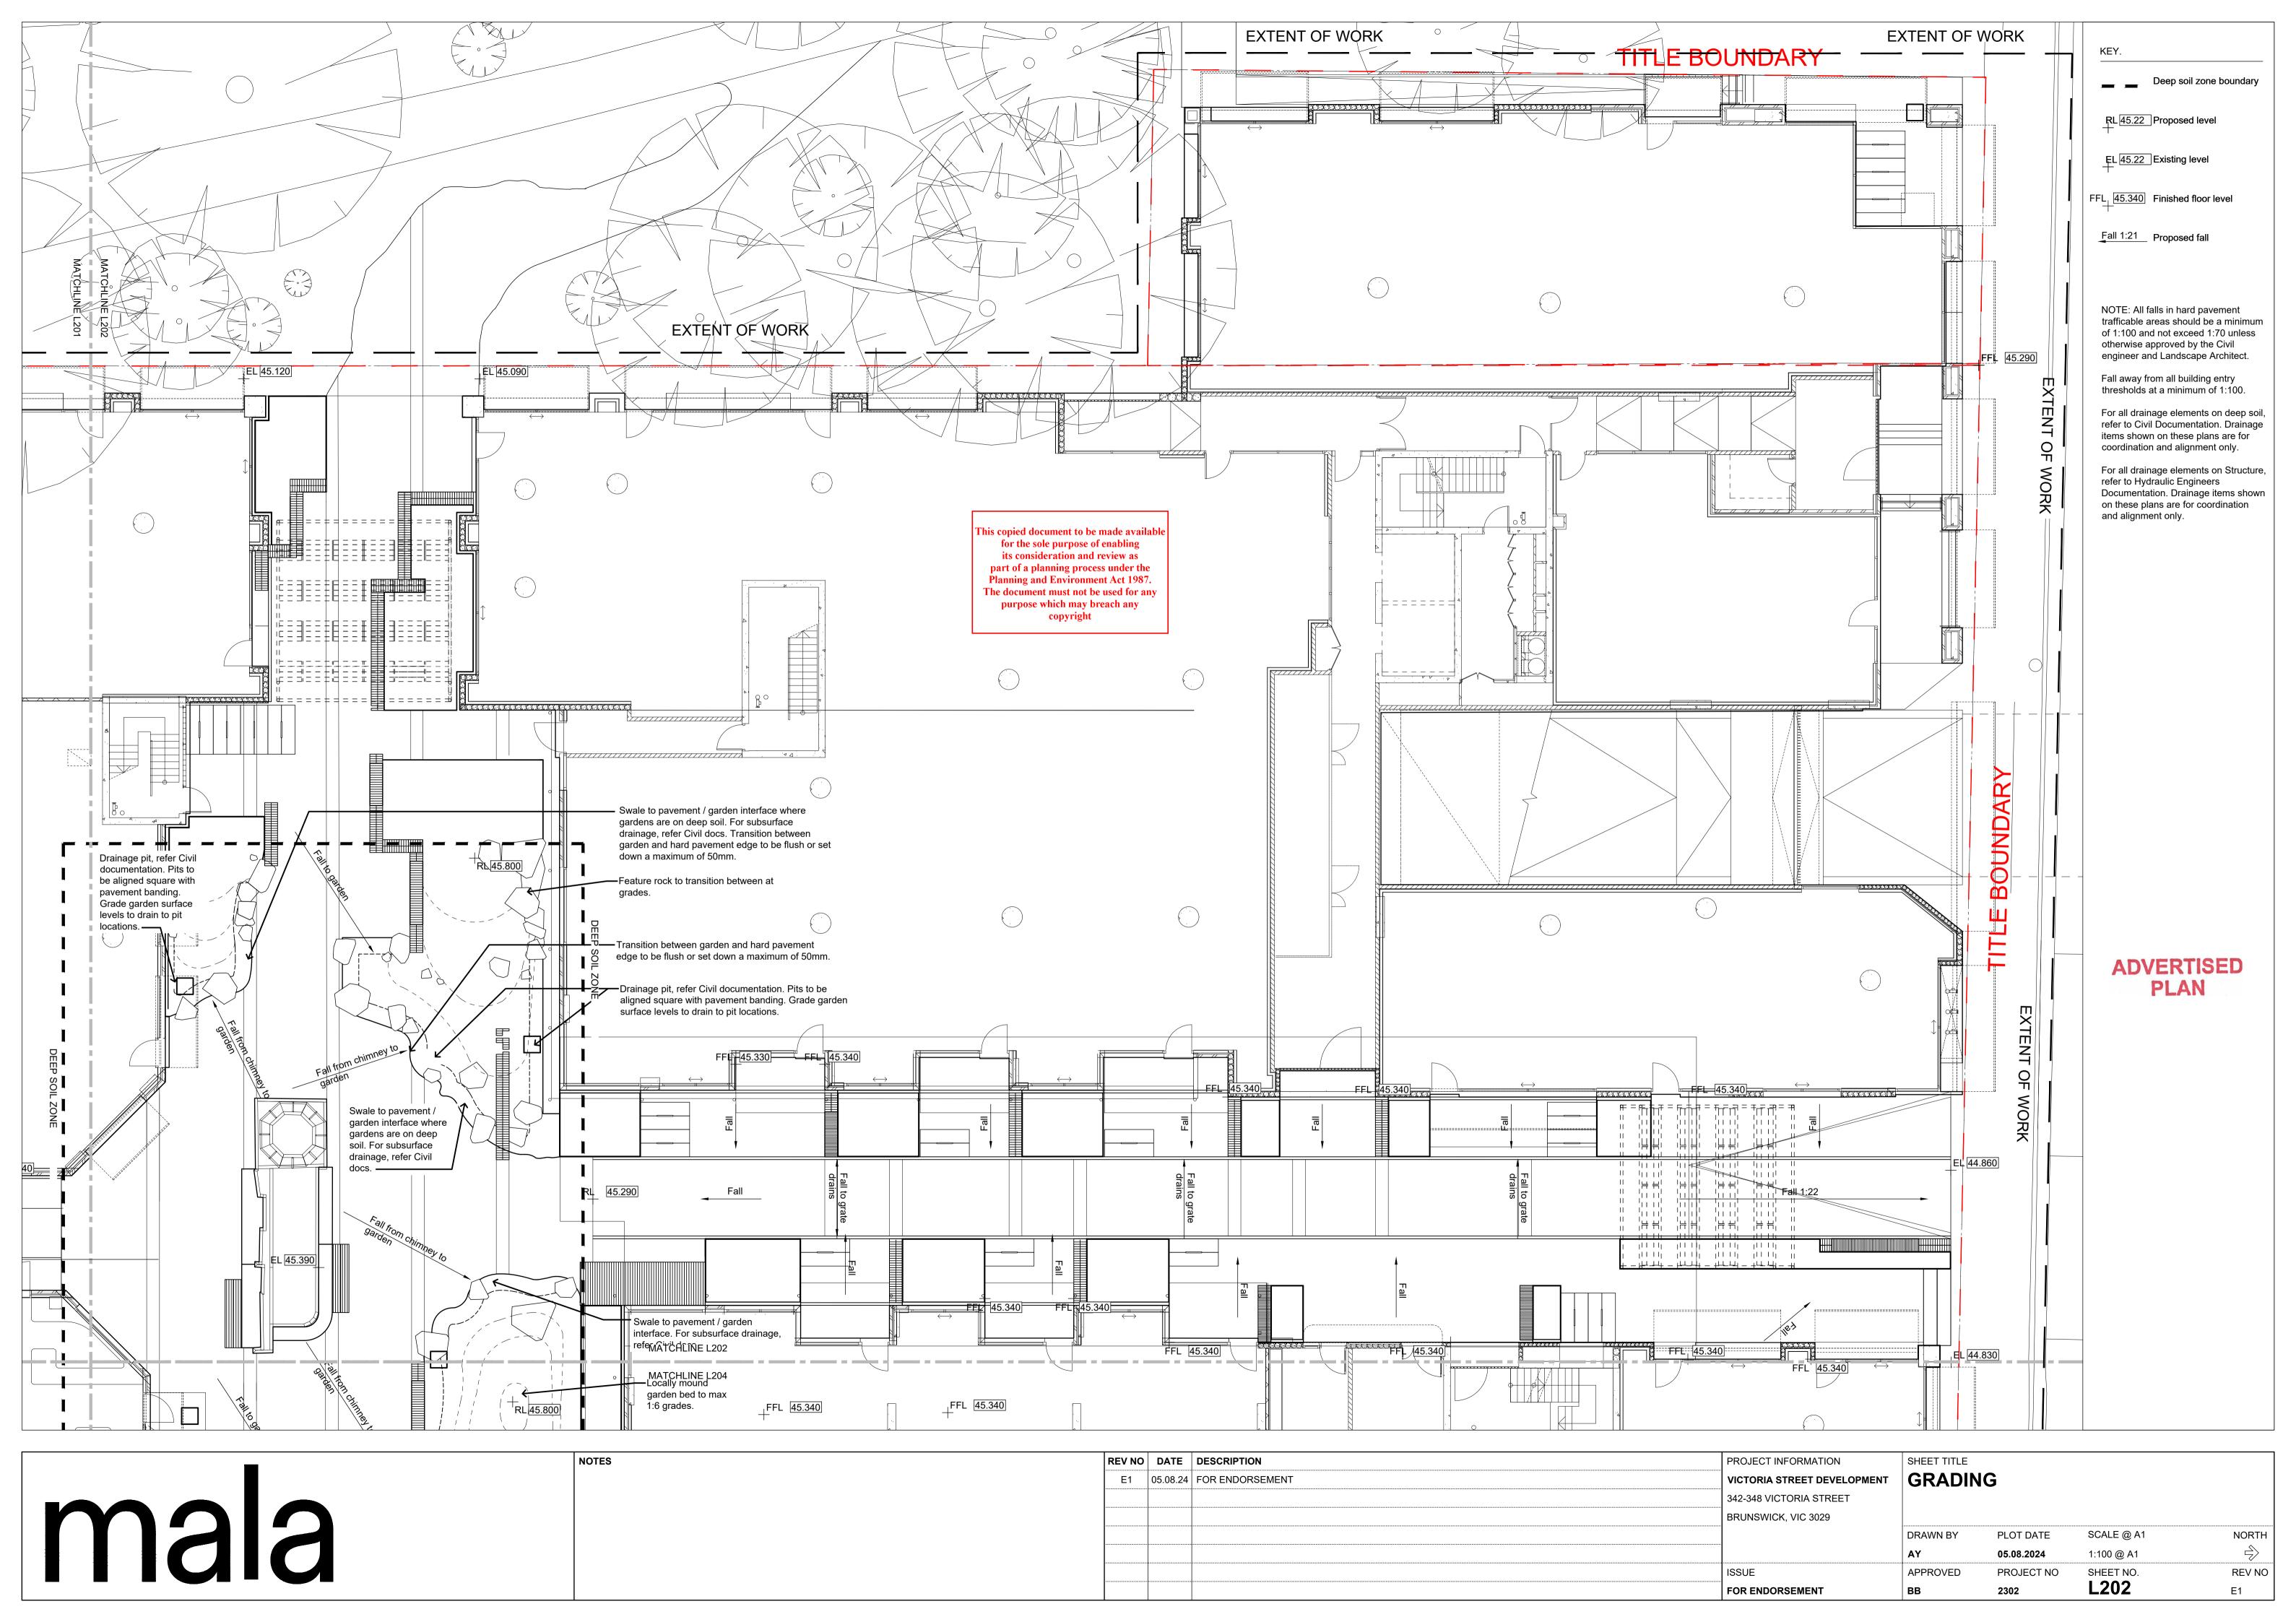


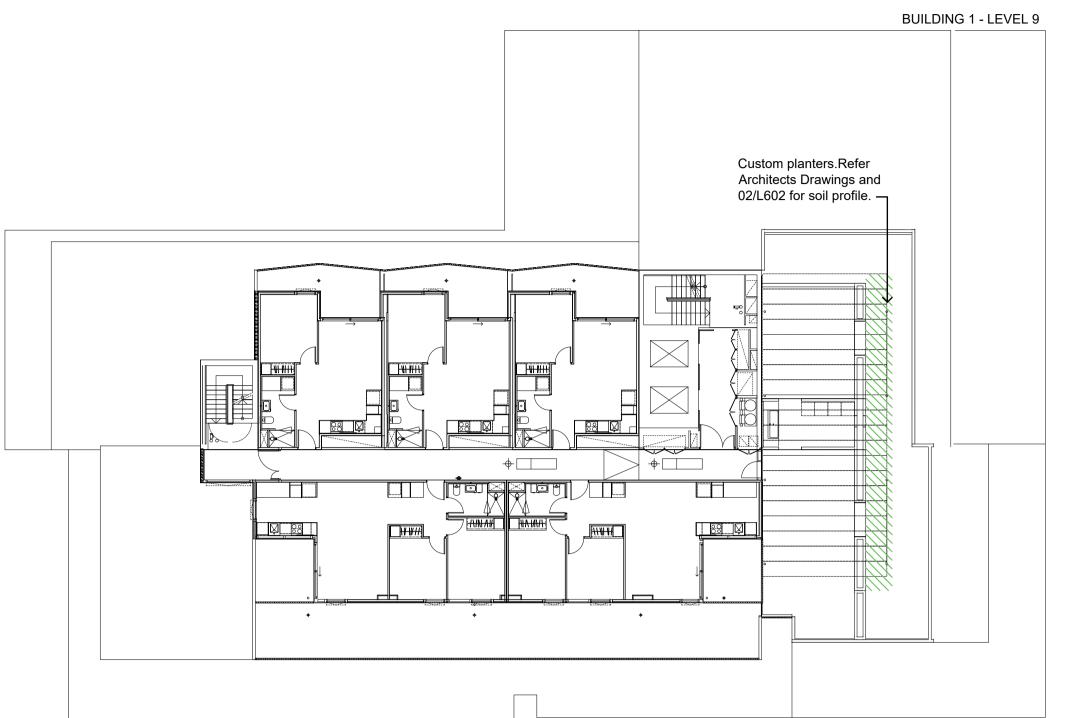


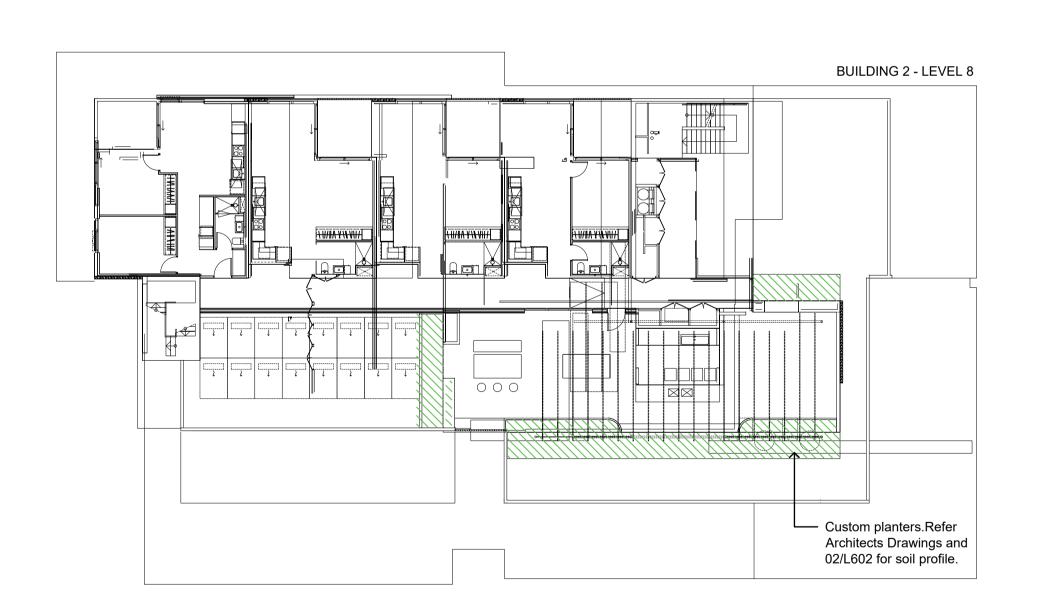





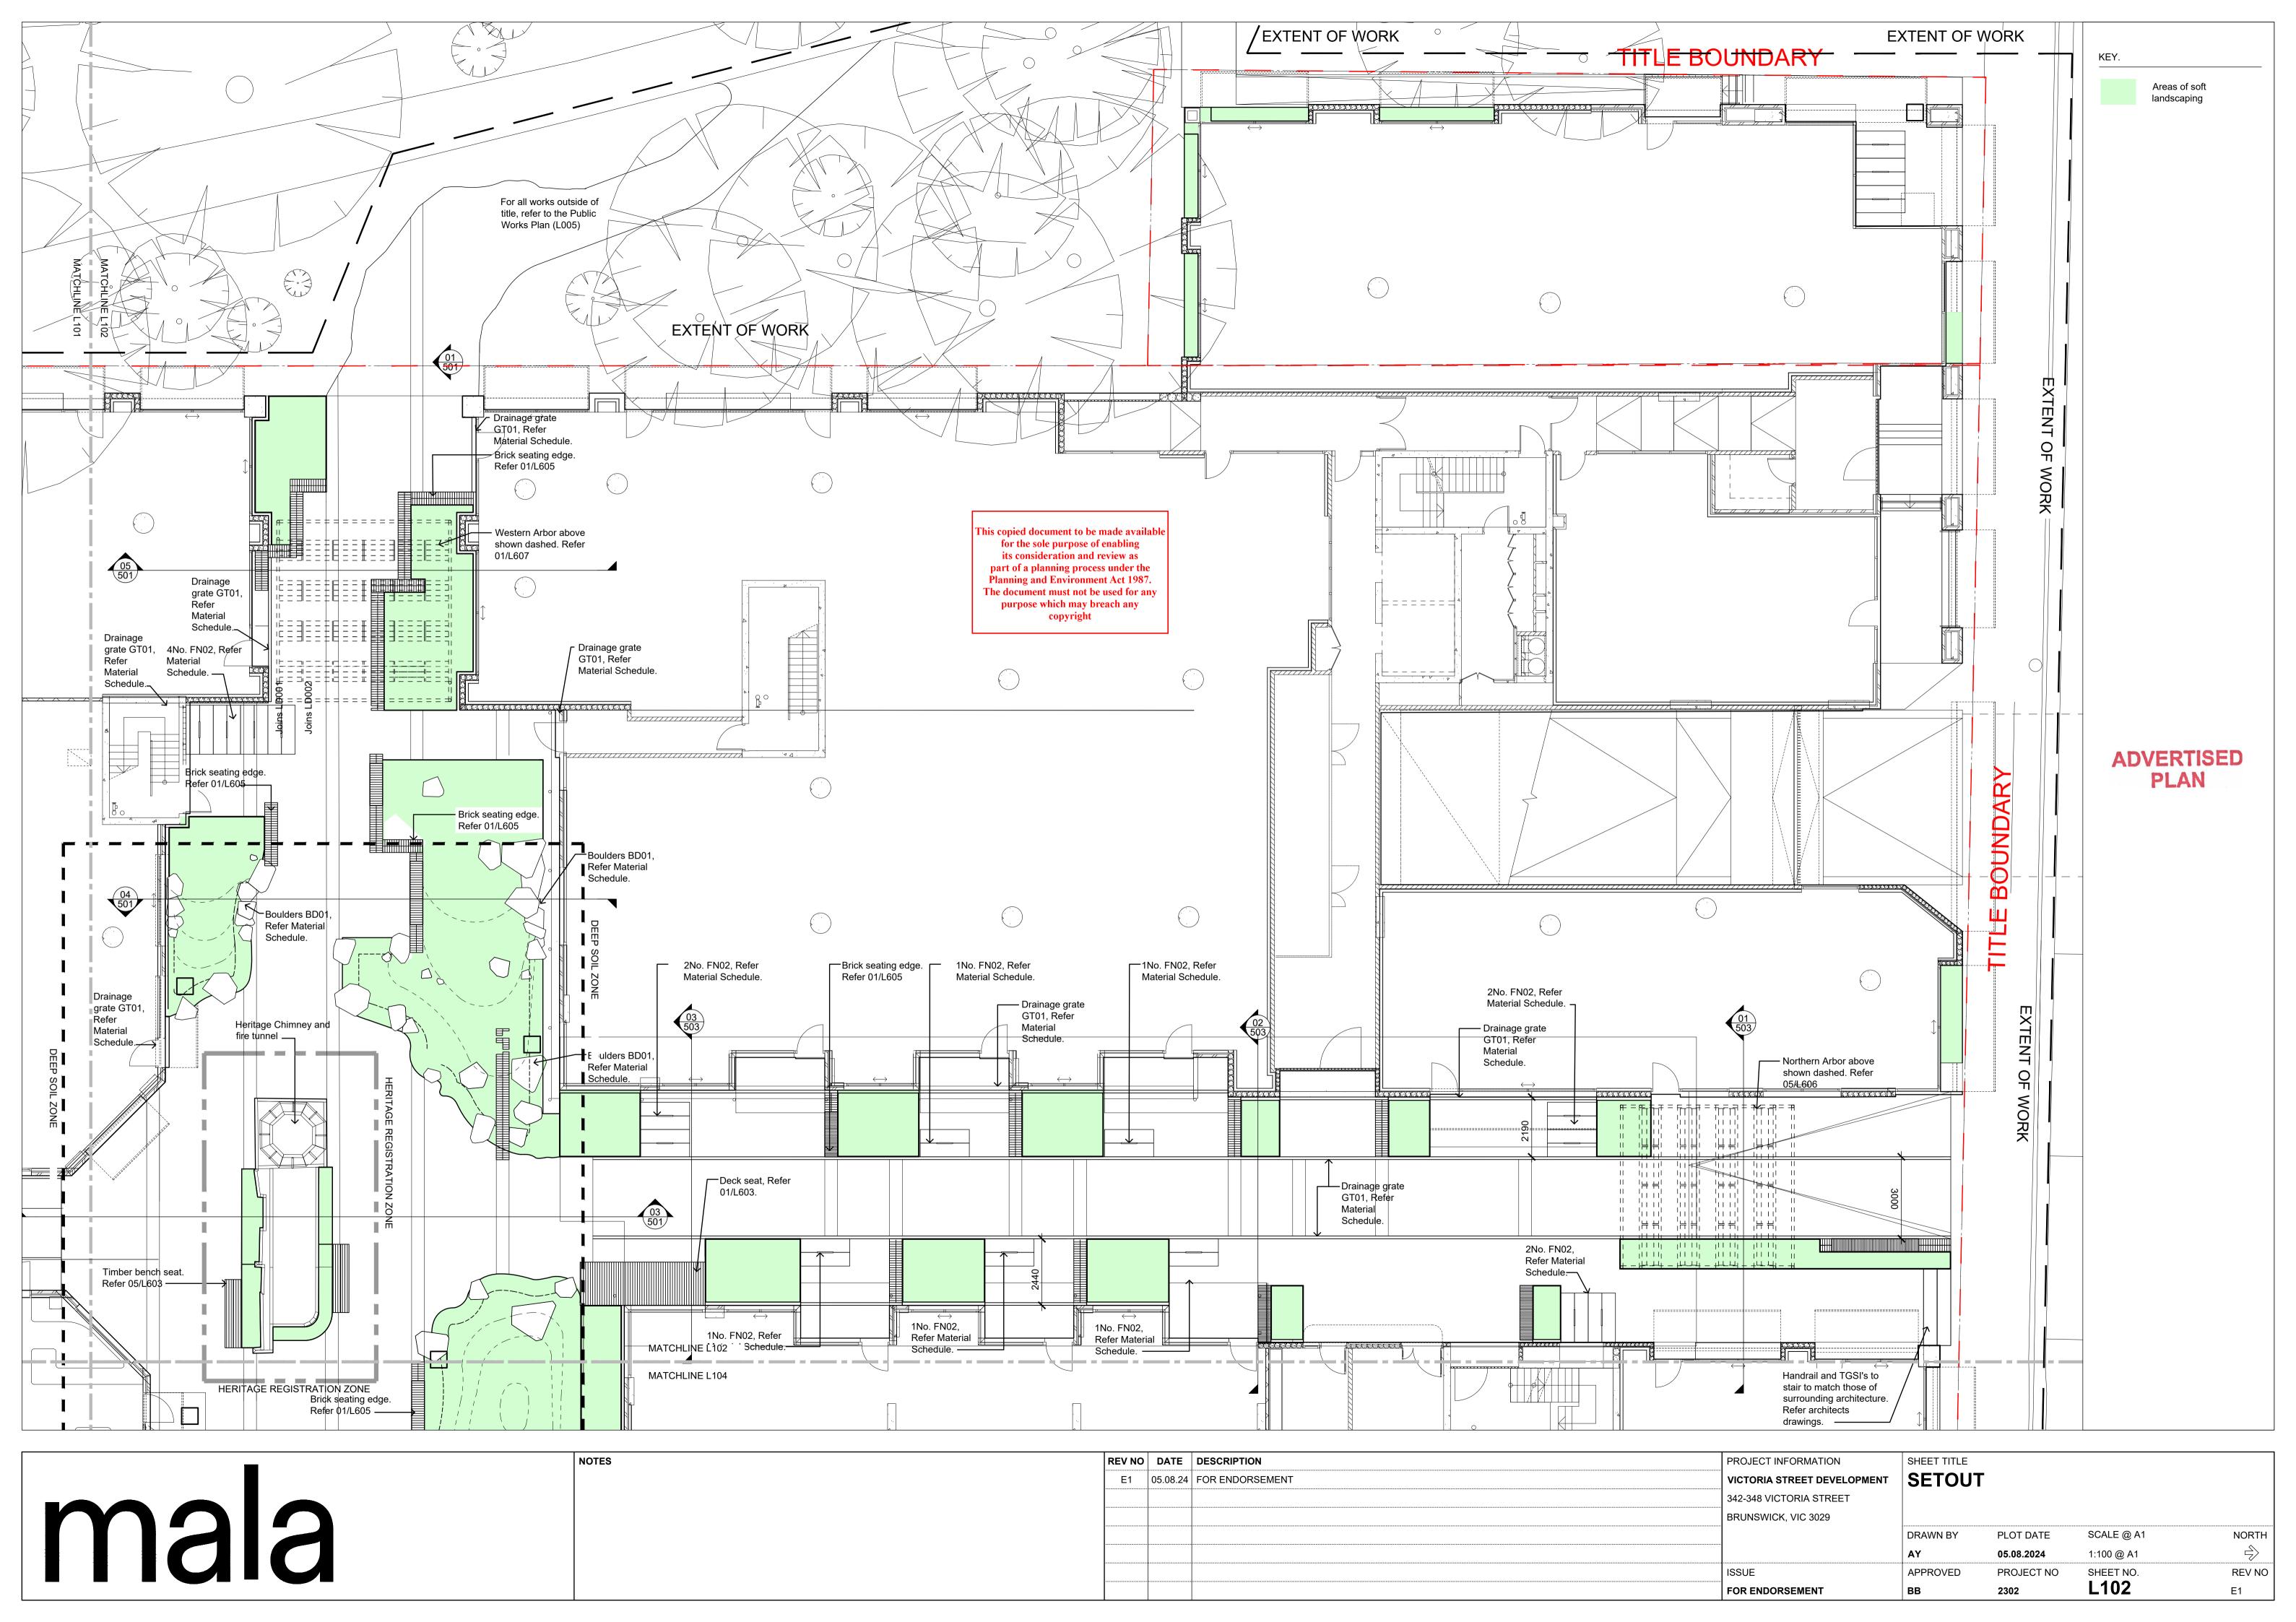


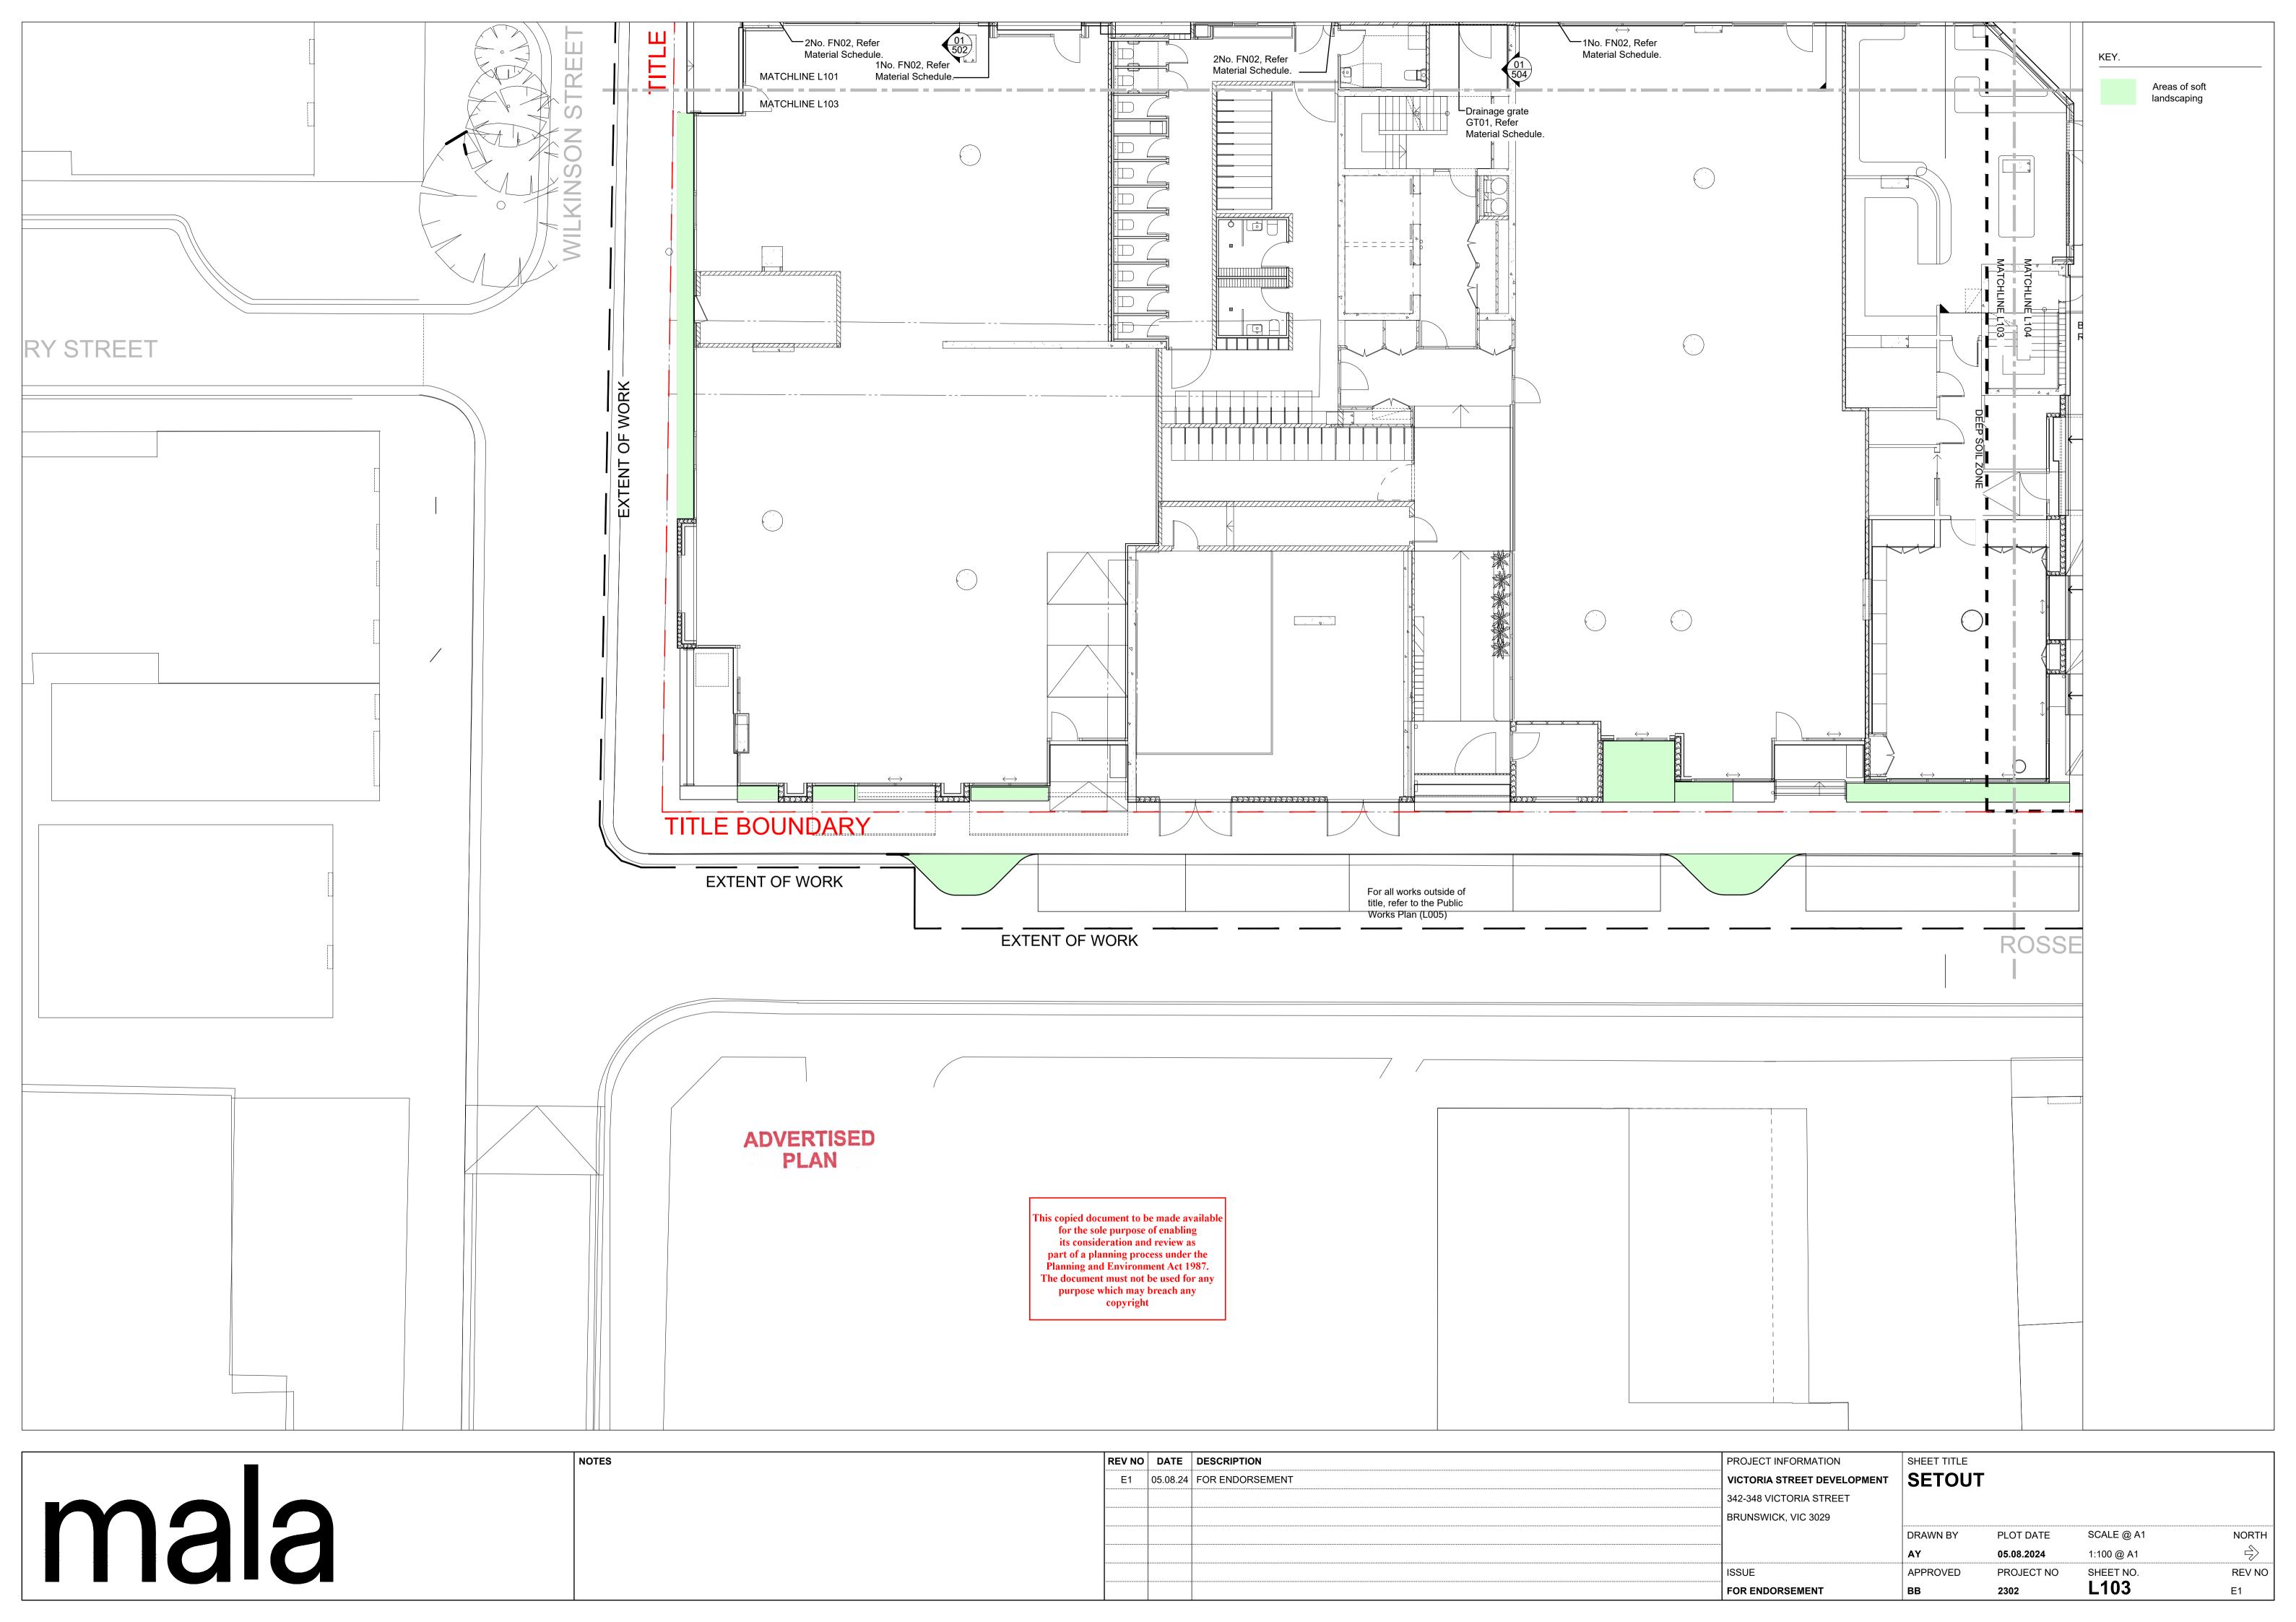


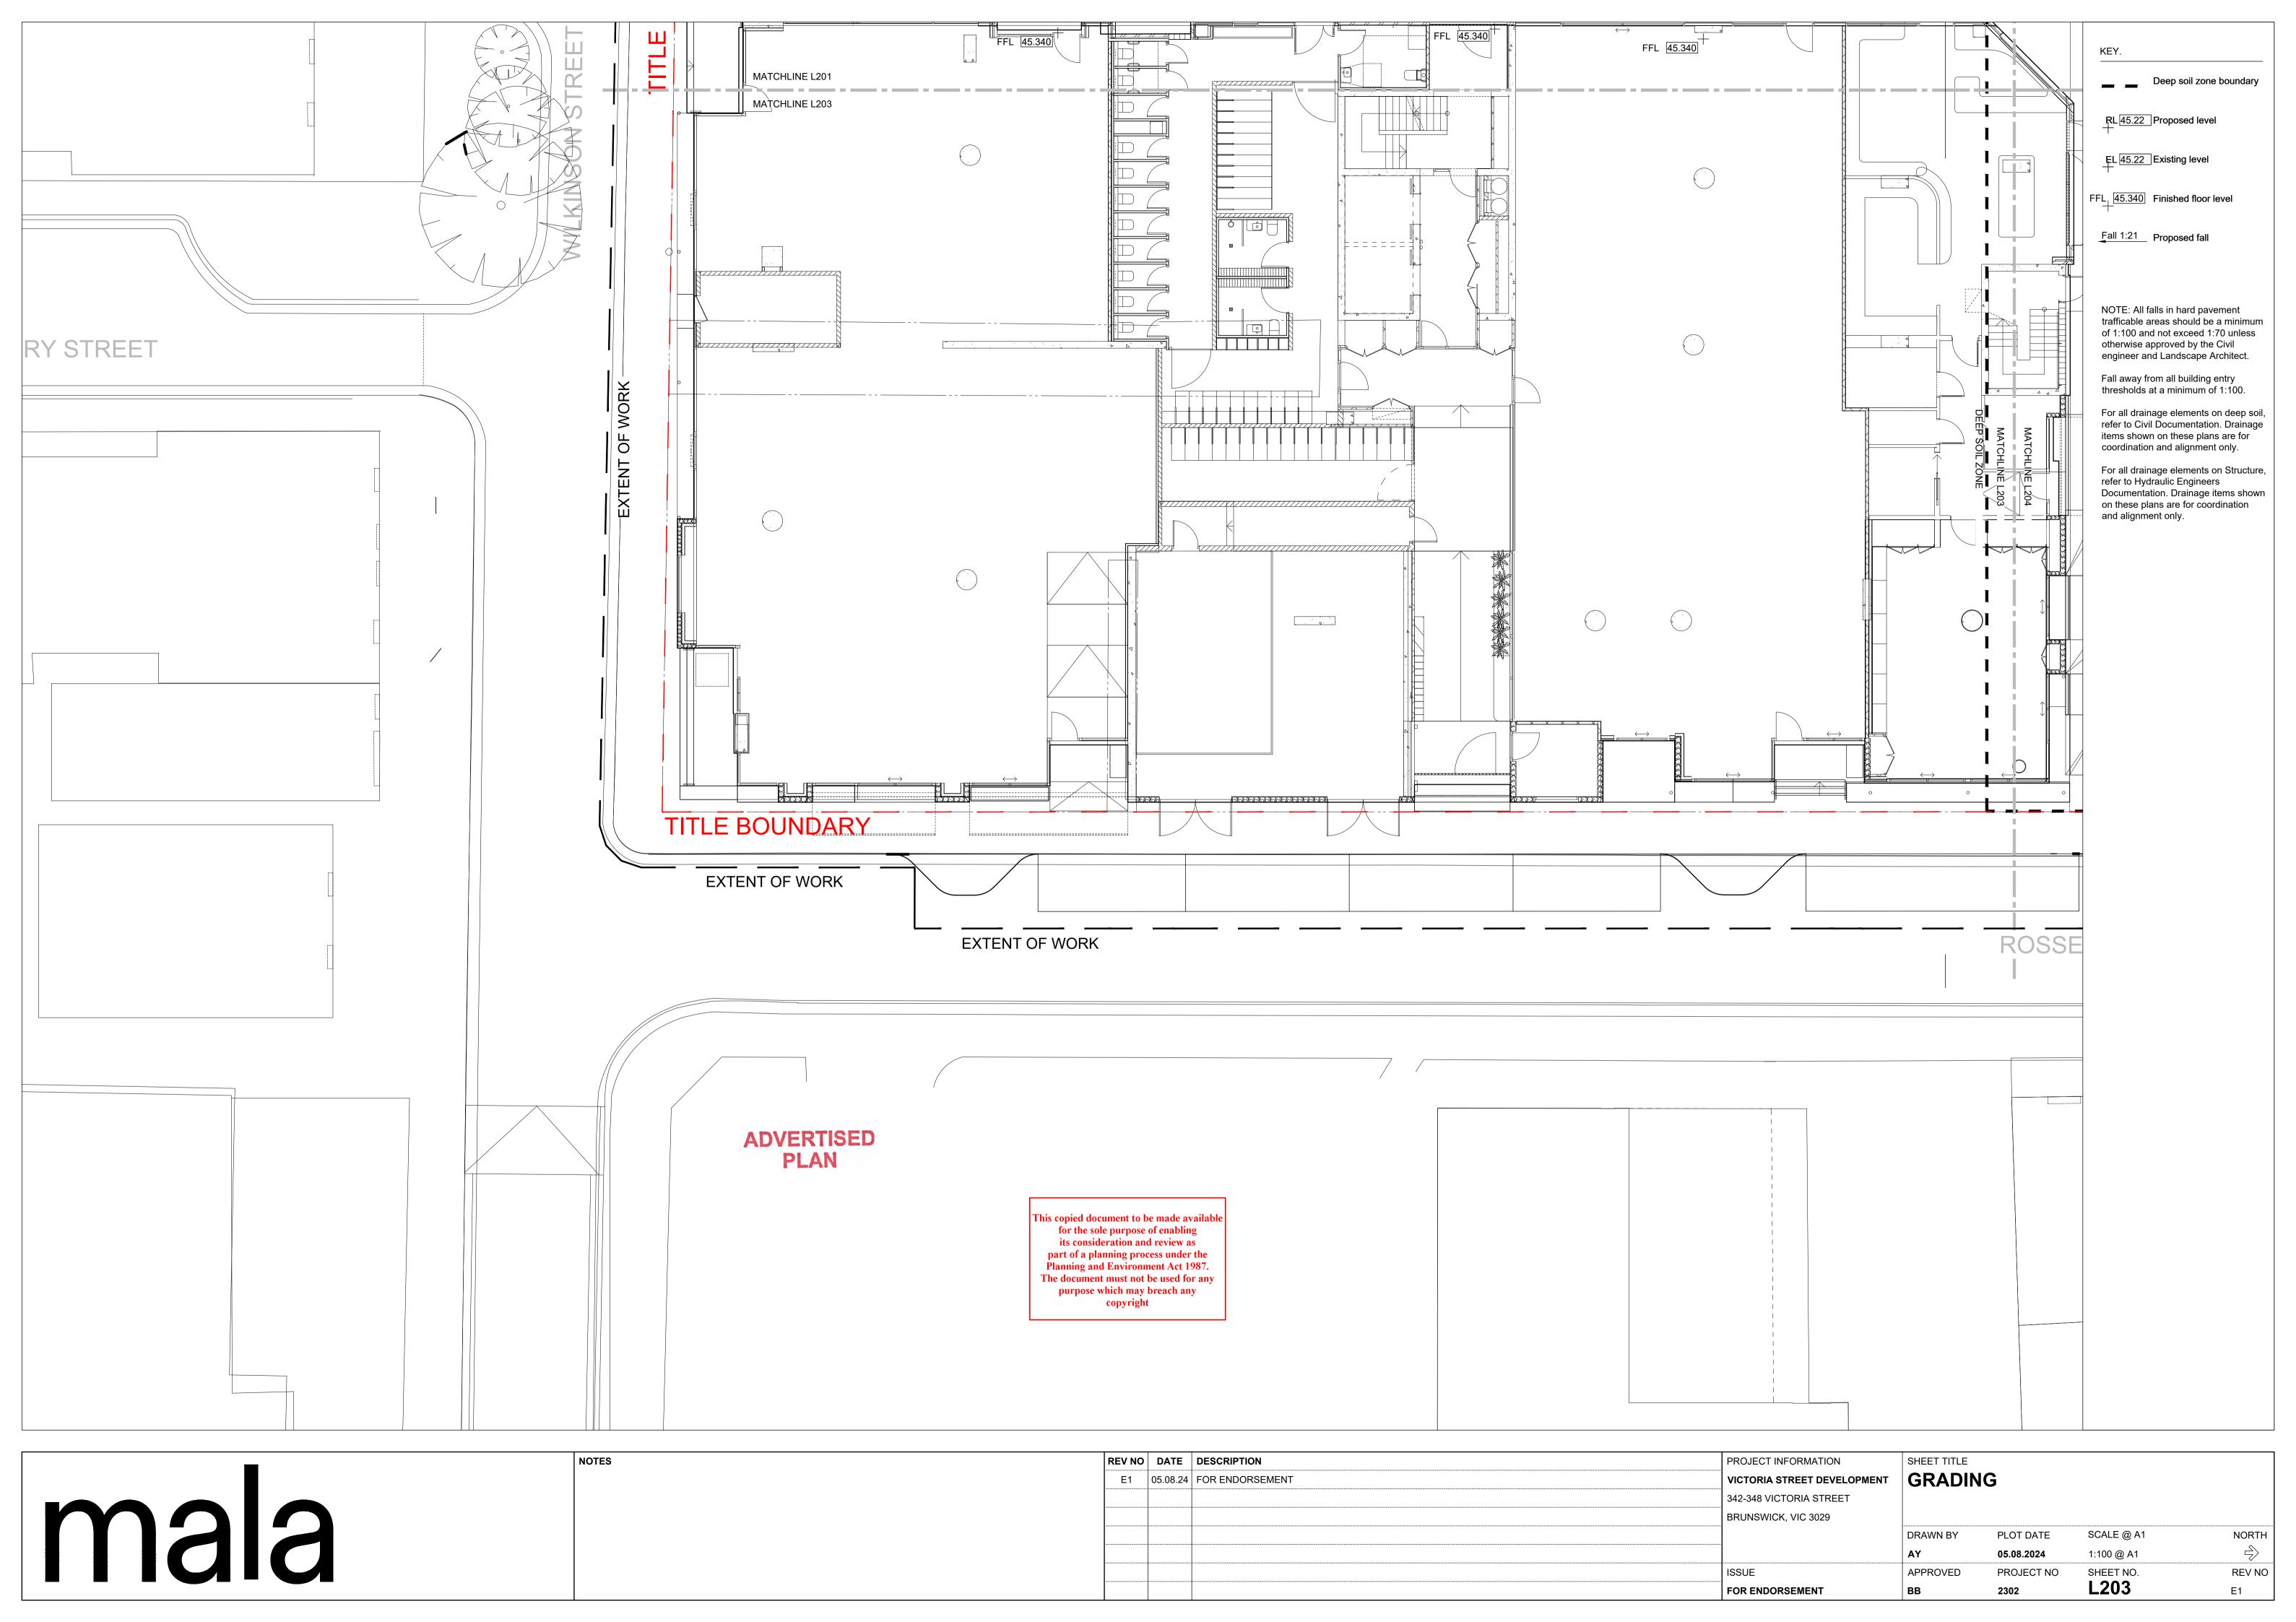


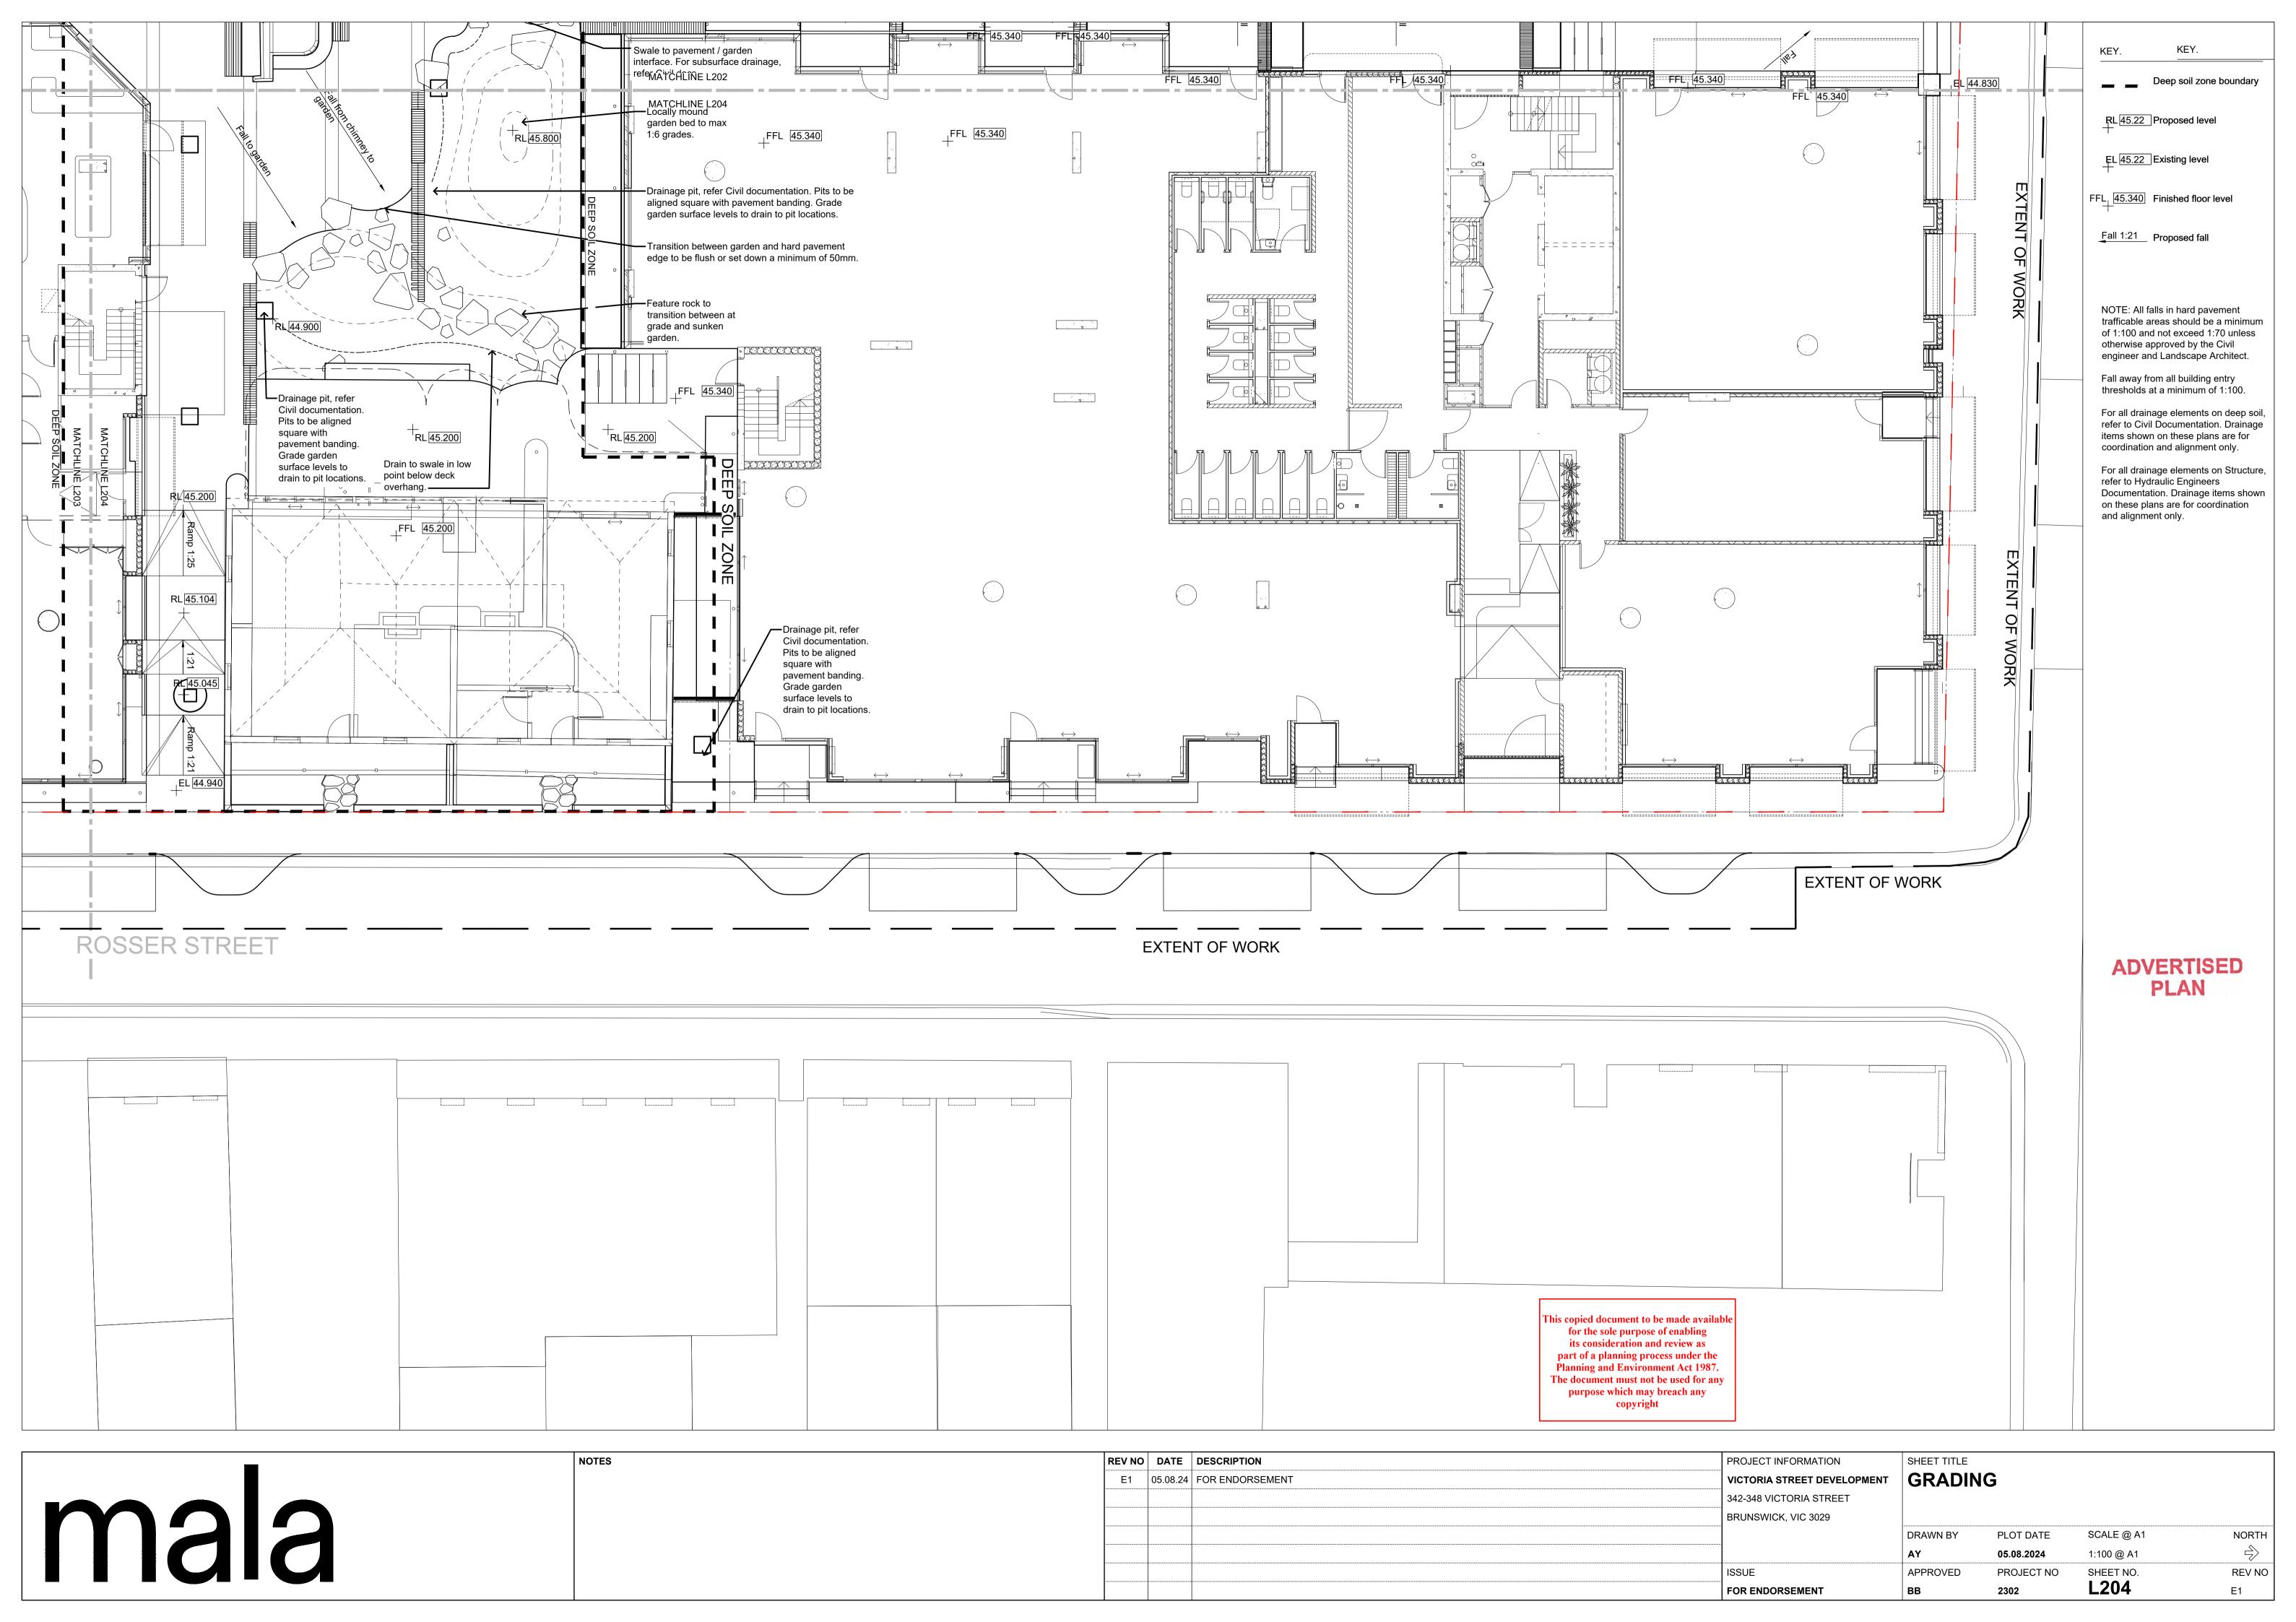

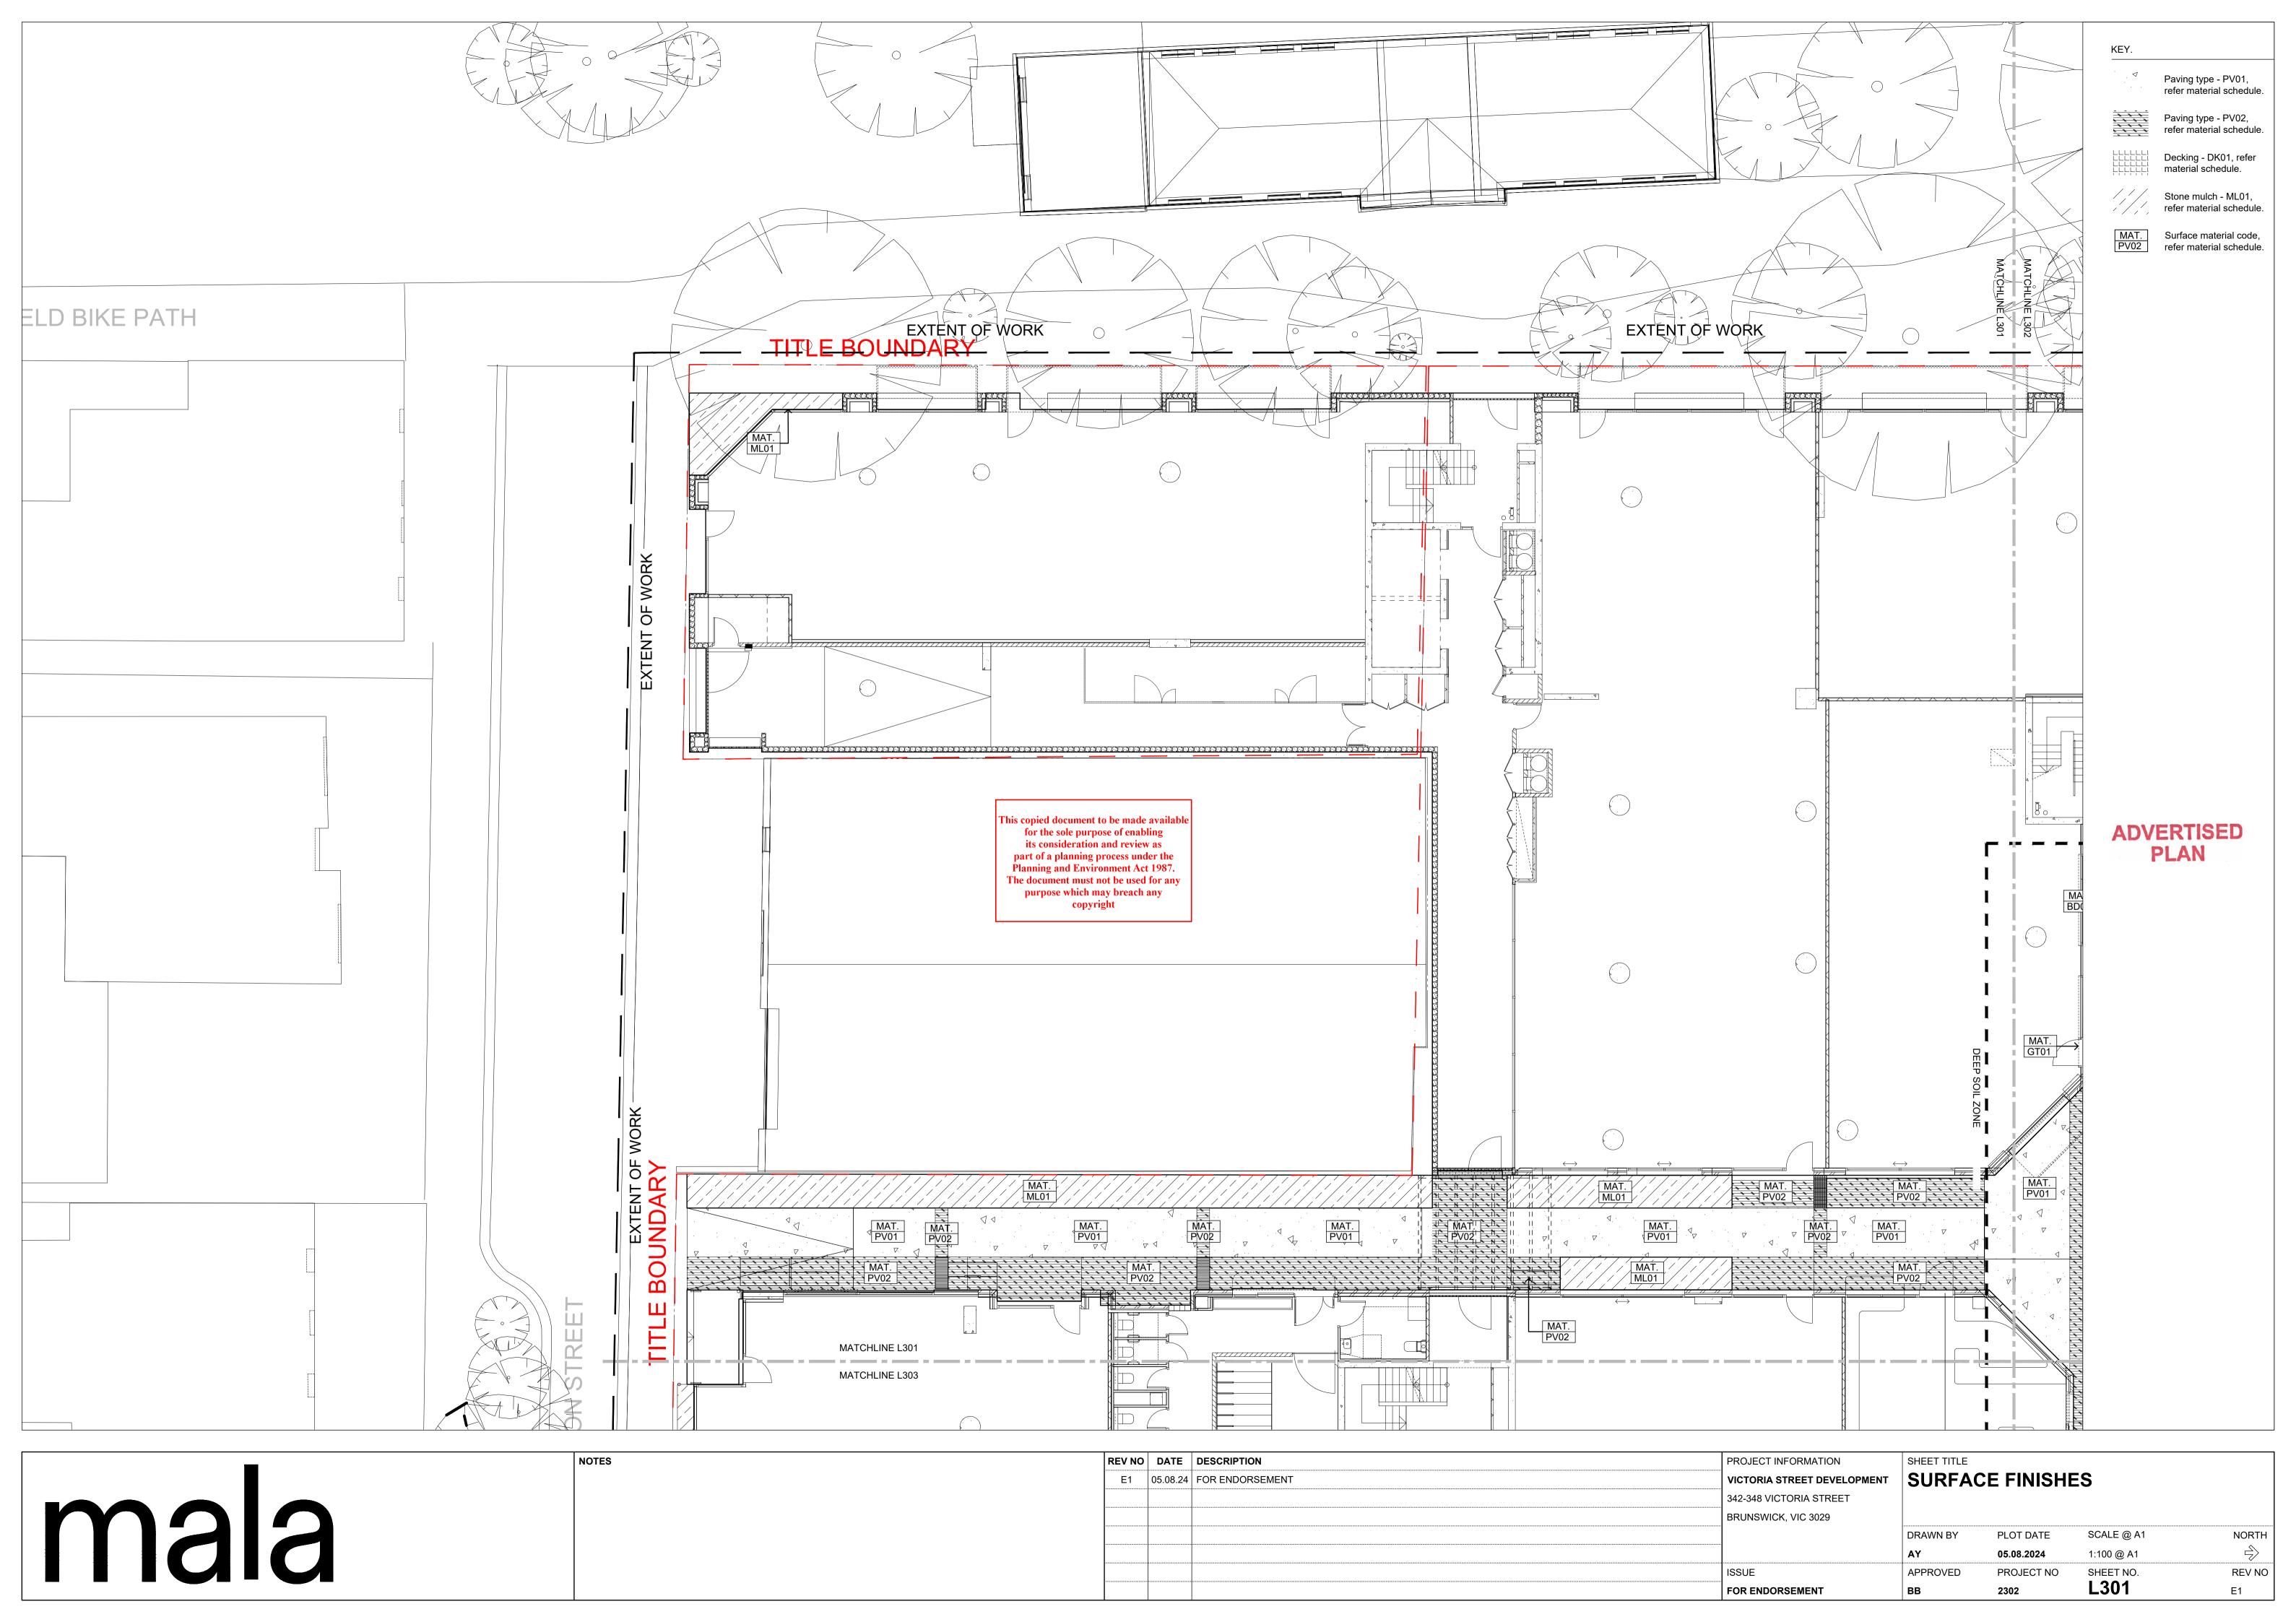

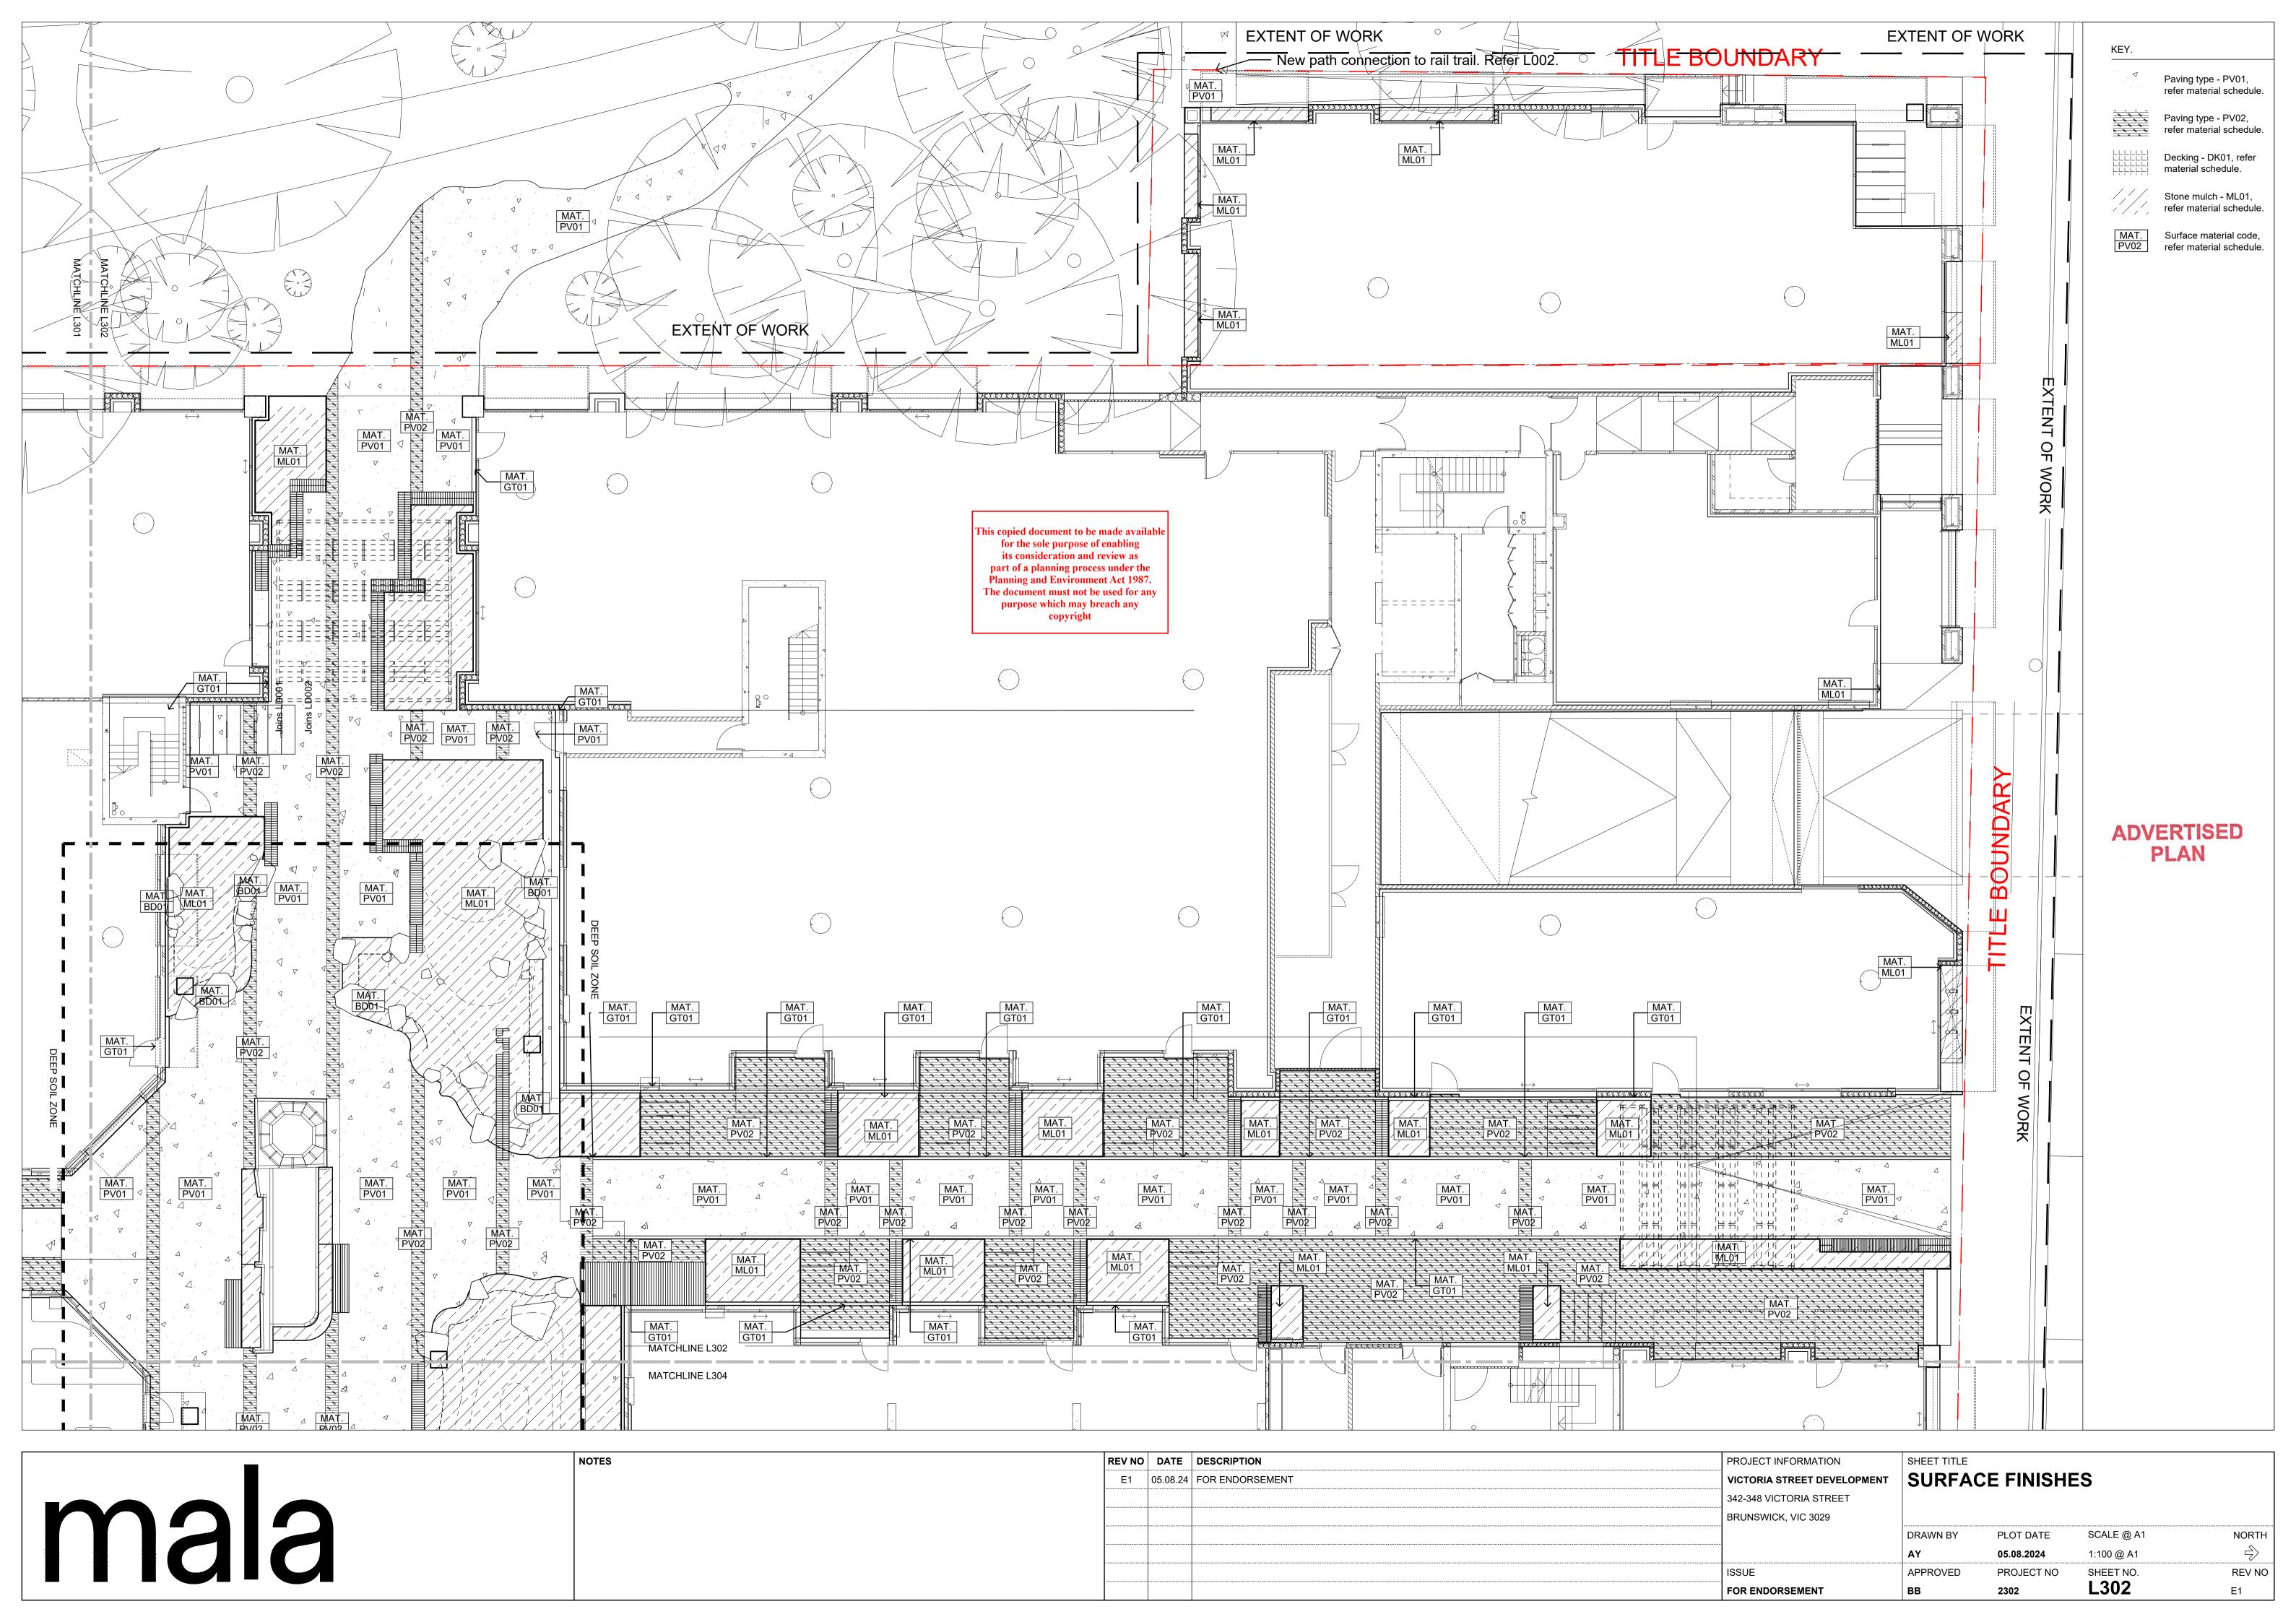

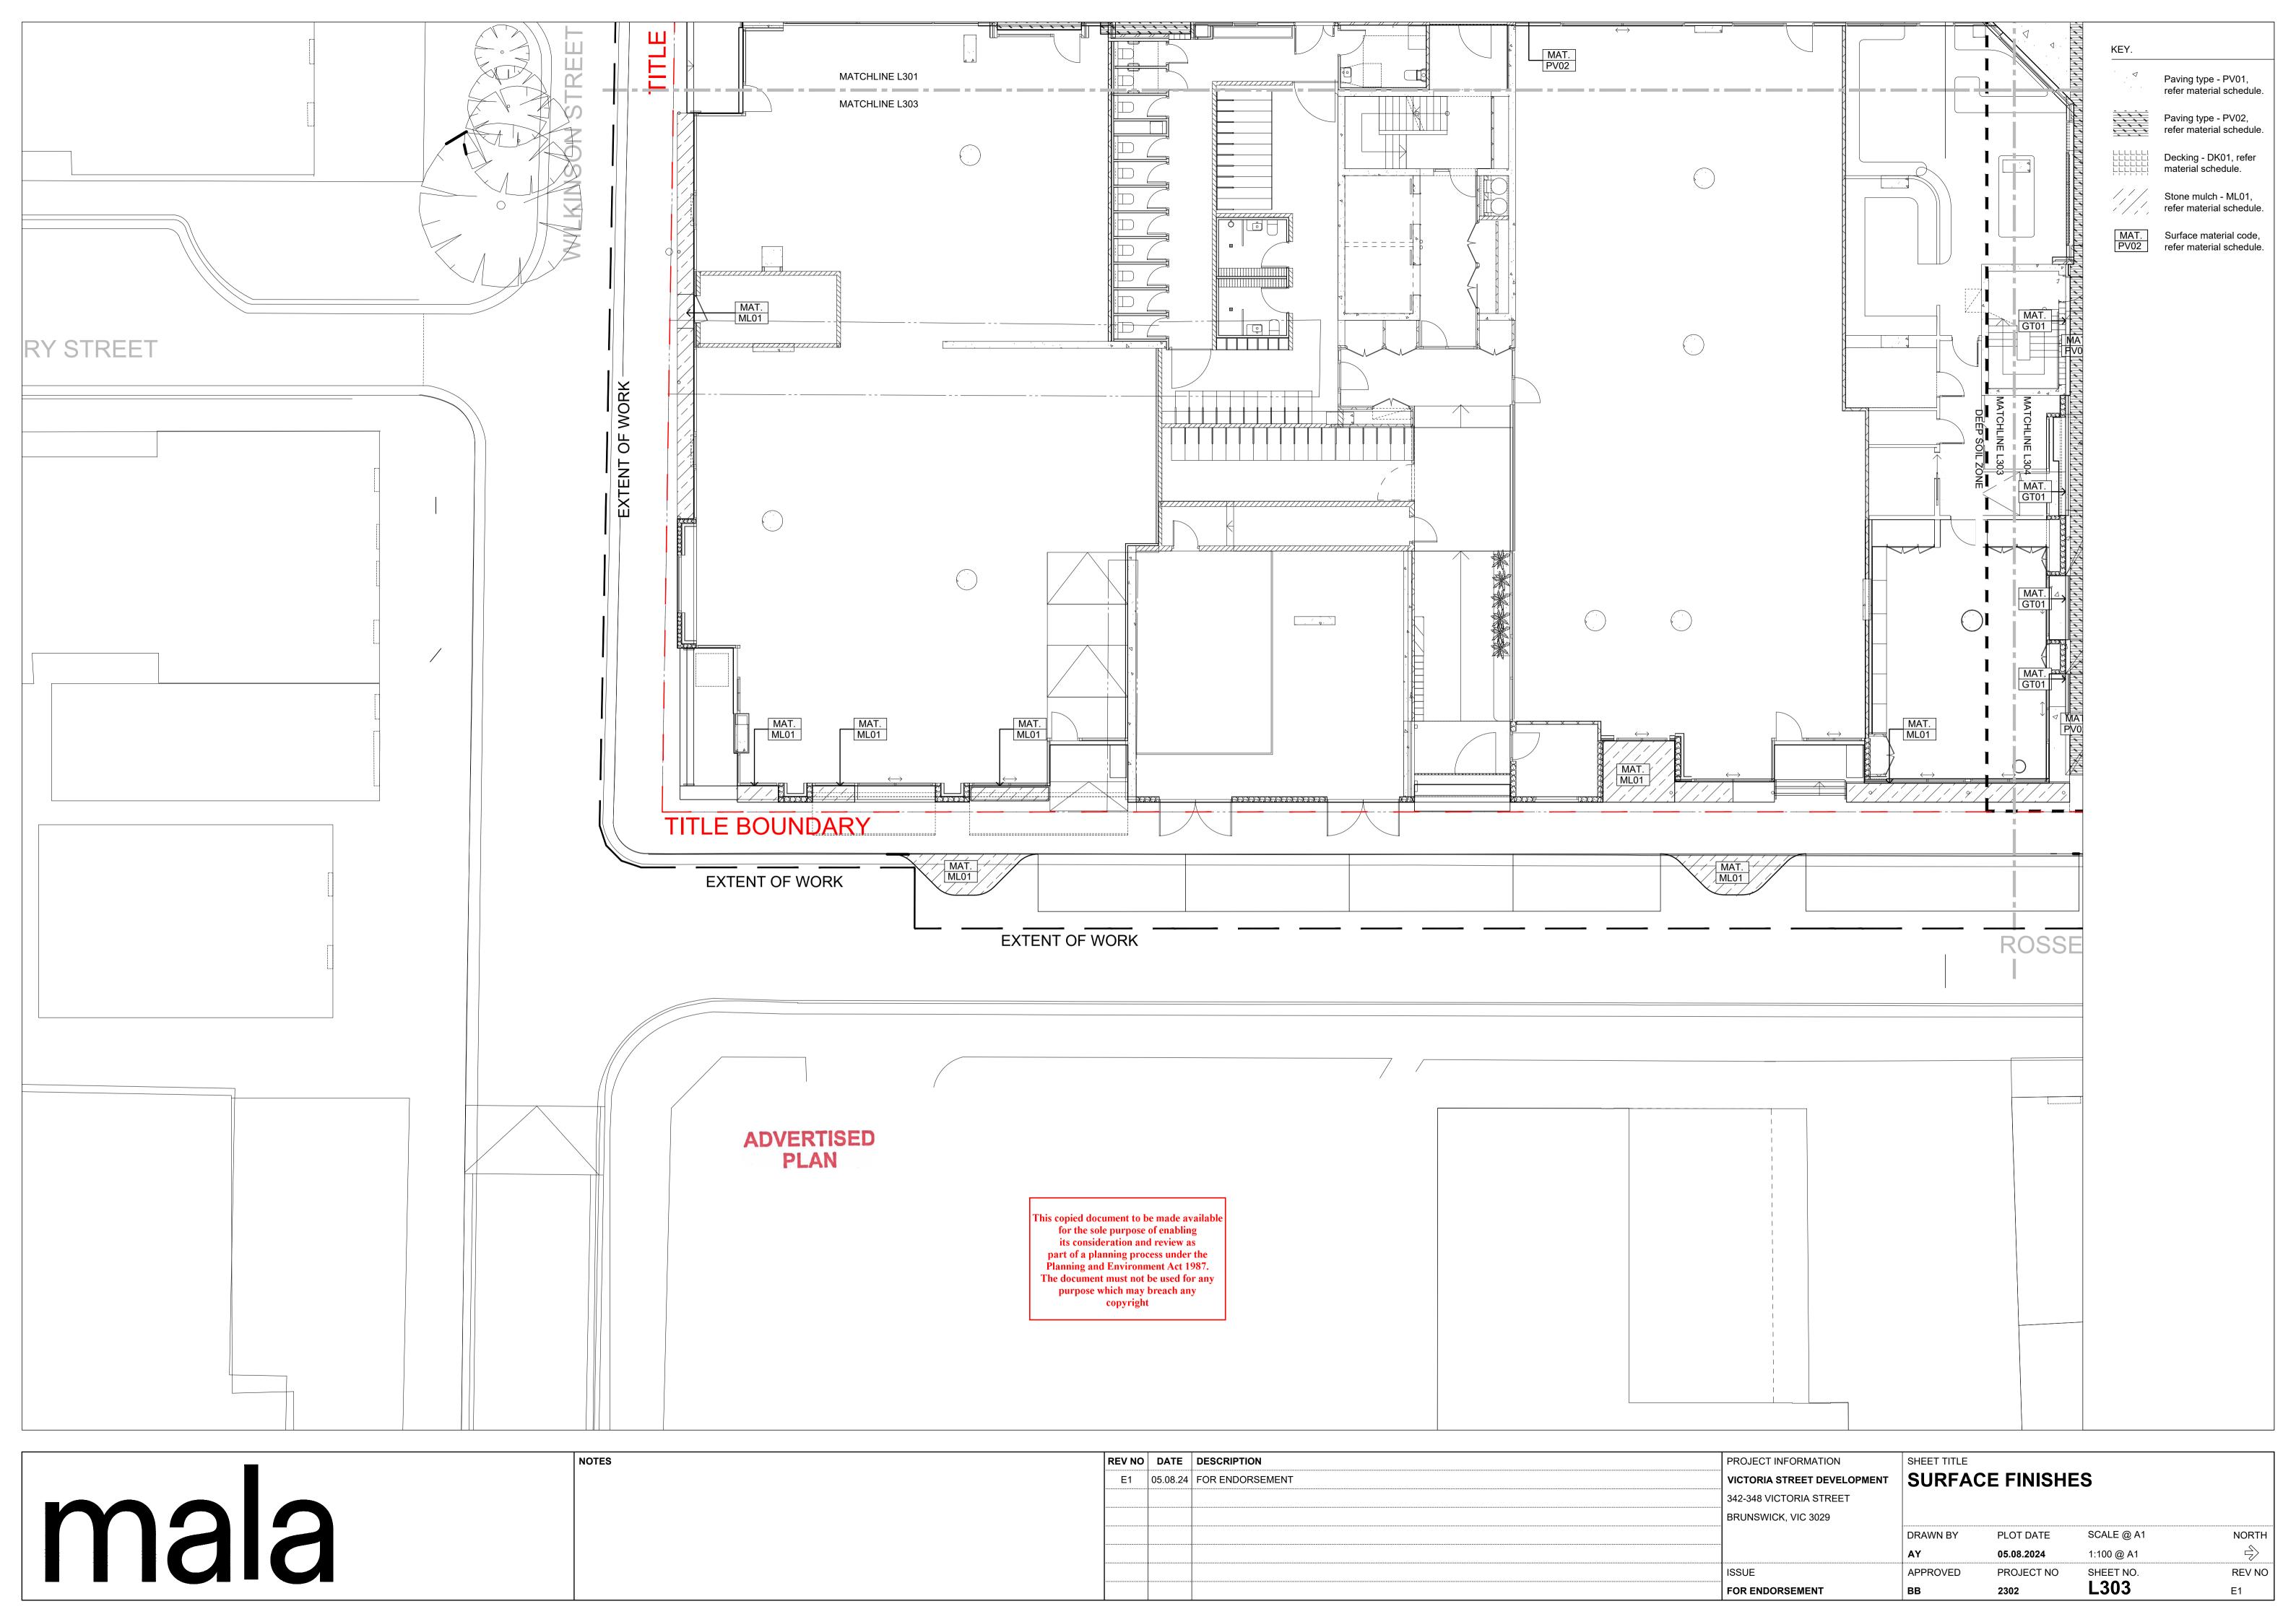

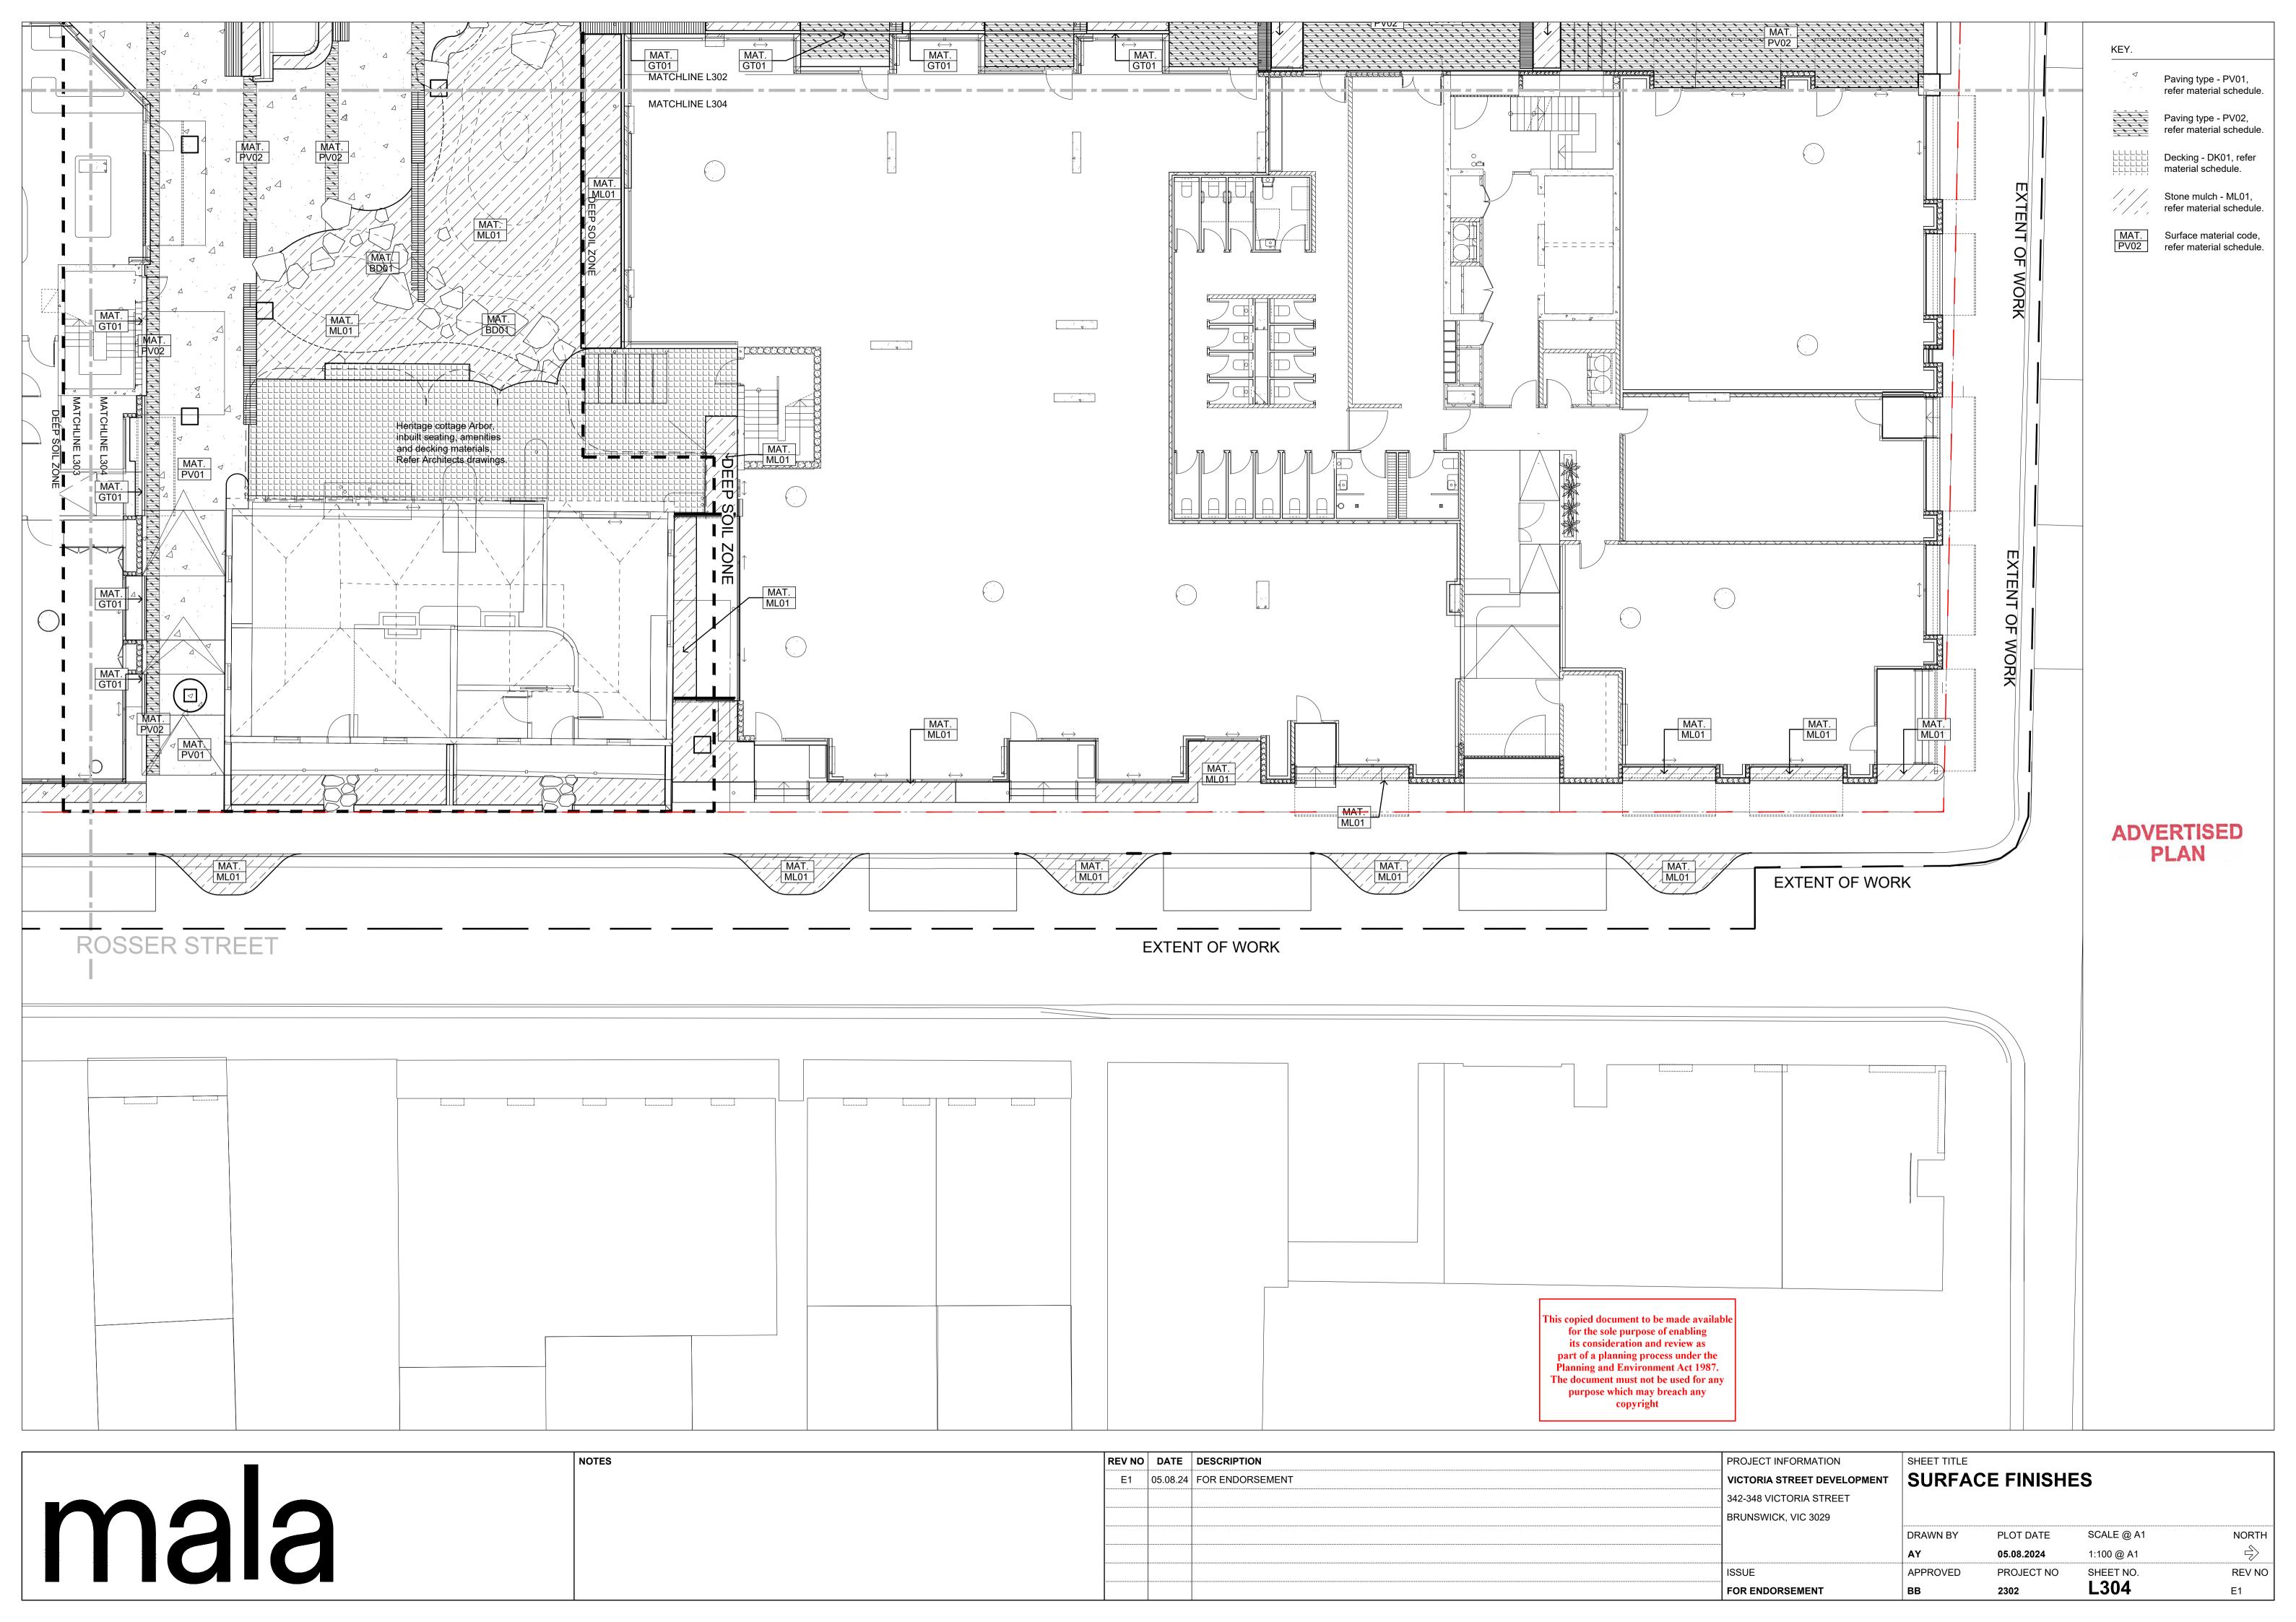

PLANTING SCHEDULE

Northern Lane

Pa	$\ $	ette
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		SIZE AT		
		MATURITY		
BOTANICAL NAME	COMMON NAME	HxW (m)	POT SIZE (install)	DENSITY

15 x 5

40L

As Shown

QLD Bottle Tree

Brachychiton rupestris

Low/ Meduim planting				
Dichondra argenea	Silver falls	0.1 x 0.8	140mm	6 p/sqm
Banksia blechnifolia	Ground cover banksia	0.5 x 2-4	140mm	6 p/sqm
Maireana sedifolia	Blue Bush	1 x 1	140mm	4 p/sqm
Osteospermum sp.	African daisies	0.25 x 0.5	140mm	6 p/sqm
Alyxia buxifolia	Sea Box	0.5 x 0.5	140mm	4 p/sqm
Doryanthes excelsa	Gymea Lily	1.5 x 1.5	140mm	1 p/sqm
Lotus berthelotii	Parrot-beak	0.2 x 0.6	140mm	6 p/sgm

Climbers

Wisteria floribunda	Japanese Wisteria	n/a	200mm	As Shown
Pandorea pandorana	Wonga Wonga Vine	n/a	200mm	As Shown

Southern Lane

Pallette

Lauria de la cina de la catina de				
BOTANICAL NAME	COMMON NAME	HxW (m)	POT SIZE (install)	DENSITY
		MATURITY		
		SIZE AT		

Low/ Medulin planting				
Asplenium scolopendrium	Hearts tongue fern	0.5 x 0.5	140mm	6 p/sqm
Asparagus densiflorus				
'Myersii'	Foxtail Fern	0.6 x 0.6	140mm	6 p/sqm
Thaumatophyllum xanadu	Filodendro Xanadu	1 x 1	140mm	6 p/sqm
Alcantarea imperialis	bromeliad	1 x 1	140mm	6 p/sqm
Vinca minor alba	Creeping Myrtle	0.5 x 1.5	140mm	6 p/sqm
Zamia furfuracea	Cardboard Palm	0.5 x 1	140mm	4 p/sqm
Dichondra repens	Kidney weed	0.1 x 1	140mm	6 p/sqm

Climbers

Schizophragma	Japanese Hydrangea					
hydrangeoides	Vine	n/a	200mm	As Shown		
monstera deliciosa		n/a	200mm	As Shown		

Central Garden

Pallette

		SIZE A I		
		MATURITY		
BOTANICAL NAME	COMMON NAME	HxW (m)	POT SIZE (install)	DENSITY

11000				
Toona ciliata	Australian Red Cedar	25+ x 12+	40L	As Shown
Tristaniopsis laurina			40L or 100L (for	
Lushious	Water gum	7 – 12m x 6m	street trees)	As Shown
Fraxinus pennsylvanica	Urbdell' Urbanite	11 x 8	40L	As Shown

Low/ Meduim planting

-out modamin planting				
Asplenium australasicum	Bird's nest fern	1 x 1	140mm	1 p/sqm
Cyathea cooperi	lacy tree fern	3 x 2	140mm	1 p/sqm
Dichondra argenea	Silver falls	0.1 x 0.8	140mm	6 p/sqm
Dichondra repens	Kidney weed	0.1 x 1	140mm	6 p/sqm
Alocasia brisbanensis	cunjevoi	1 x 1	140mm	2 p/sqm
Doodia australis	Common Rasp Fern	0.5 x 0.5	140mm	6 p/sqm
Zamia furfuracea	Cardboard Palm	0.5 x 1	140mm	4 p/sqm

Children						
Hardenbergia violaceae	Purple Coral Pea	n/a	200mm	As Shown		
Schizophragma	Japanese Hydrangea					
hydrangeoides	Vine	n/a	200mm	As Shown		
Cissus antarctica	Kangaroo Vine	n/a	200mm	As Shown		

Central Sunken

Garden Pallette

		SIZE AT		
		MATURITY		
BOTANICAL NAME	COMMON NAME	HxW (m)	POT SIZE (install)	DENSITY
Trees				
Toona ciliata	Australian Red Cedar	25+ x 12+	40L	As Shown
Tristaniopsis laurina			40L or 100L (for	
Lushious	Water gum	7 – 12m x 6m	street trees)	As Shown
Fraxinus pennsylvanica	Urbdell' Urbanite	11 x 8	40L	As Shown
. /84				
Low/ Meduim planting			1	
Crinum pedunculatum	Swamp lily	1 x 1	140mm	6 p/sqm
Dianella	Dianella Breeze	0.6 x 0.6	140mm	6 p/sqm
Dichondra repens	Kidney weed	0.1 x 1	140mm	6 p/sqm
Dianella tasmanica	Cherry red	1 x 1	140mm	6 p/sqm
Dianella	King alfred	0.7 x 0.7	140mm	6 p/sqm

 0.8×0.8

0.25 x 0.4

140mm

140mm

200mm

200mm

6 p/sqm

6 p/sqm

As Shown

As Shown

Club rush

Trachelospermum asiaticum | Japanese star jasmine | n/a

Asiatic pennywort

GRC Planter

Pallette

Ficinia nodosa

Centella asiatica

		SIZE AT		
		MATURITY		
BOTANICAL NAME	COMMON NAME	HxW (m)	POT SIZE (install)	DENSITY
Low/ Meduim planting				_
Grevillea juniperina	'Gold Cluster'	0.4 x 1.5	140mm	6 p/sqm
Dichondra argenea	Silver falls	0.1 x 0.8	140mm	6 p/sqm
Rosmarinus officinalis	'Prostrate' Rosemary	0.5 x 1	140mm	6 p/sqm
Lotus berthelotii	Parrot-beak	0.2 x 0.6	140mm	6 p/sqm
Rhapiolepis	Snow maiden	1 x 1	140mm	6 p/sqm
Casuarina 'Cousin It'	Cousin It	0.25 x 1	140mm	6 p/sqm
Climbers				
Wisteria floribunda	Japanese Wisteria	n/a	200mm	As Shown
Hardenbergia violaceae	Purple Coral Pea	n/a	200mm	As Shown

Ornimeltal Grape n/a

Roof Profile

Vitis vinifera

Pallette

		SIZE AT		
		MATURITY		
BOTANICAL NAME	COMMON NAME	HxW (m)	POT SIZE (install)	DENSITY
Low/ Meduim planting				
Aptenia cordifolia	Baby Sun Rose	0.15 x 0.6	140mm	6 p/sqm
Carpobrotus glaucescens	Pigface	0.1 x 1	140mm	6 p/sqm
Myoporum insulare	Ground Cover			
'Prostrate'	Boobialla	0.5 x 1	140mm	6 p/sqm
Myoporum parvifolium				
(broad leaf)	Creeping Boobialla	0.3 x 1	140mm	6 p/sqm
disphyma crassifolia	Creeping dew plant	0.2 x 1	140mm	6 p/sqm
Banksia blechnifolia	Ground cover banksia	0.5 x 2-4	140mm	6 p/sqm

Rooftop Garden

Pallette

BOTANICAL NAME	COMMON NAME	HxW (m)	POT SIZE (install)	DENSITY
Low/ Meduim planting				
Banksia blechnifolia	Ground cover banksia	0.5 x 2-4	140mm	6 p/sqm
Dichondra argenea	Silver falls	0.1 x 0.8	140mm	6 p/sqm
Leucophyta brownii	Cushion bush	0.8 x 0.8	140mm	4 p/sqm
Senecio mandraliscae	blue chalksticks	0.2 x 1	140mm	6 p/sqm
Lomandra	Seascape	0.5 x 0.75	140mm	4 p/sqm
Dichondra argenea	Silver falls	0.1 x 0.8	140mm	6 p/sqm
Rosmarinus officinalis	'Prostrate' Rosemary	0.5 x 1	140mm	6 p/sqm
Casuarina 'Cousin It'	Cousin It	0.25 x 1	140mm	6 p/sqm
Doryanthes excelsa	Gymea Lily	1.5 x 1.5	140mm	1 p/sqm
Alyxia buxifolia	Sea Box	0.5 x 0.5	140mm	4 p/sqm

SIZE AT MATURITY

Climbers

Cillibera				
Wisteria floribunda	Japanese Wisteria	n/a	200mm	As Shown
Hardenbergia violaceae	Purple Coral Pea	n/a	200mm	As Shown
Trachelospermum asiaticum	Japanese star jasmine	n/a	200mm	As Shown
Vitis vinifera	Ornimeltal Grape	n/a	200mm	As Shown

Cottage Garden

Pallette

		SIZE AT		
		MATURITY		
BOTANICAL NAME	COMMON NAME	HxW (m)	POT SIZE (install)	DENSITY

Low/ Meduim planting

Lomandra longifolia 'Tanika'	Mat Rush	0.5-0.6 x 0.65	140mm	As Shown
Lomandra confertifolia				
'Seascape'	Lomandra Seascape	0.5 x 0.75	140mm	As Shown
Dianella tasmanica	Tasman Flax-lily	0.6-1.5 x 0.5-2	140mm	As Shown

Estimated Canopy Cover

Trees at maturity

Species	Number proposed	Estimated canopy size at maturity (Diameter)	Total canopy area (m2)
Toona ciliata	1	12m	113
Tristaniopsis laurina			
Lushious	8	6m	224
Fraxinus pennsylvanica	3	8m	150
Brachychiton rupestris	8	5m	156
		Total tree	
		canopy	643

Arbor canopy at maturity

The contest of the co					
Arbor location	Arbor size (m2)				
Northern Arbor	37.14				
Western Arbor	42.24				
Southern Arbor	20.16				
Arbor Total	99.54				


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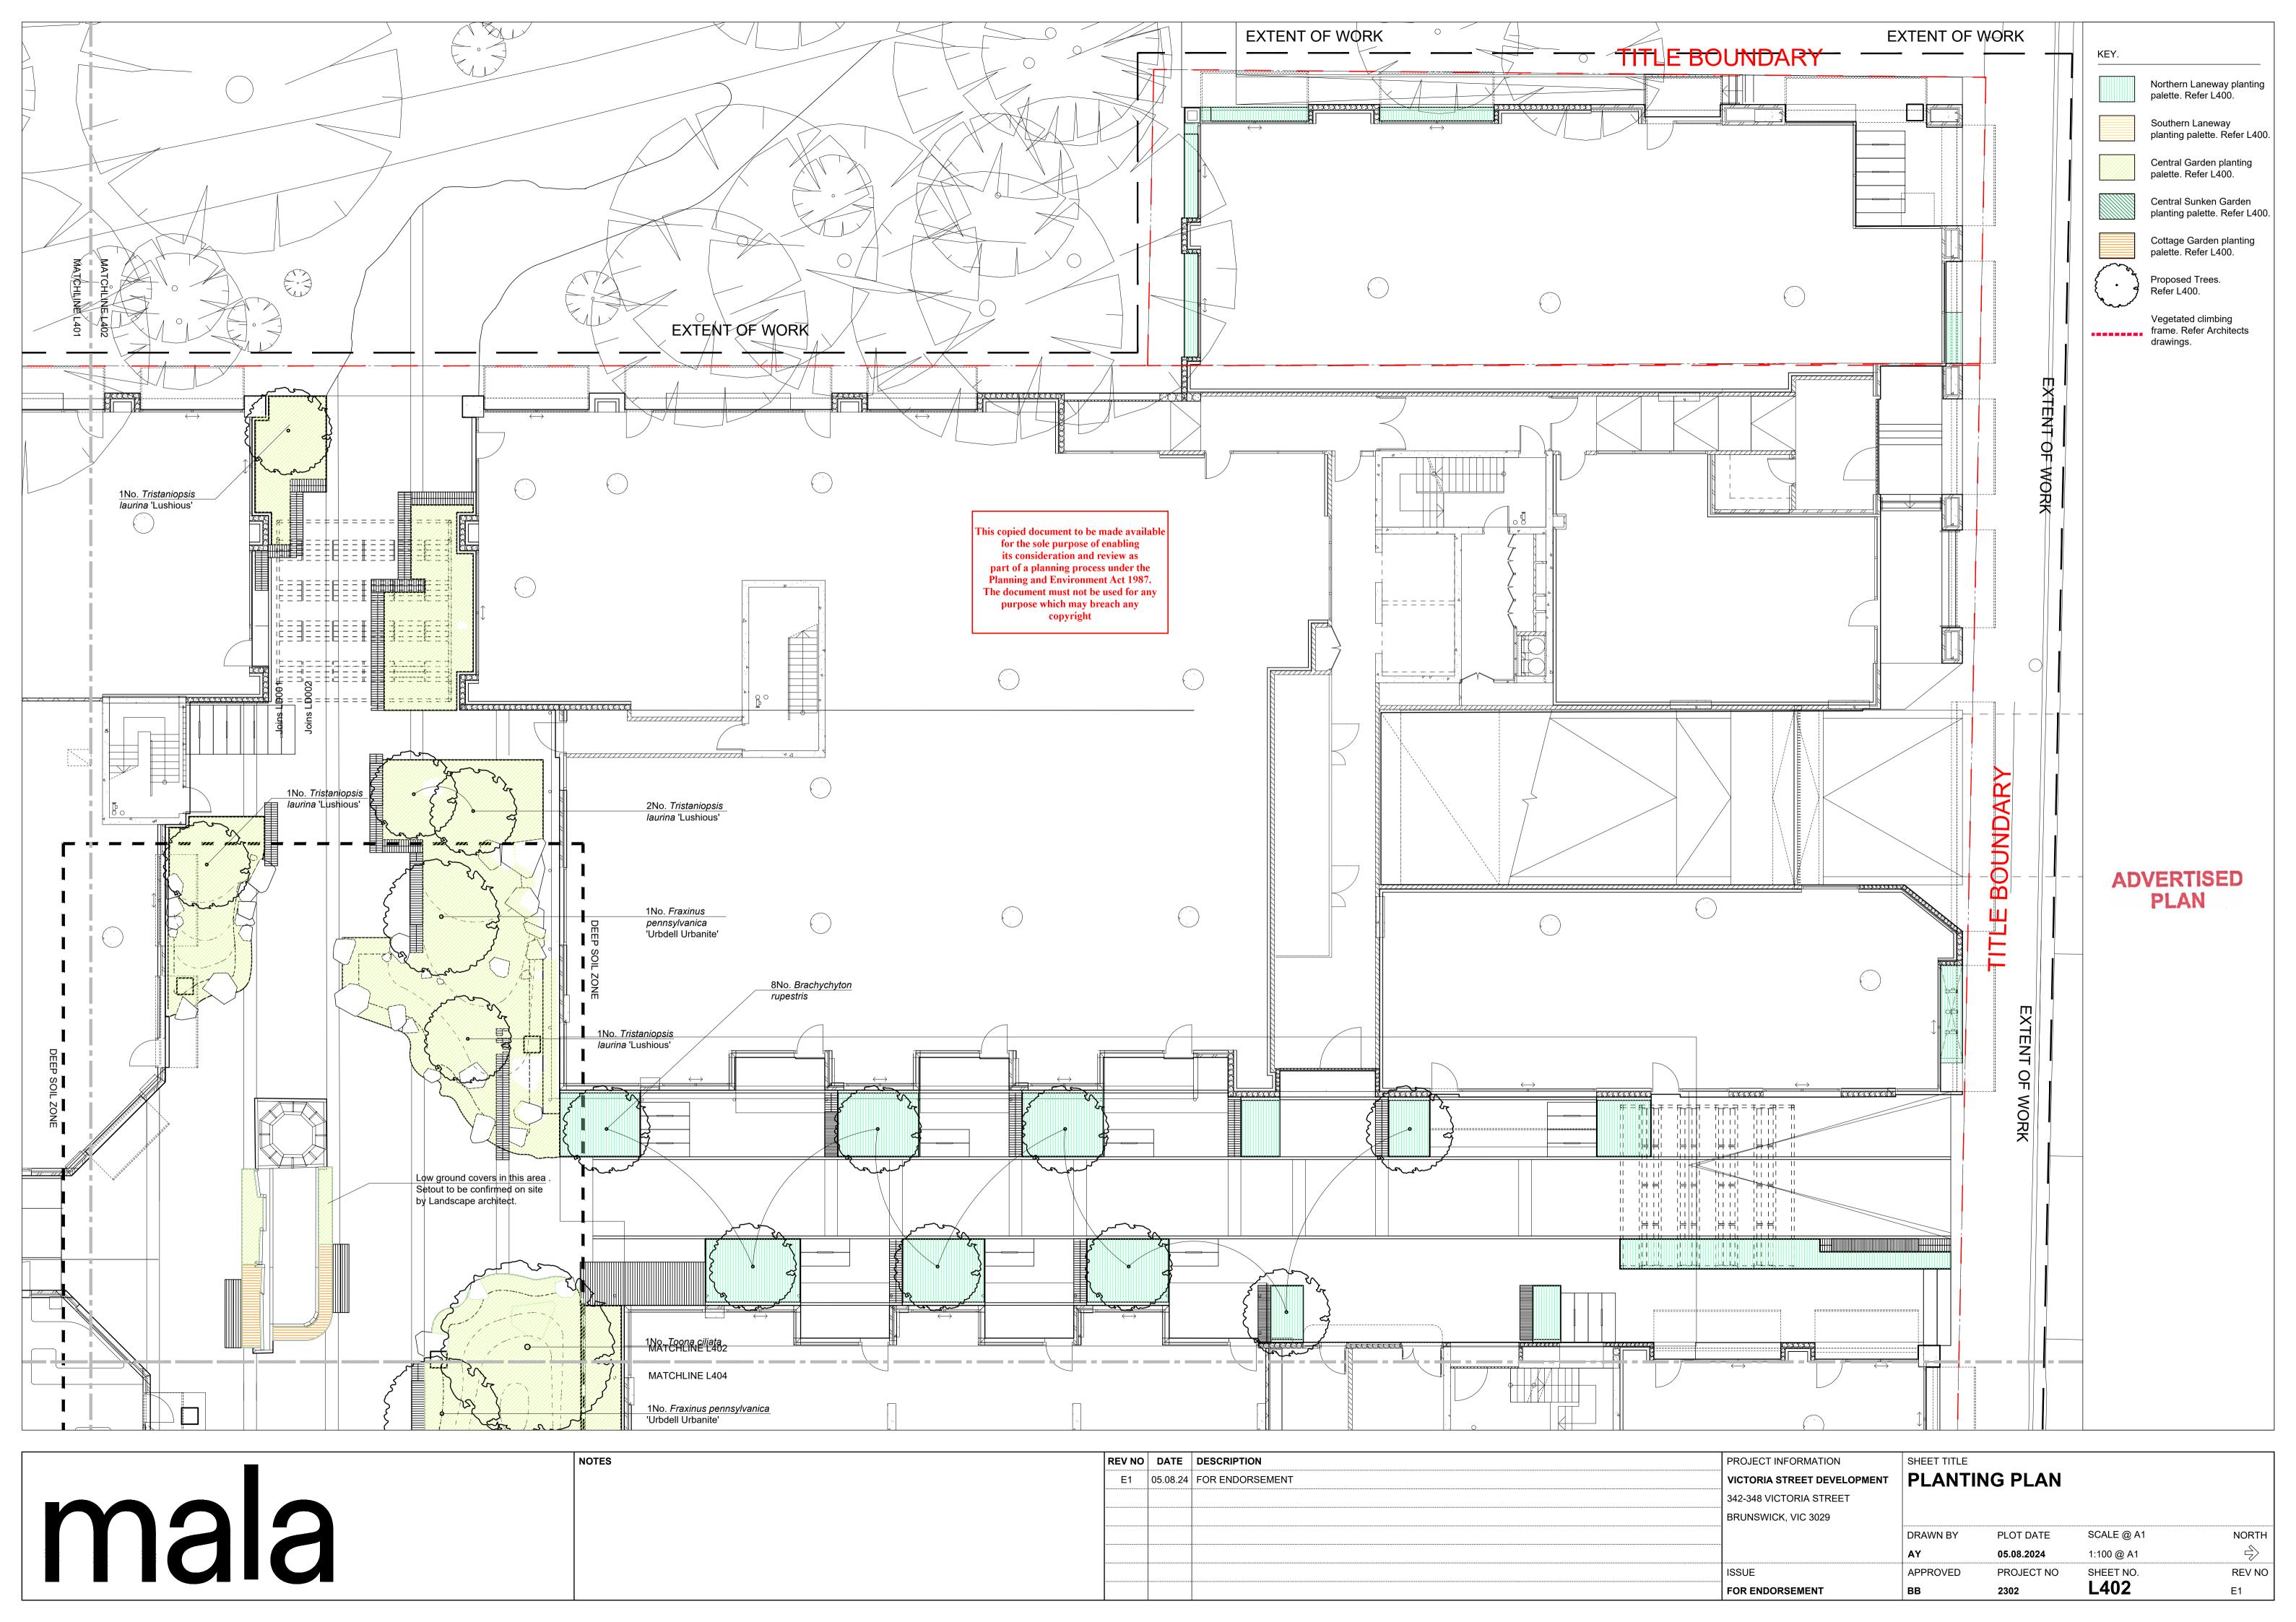
> **ADVERTISED PLAN**


Site ground plane canopy total (m2) 742.54





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	E1	05.08.24 FOR ENDORSEMENT	VICTORIA STREET DEVELOPMENT	PLANTING SCHEDULES			
			342-348 VICTORIA STREET				
			BRUNSWICK, VIC 3029				
				DRAWN BY	PLOT DATE	SCALE @ A1	NORTH
				AY	05.08.2024	N/A	\Rightarrow
			ISSUE	APPROVED	PROJECT NO	SHEET NO.	REV NO
			FOR ENDORSEMENT	ВВ	2302	L400	E1



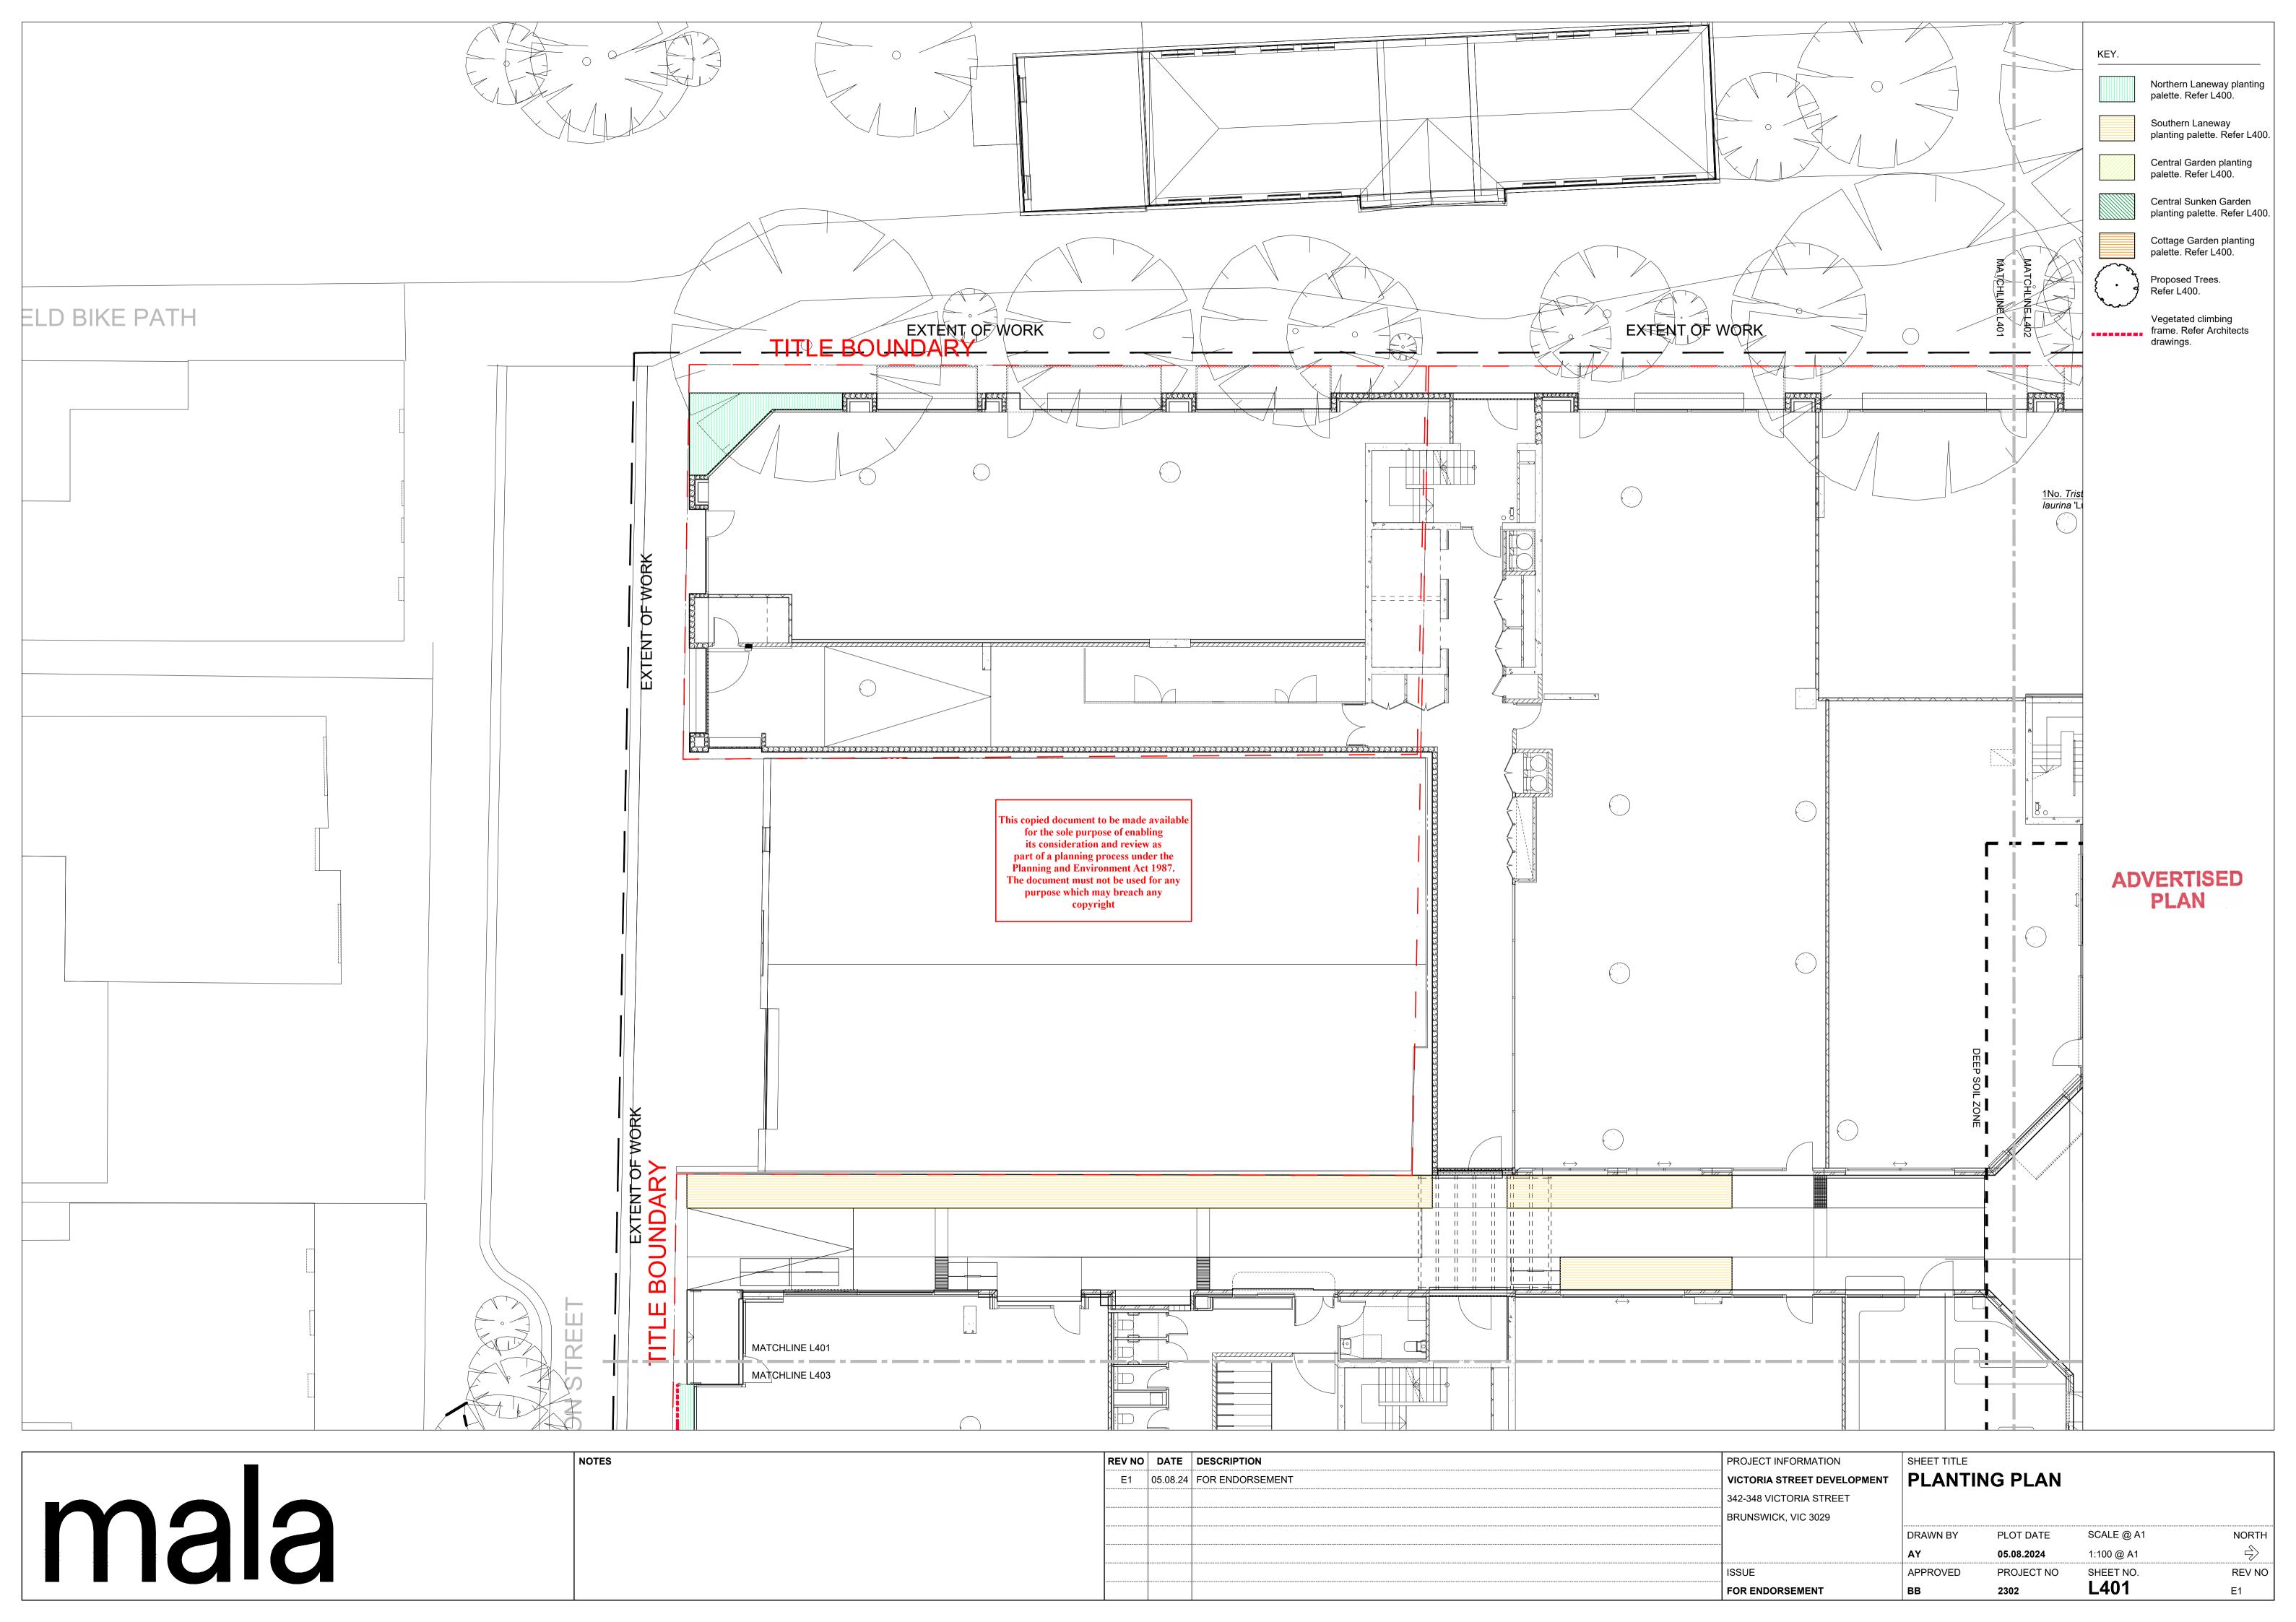

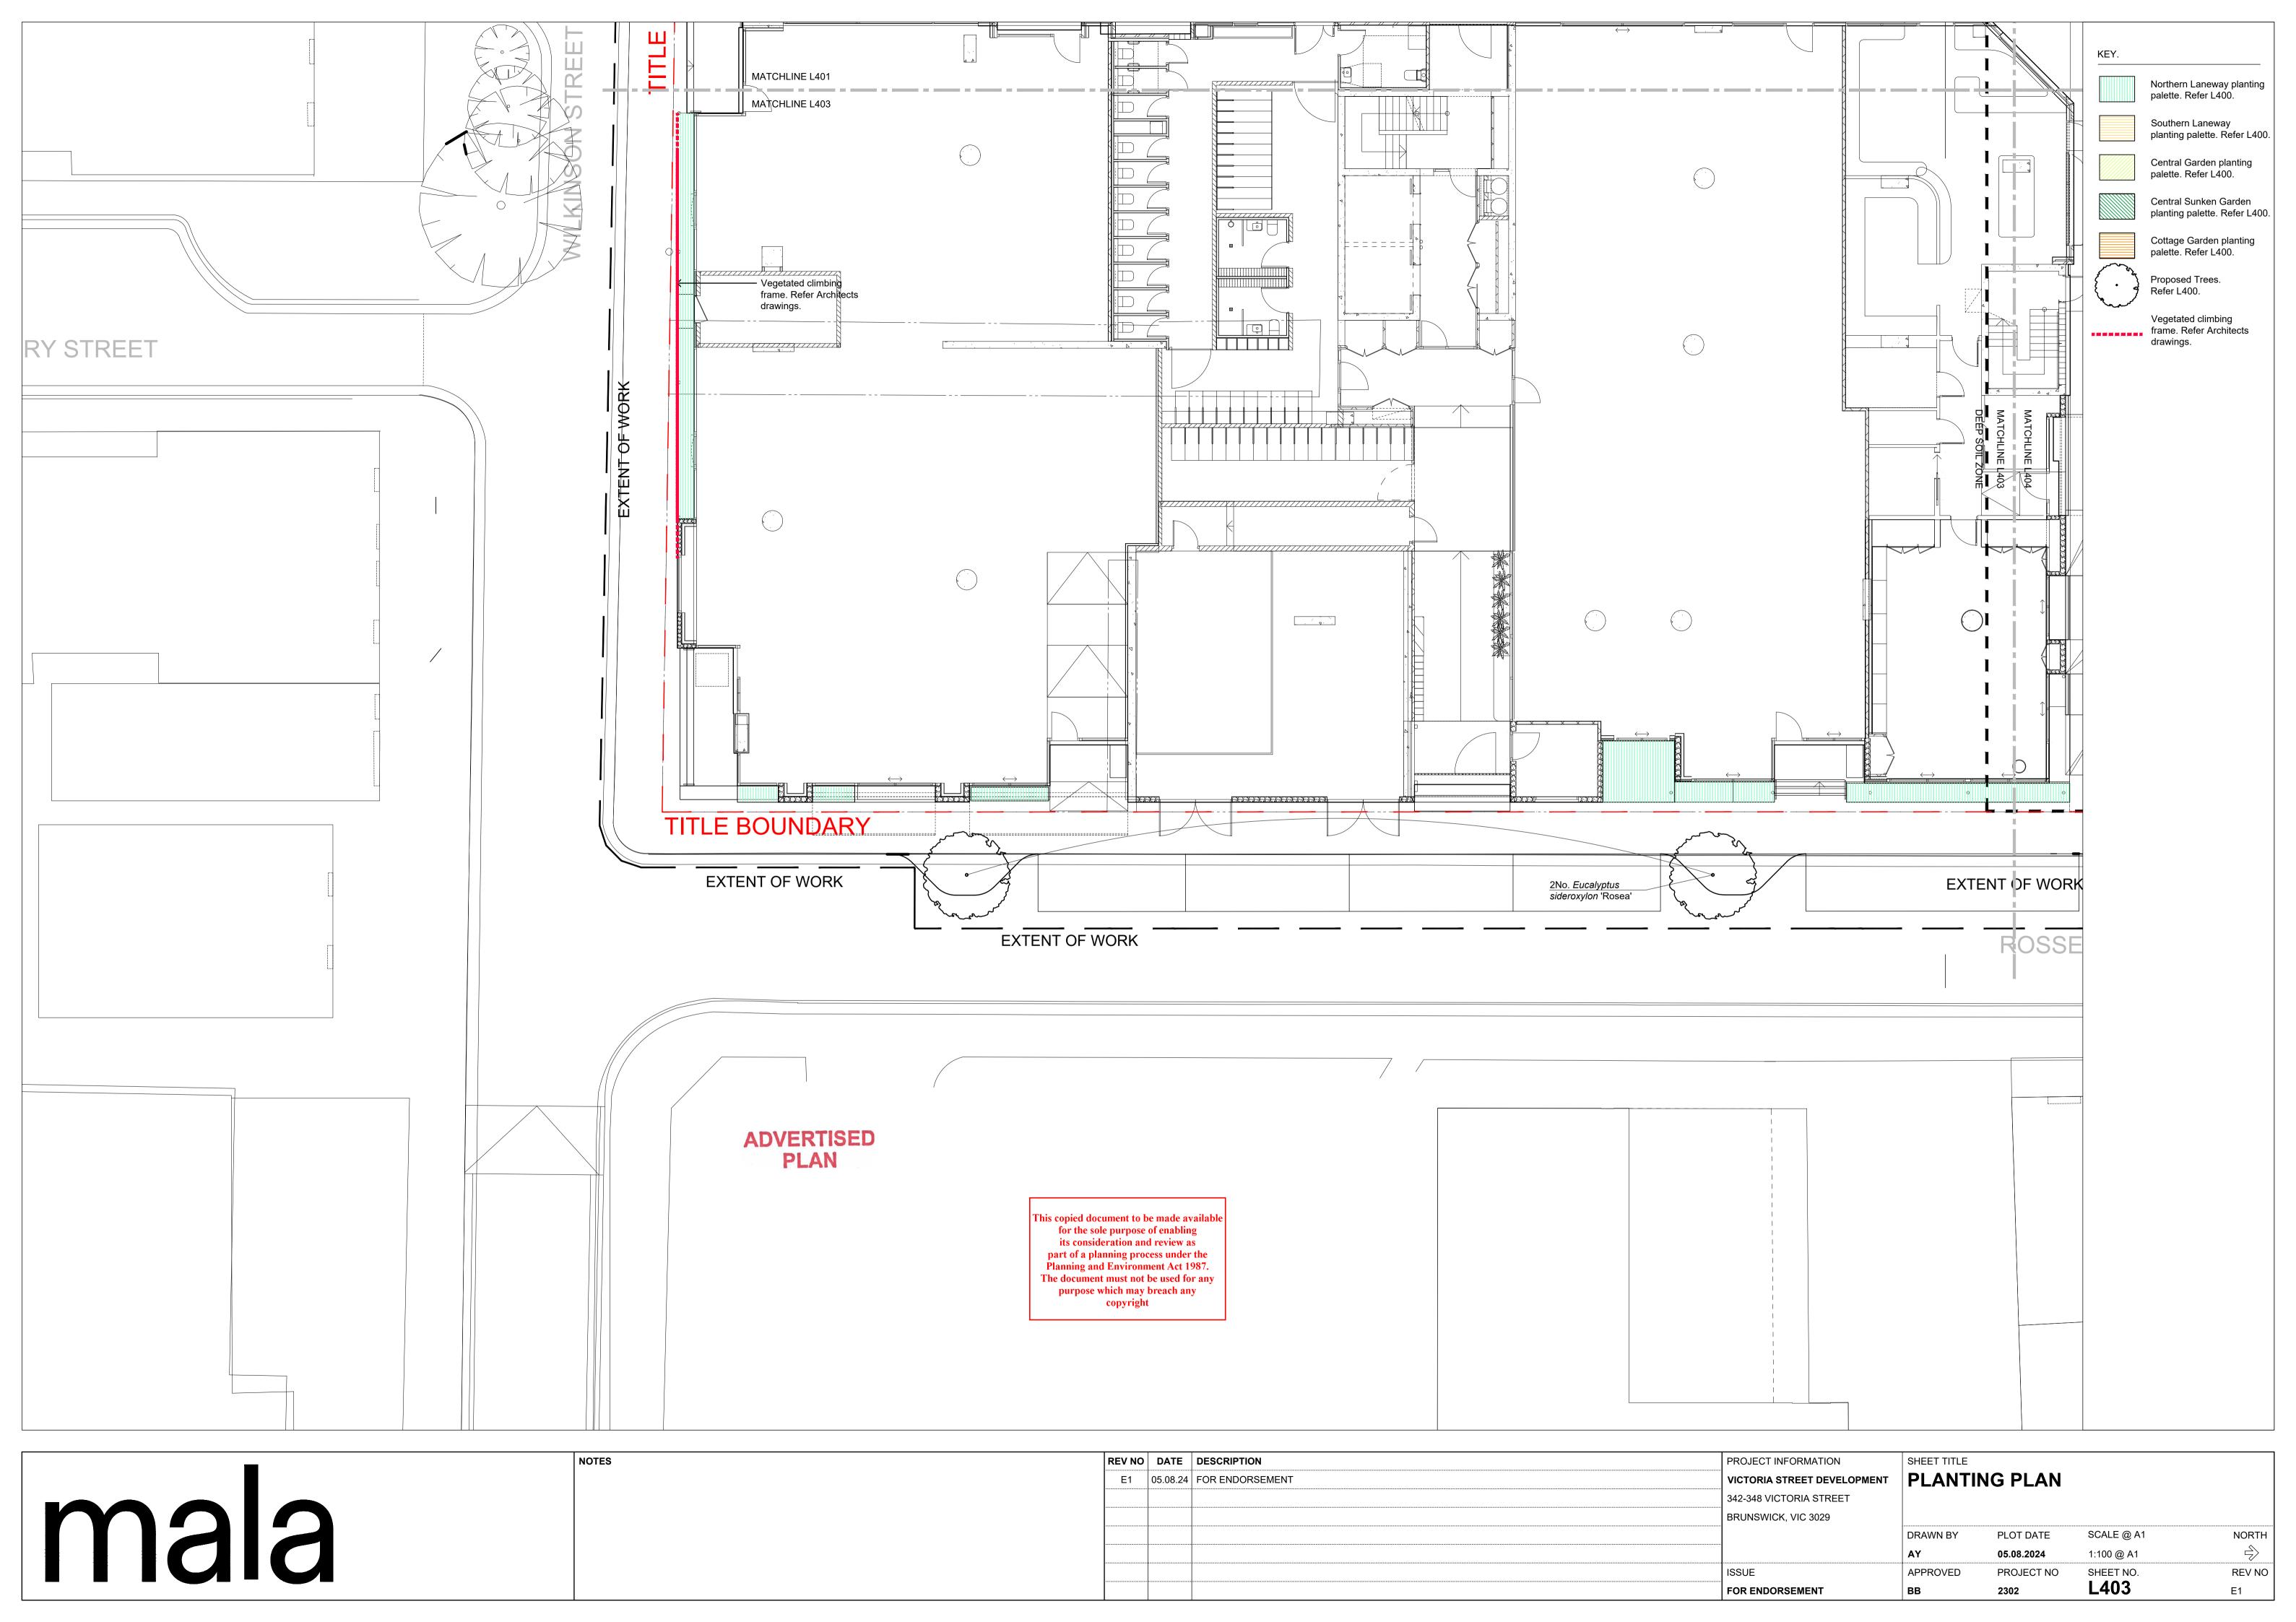

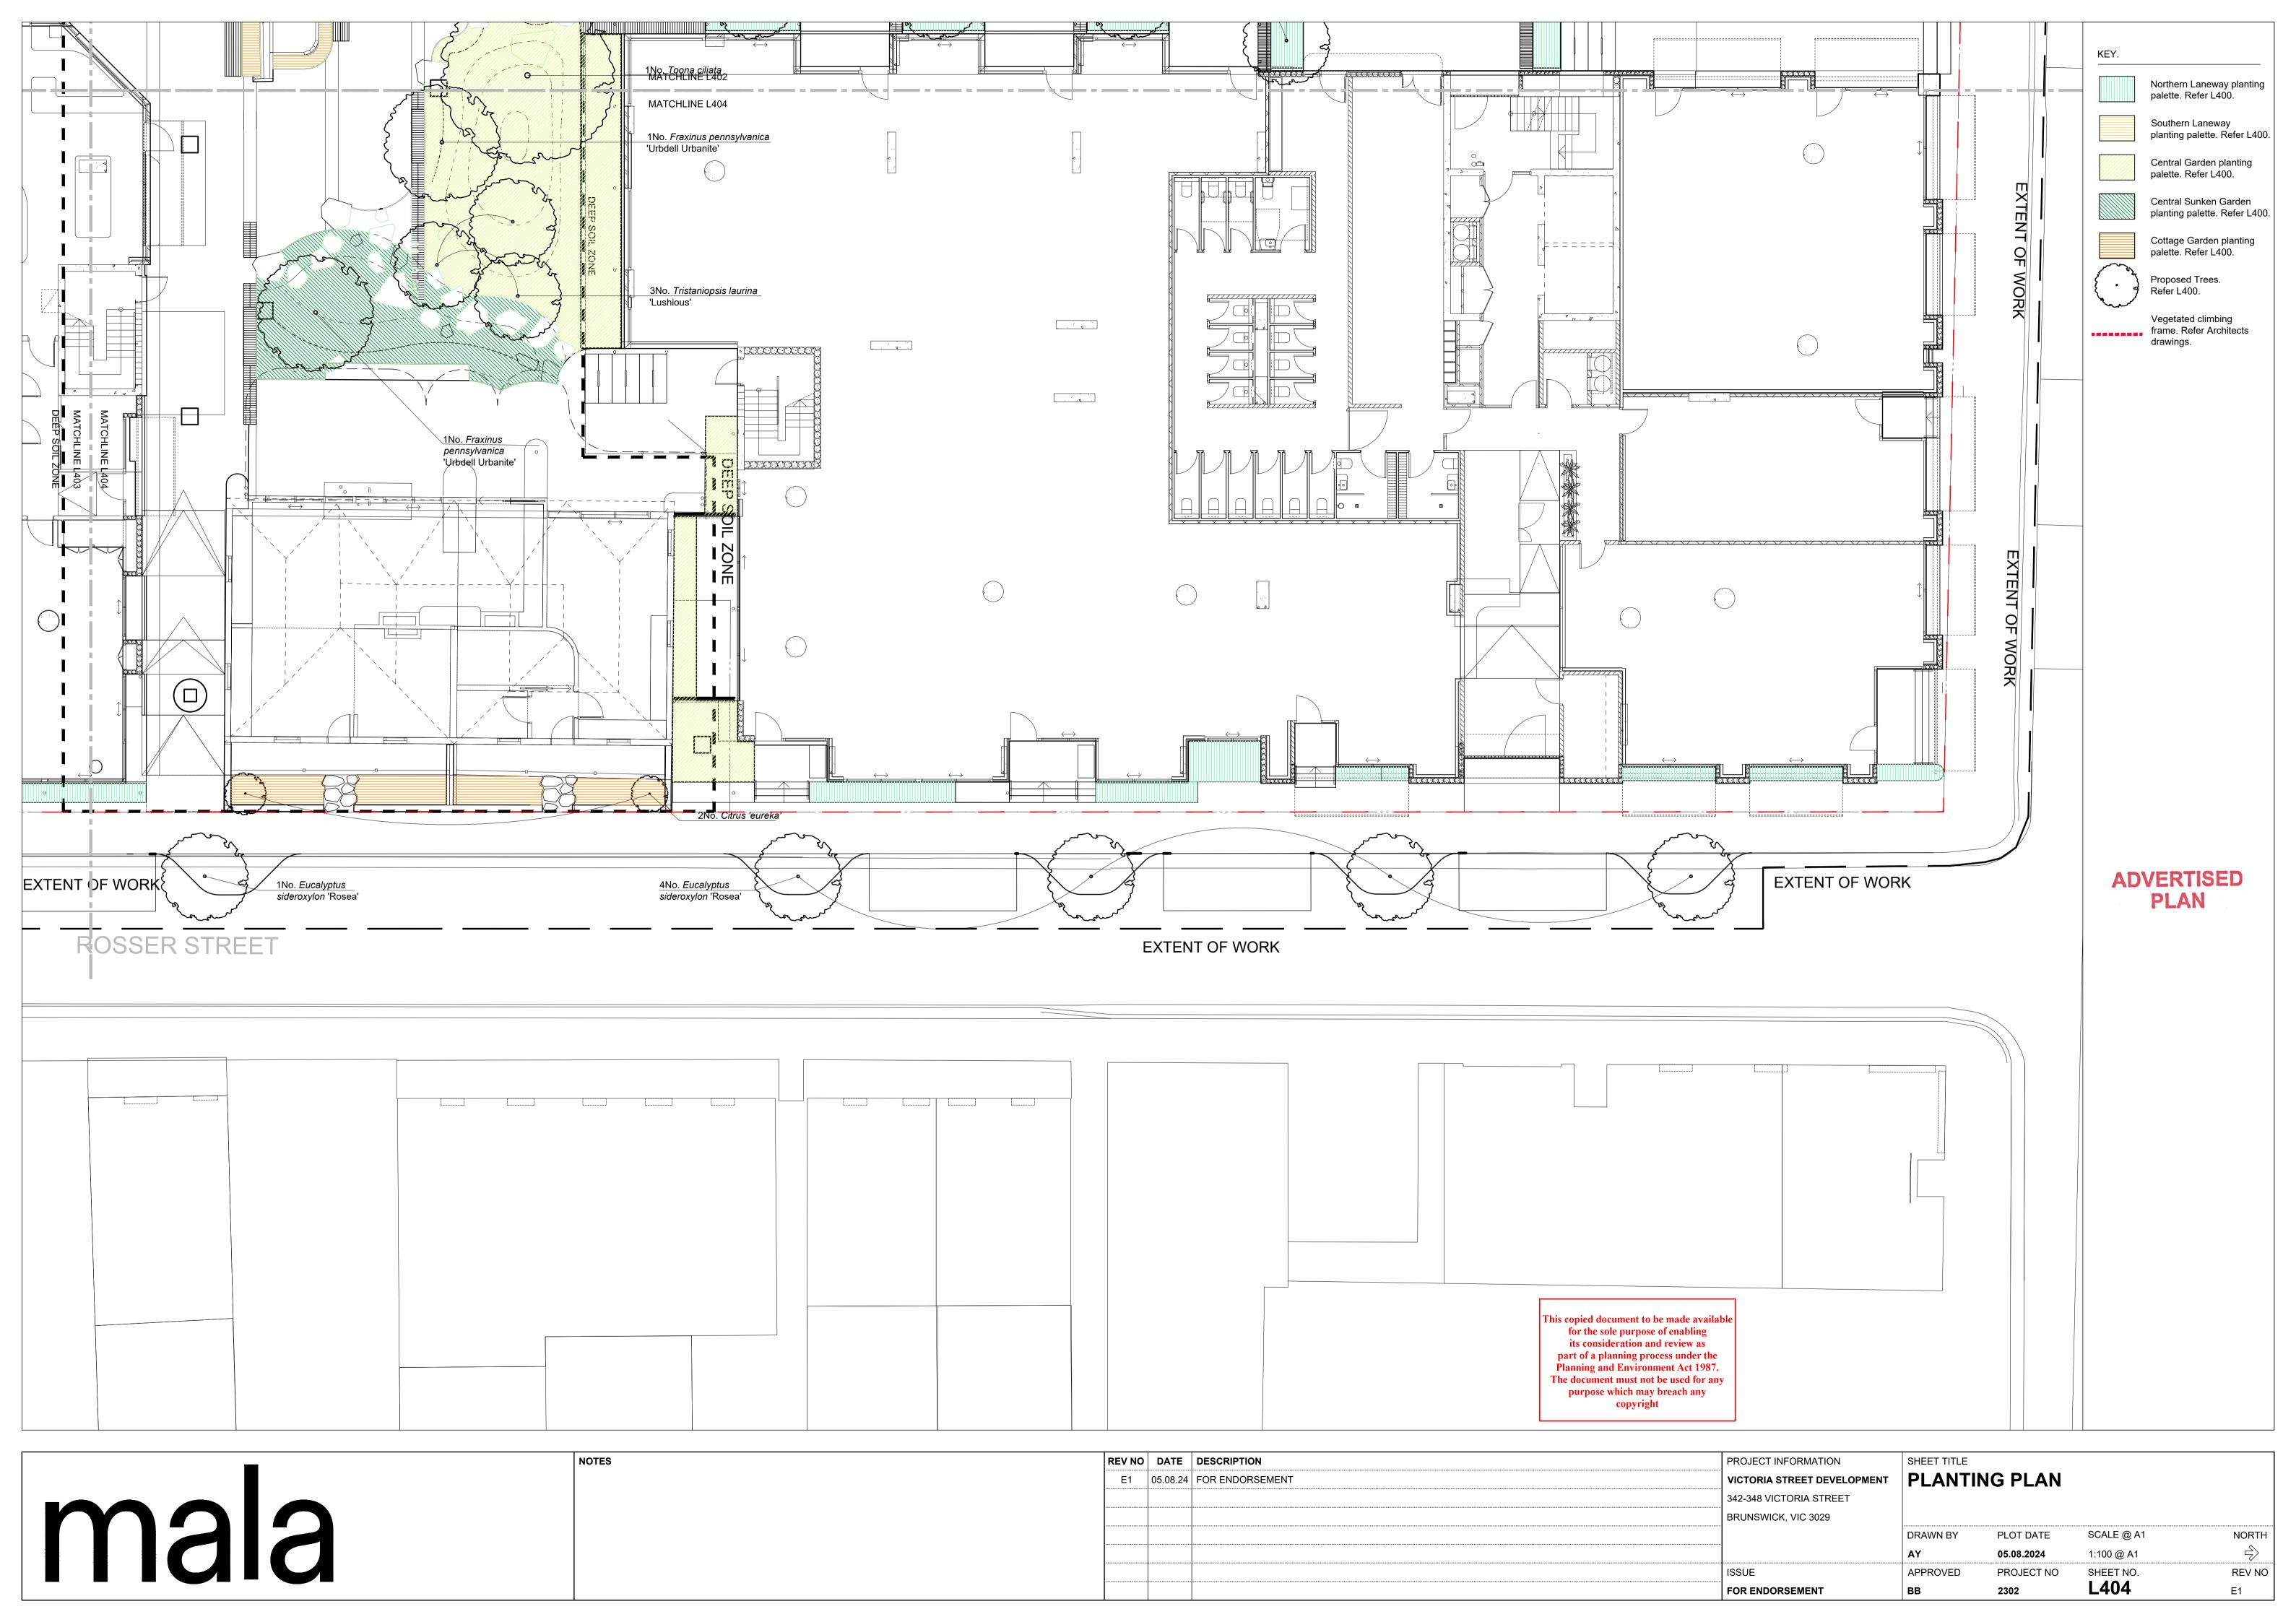

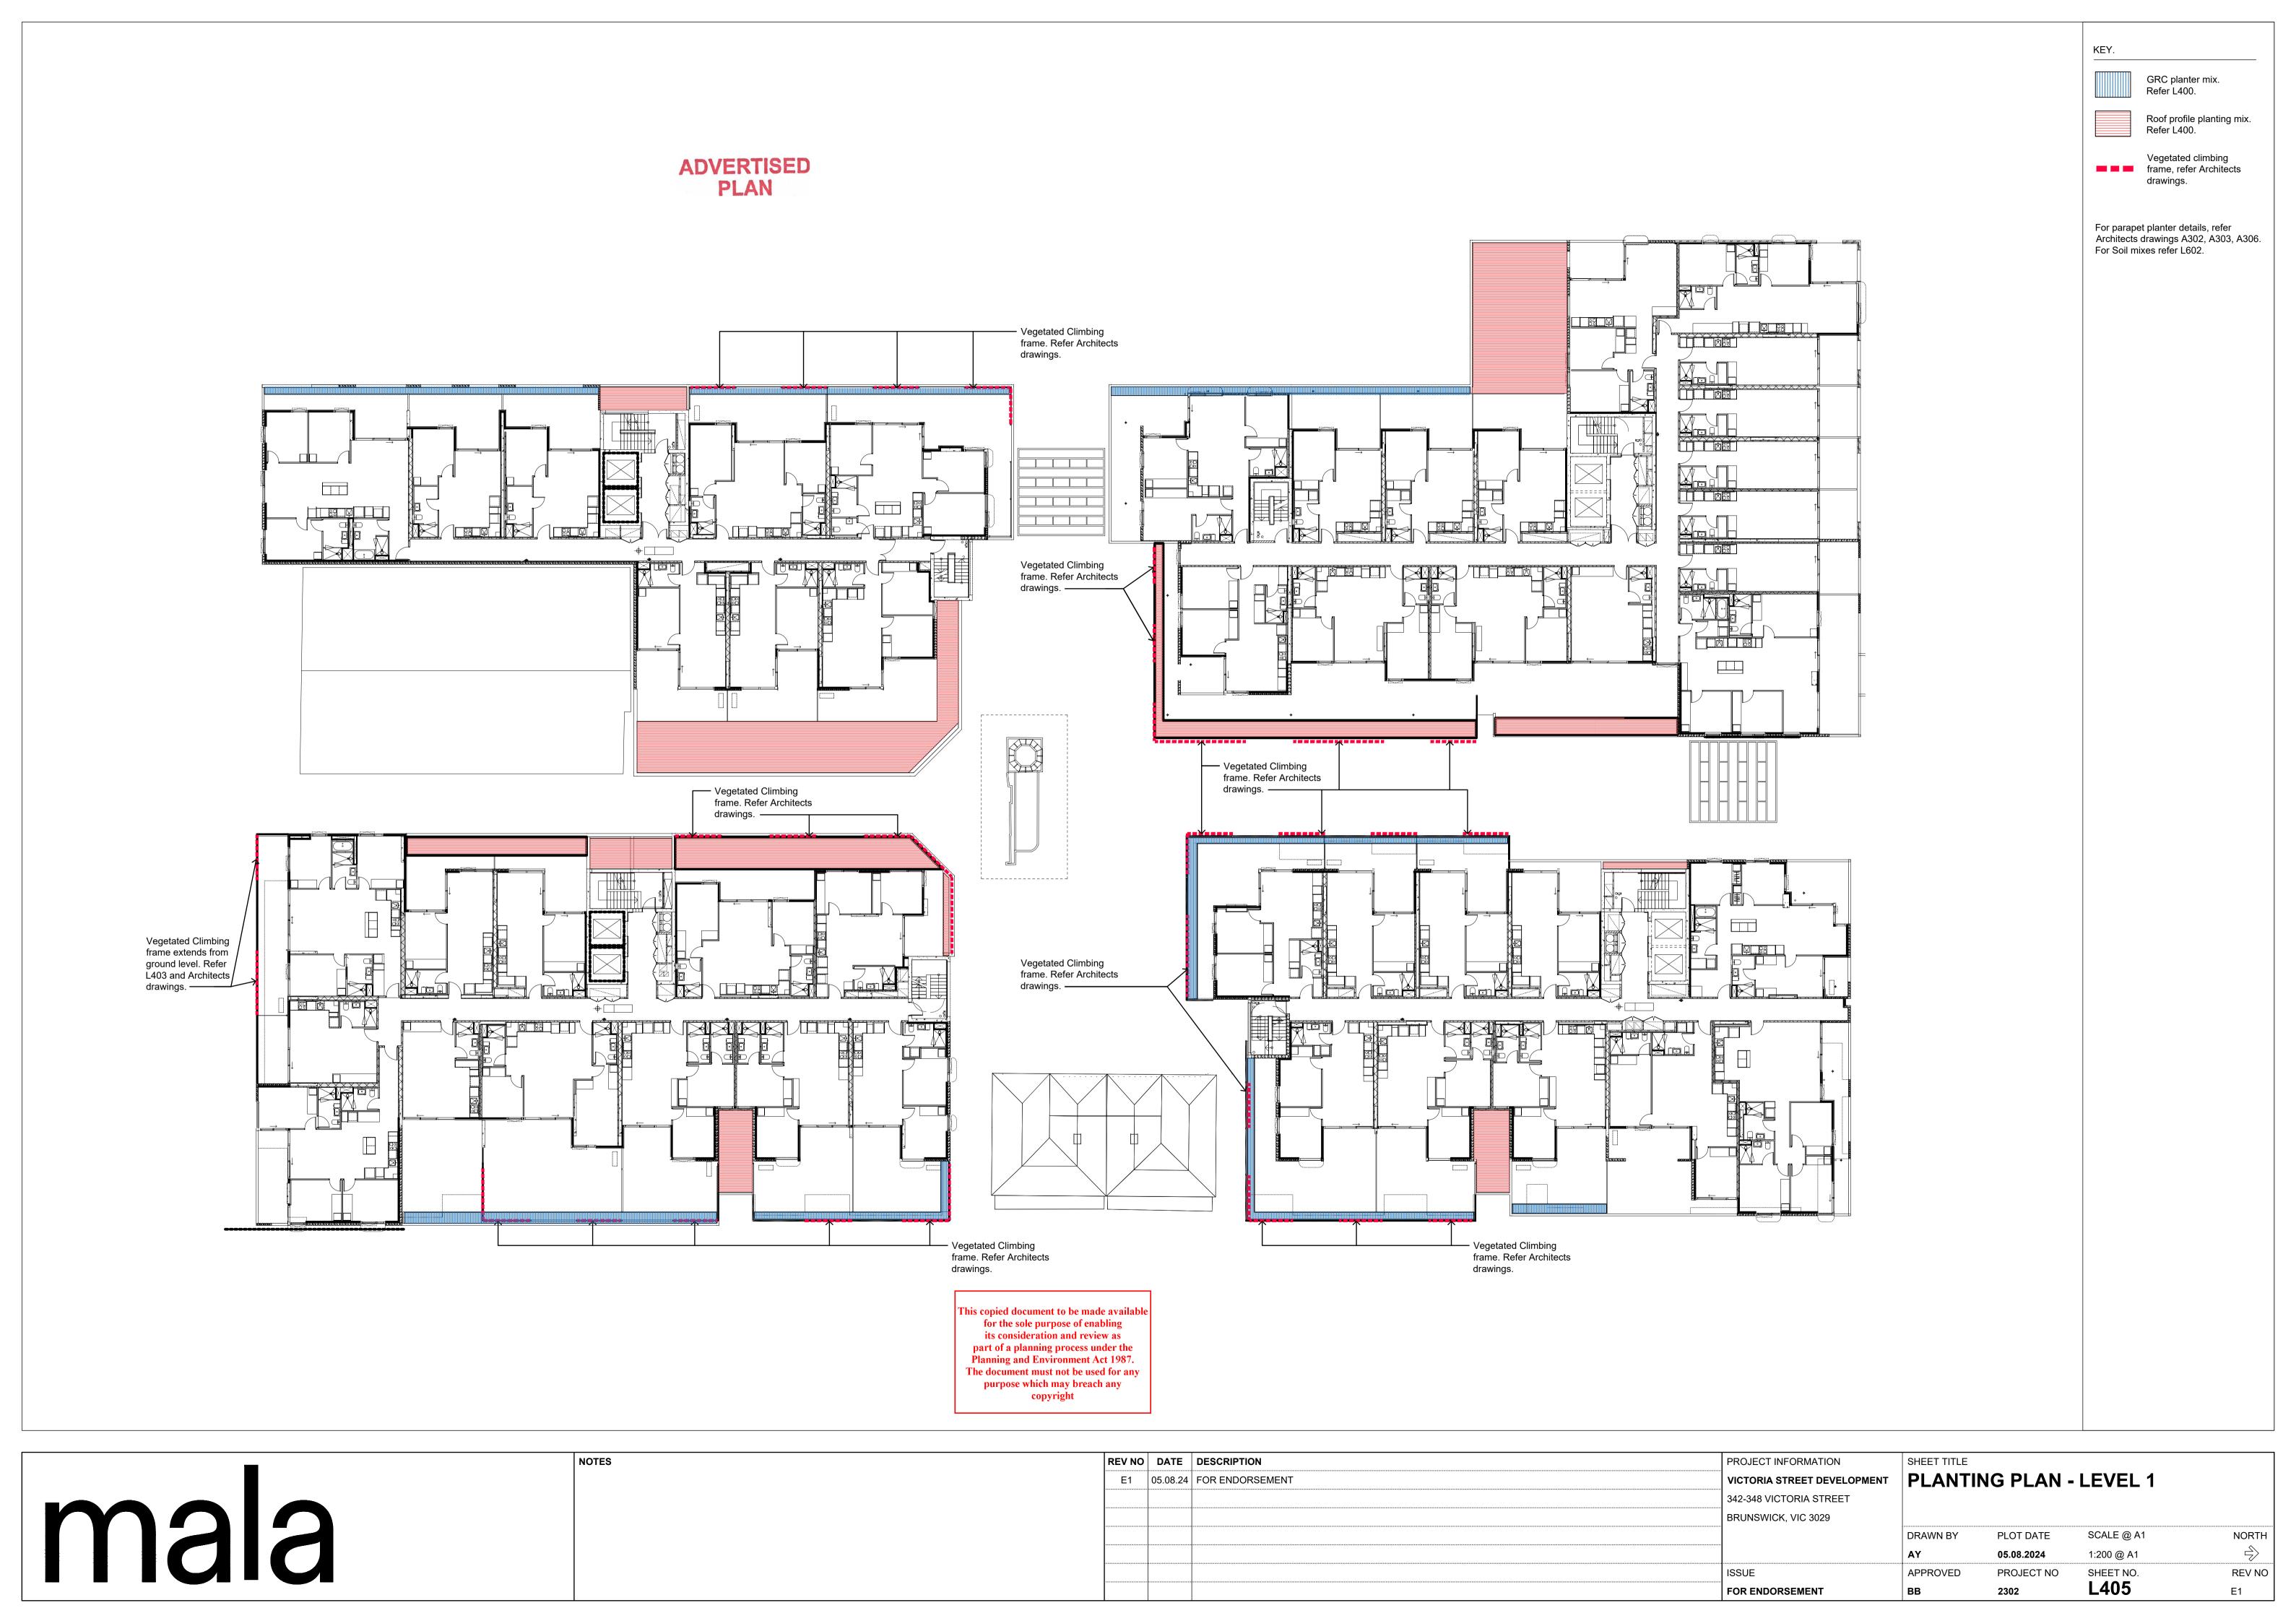




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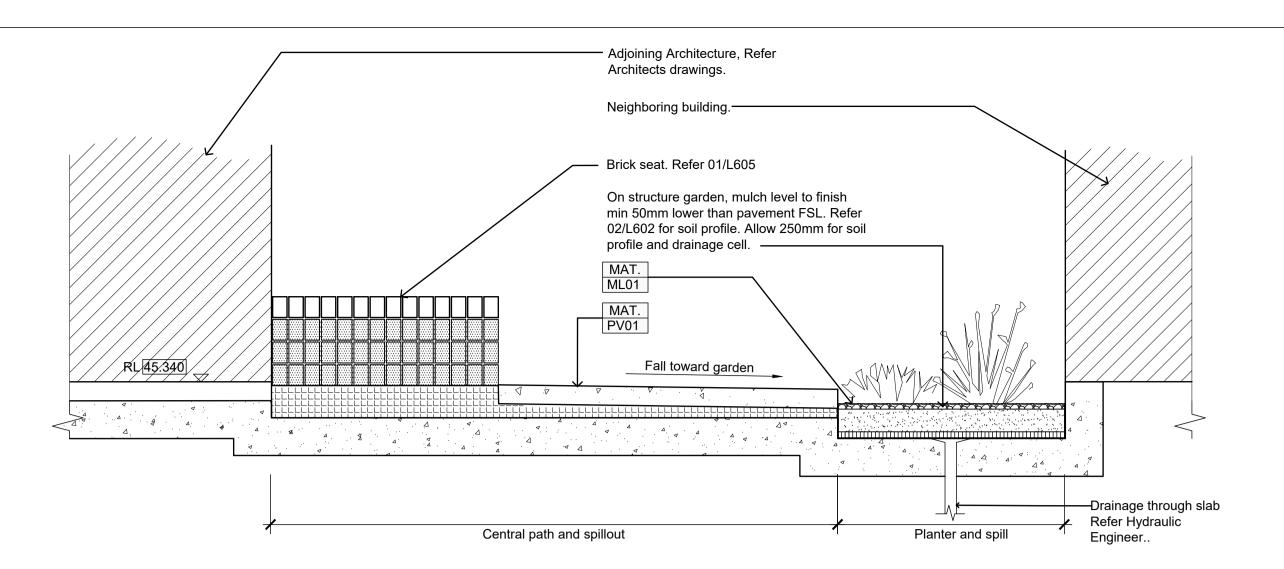
GRC planter mix. Refer L400

mix. Refer L400.

Roof Garden planting


NOTES REV NO DATE DESCRIPTION PROJECT INFORMATION PLANTING PLAN - ROOFTOP SPACES E1 05.08.24 FOR ENDORSEMENT VICTORIA STREET DEVELOPMENT mala 342-348 VICTORIA STREET BRUNSWICK, VIC 3029 SCALE @ A1 DRAWN BY PLOT DATE 1:200 @ A1 05.08.2024 REV NO SHEET NO. ISSUE APPROVED PROJECT NO L406 FOR ENDORSEMENT



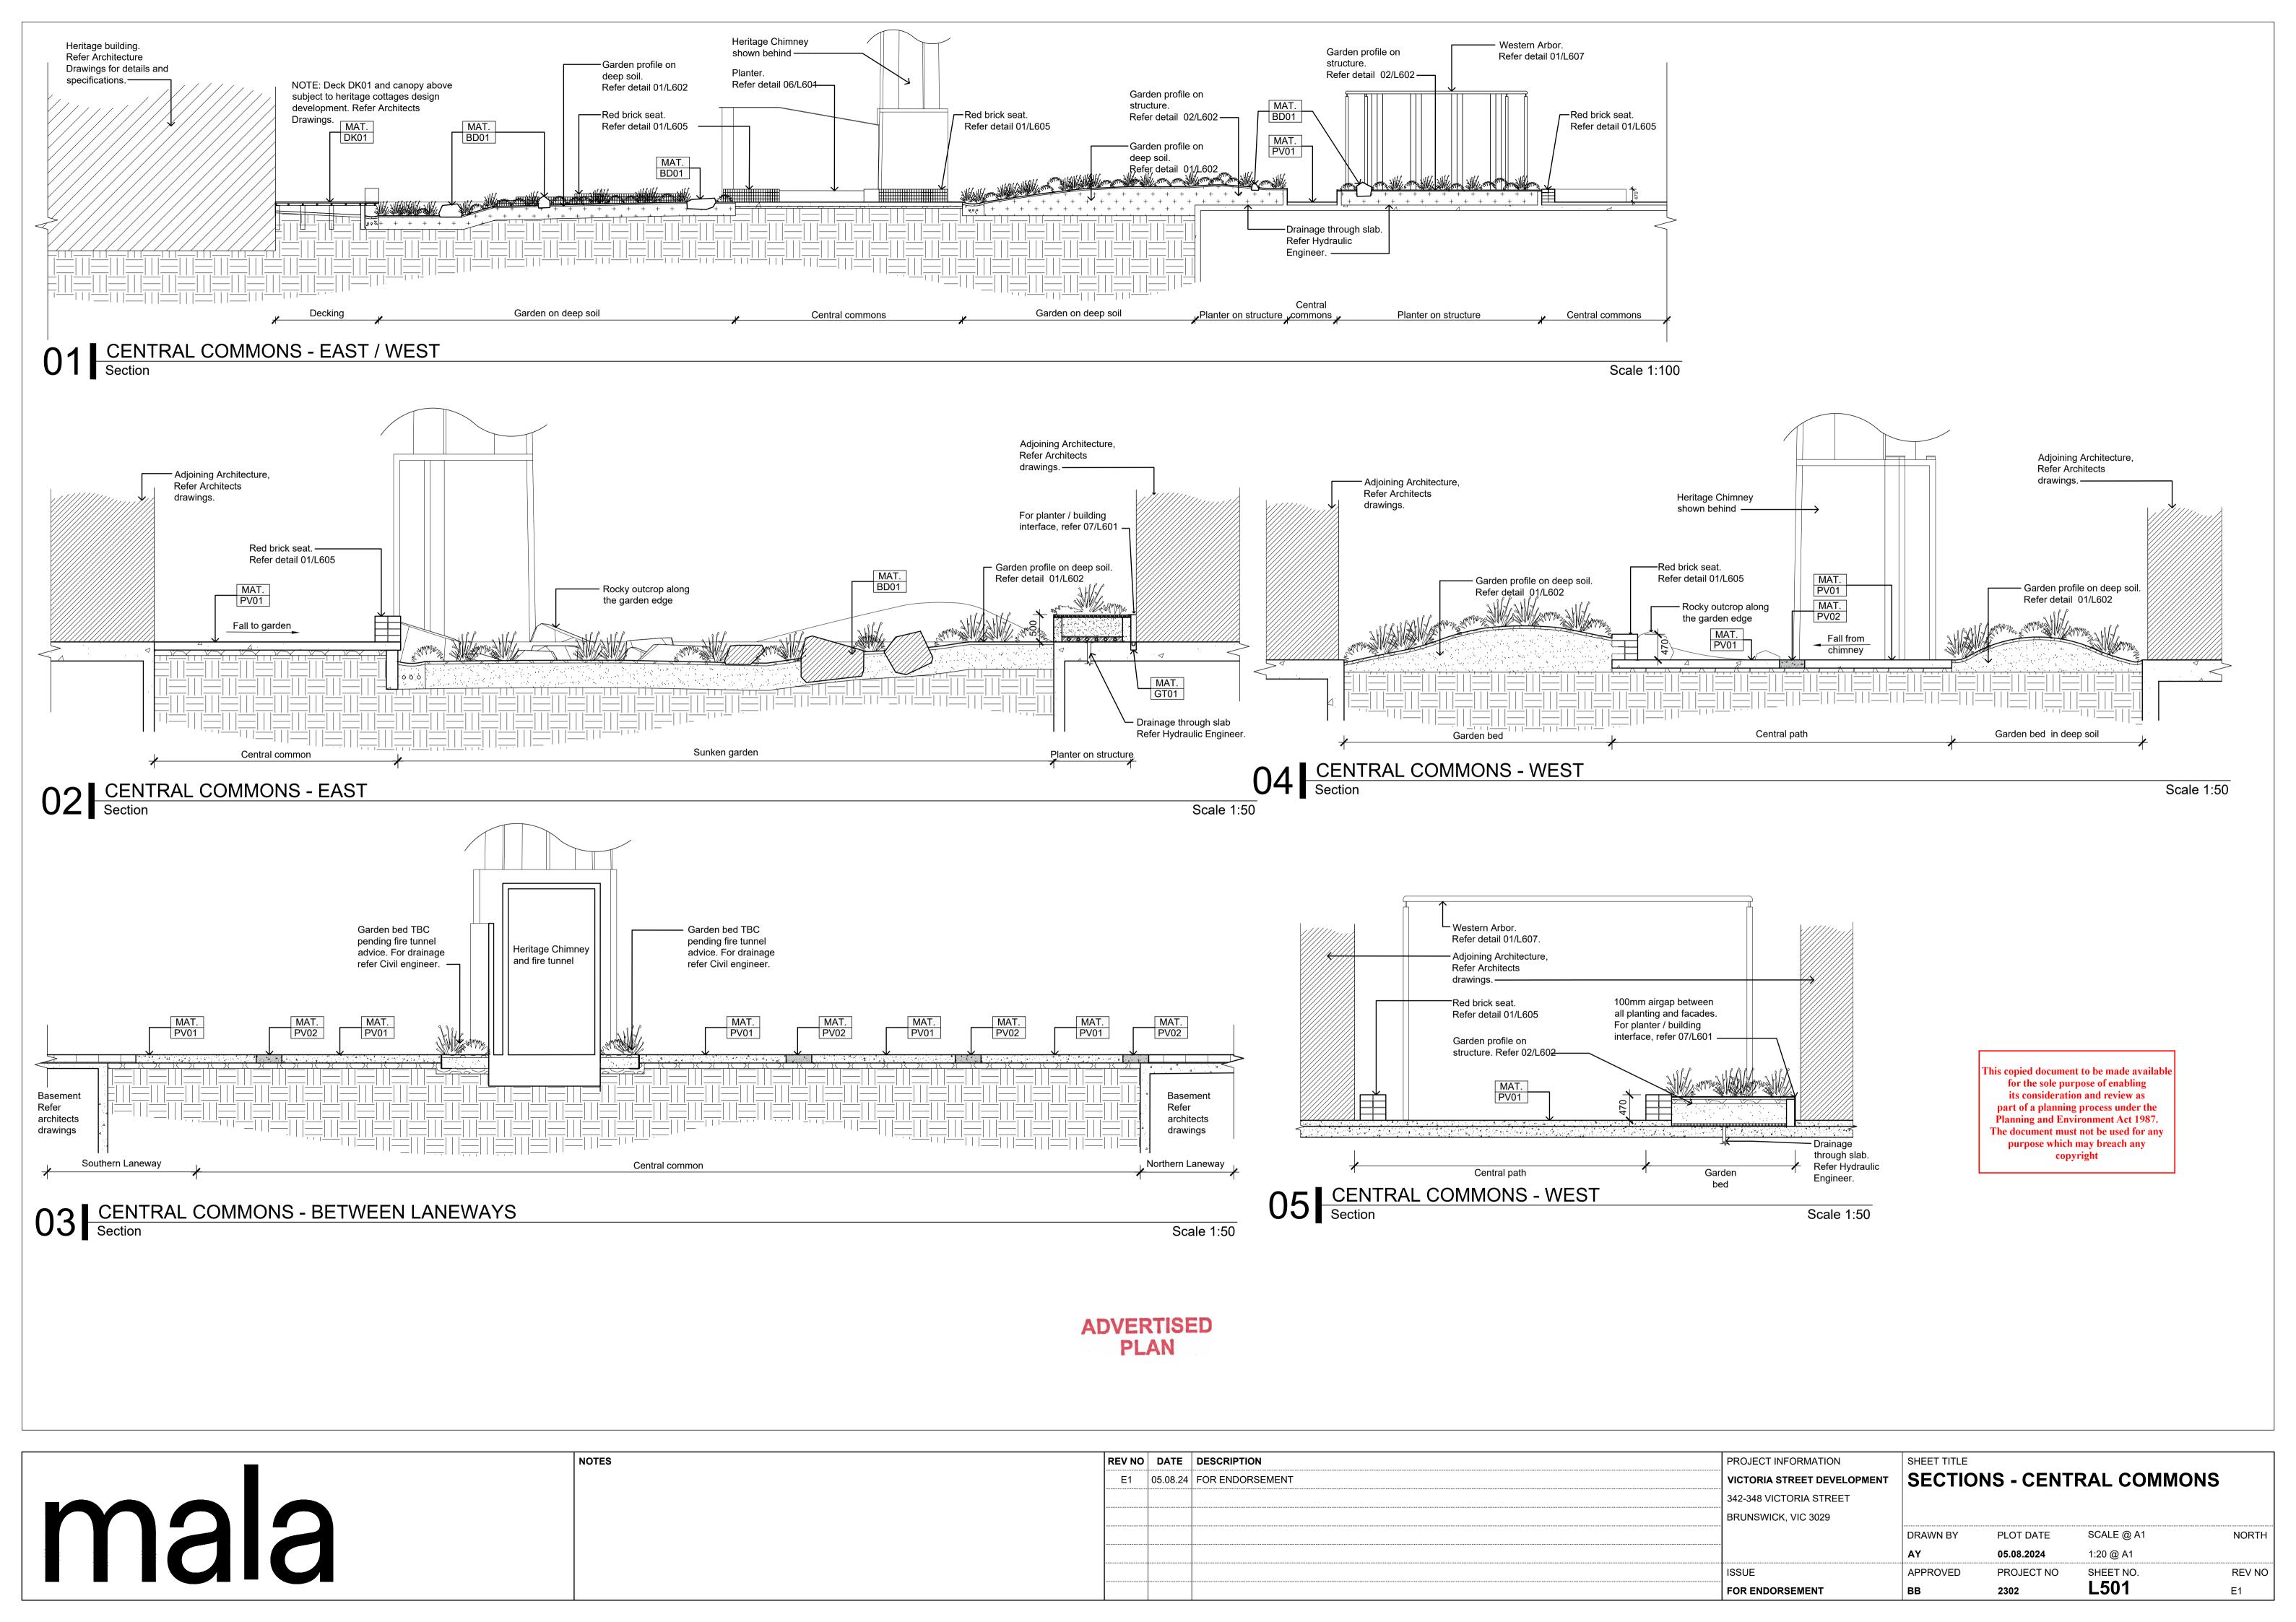


01 SOUTHERN LANEWAY
Section

Scale 1:20

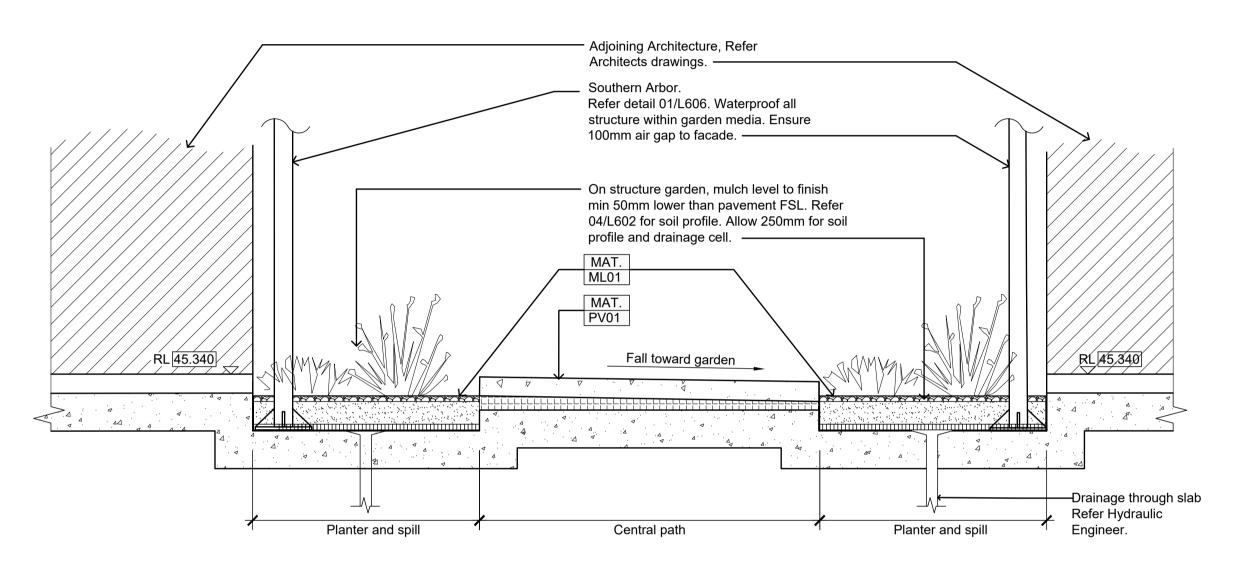

02 SOUTHERN LANEWAY
Section

Scale 1:20

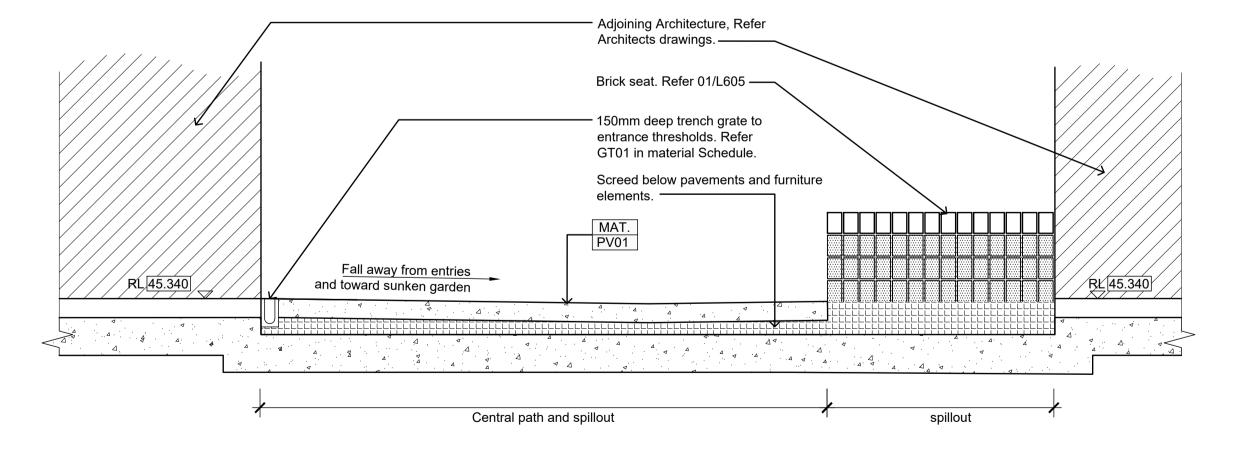

NOTES

03 Section


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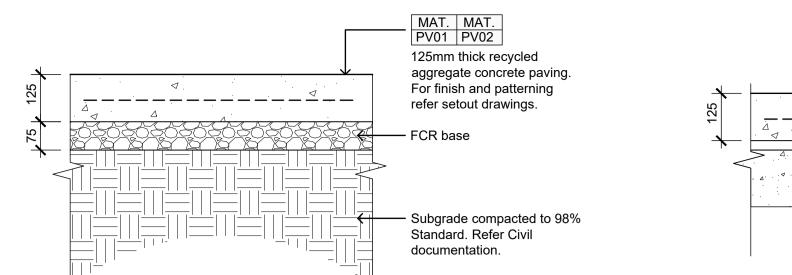
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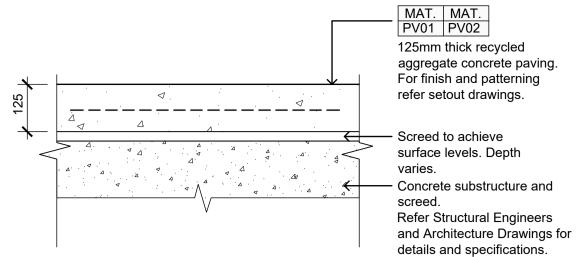
ADVERTISED PLAN

REV NO DATE DESCRIPTION	PROJECT INFORMATION	SHEET TITLE			
E1 05.08.24 FOR ENDORSEMENT	VICTORIA STREET DEVELOPMENT	SECTIONS - SOUTHERN LANEWAY			
	342-348 VICTORIA STREET				
	BRUNSWICK, VIC 3029				
		DRAWN BY	PLOT DATE	SCALE @ A1	NORTH
		AY	05.08.2024	1:20 @ A1	
	ISSUE	APPROVED	PROJECT NO	SHEET NO.	REV NO
	FOR ENDORSEMENT	ВВ	2302	L502	E1




NOTES REV NO DATE DESCRIPTION PROJECT INFORMATION **SECTIONS - NORTHERN LANEWAY** E1 05.08.24 FOR ENDORSEMENT **VICTORIA STREET DEVELOPMEN** mala 342-348 VICTORIA STREET BRUNSWICK, VIC 3029 DRAWN BY PLOT DATE SCALE @ A1 NORTH 1:20 @ A1 05.08.2024 ISSUE APPROVED PROJECT NO SHEET NO. **REV NO** L503 FOR ENDORSEMENT 2302 E1



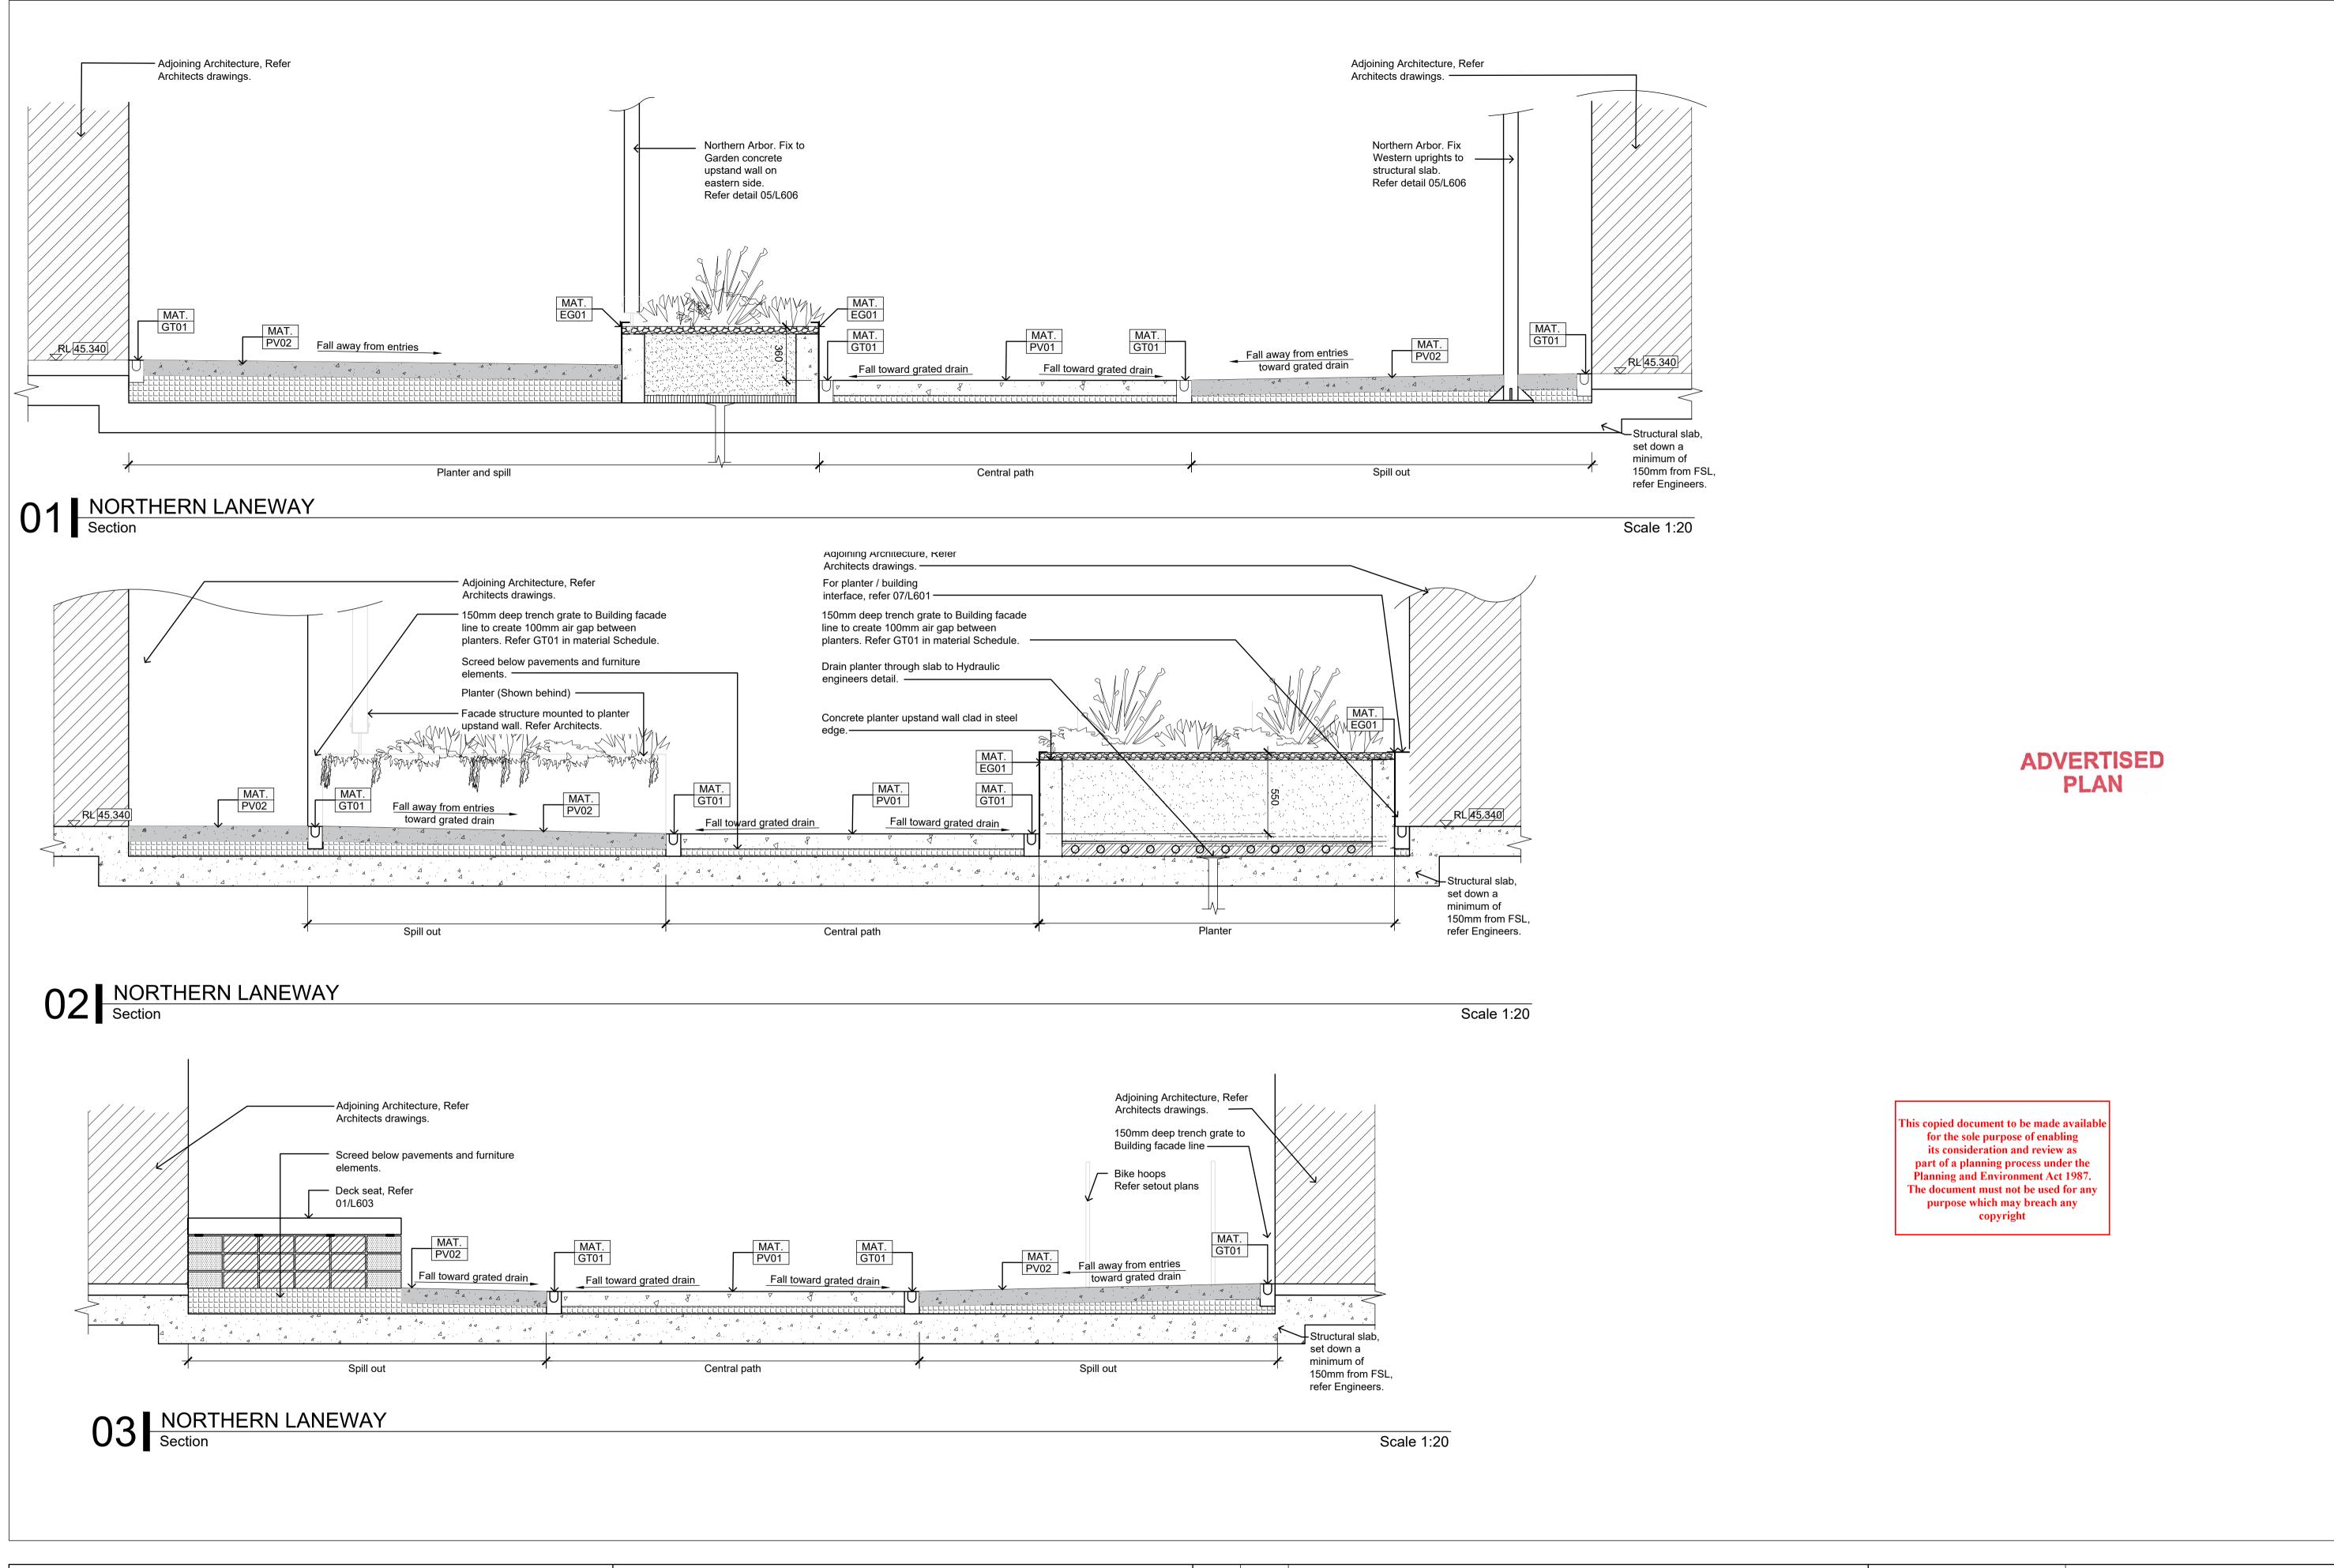


O1 PAVEMENTS PV01 & PV02 - ON DEEP SOIL
Section Scale 1:10

02 PAVEMENTS PV01 & PV02 - ON STRUCTURE
Section Scale 1:10

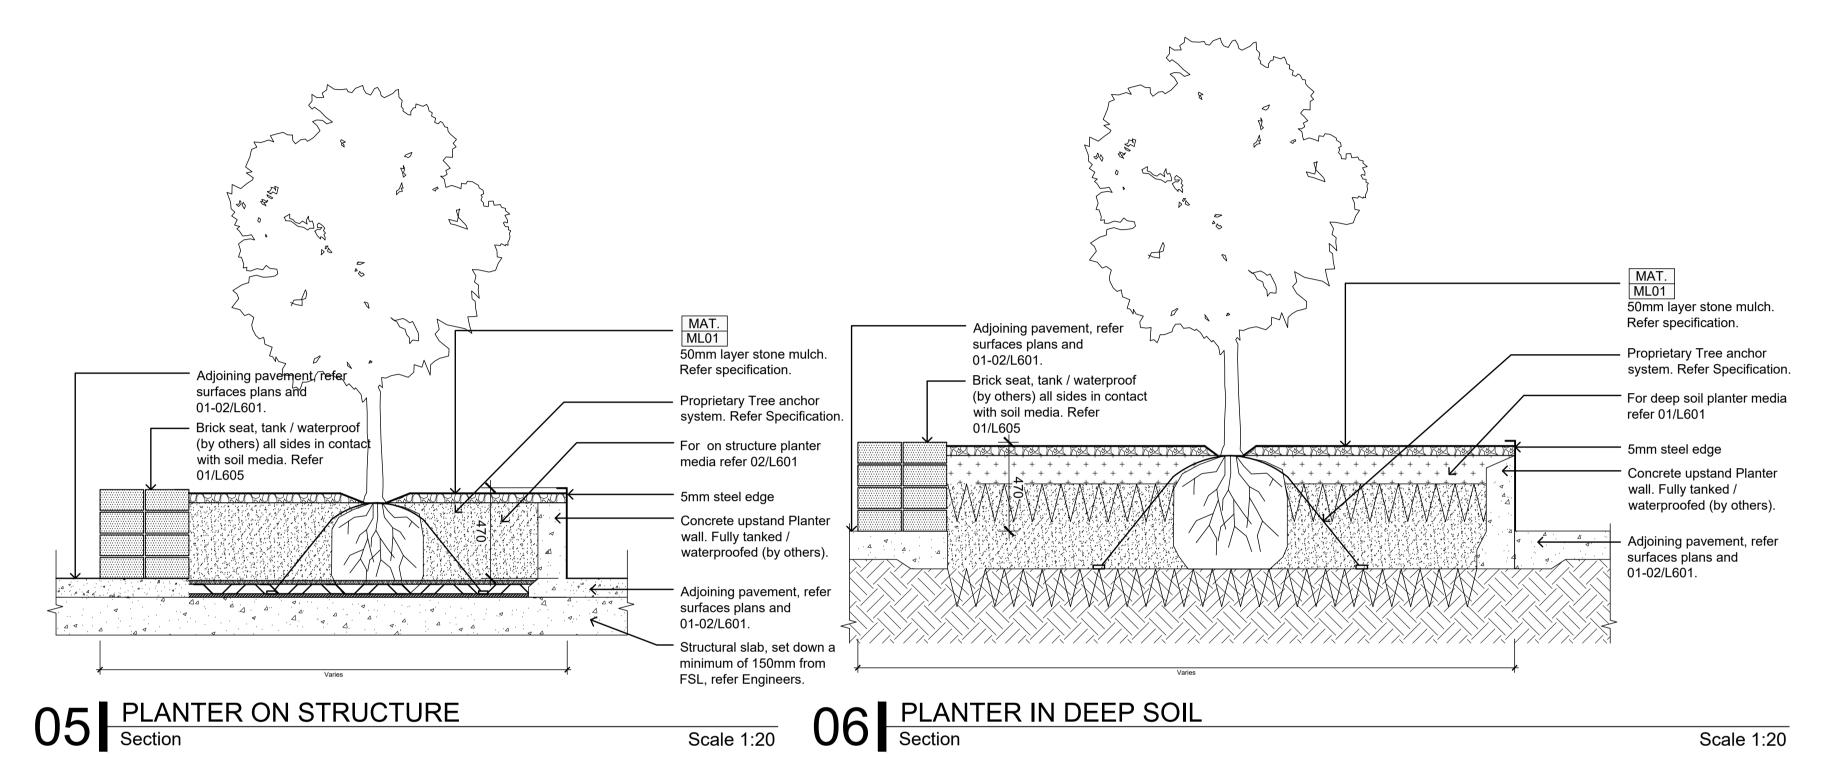

NOTES

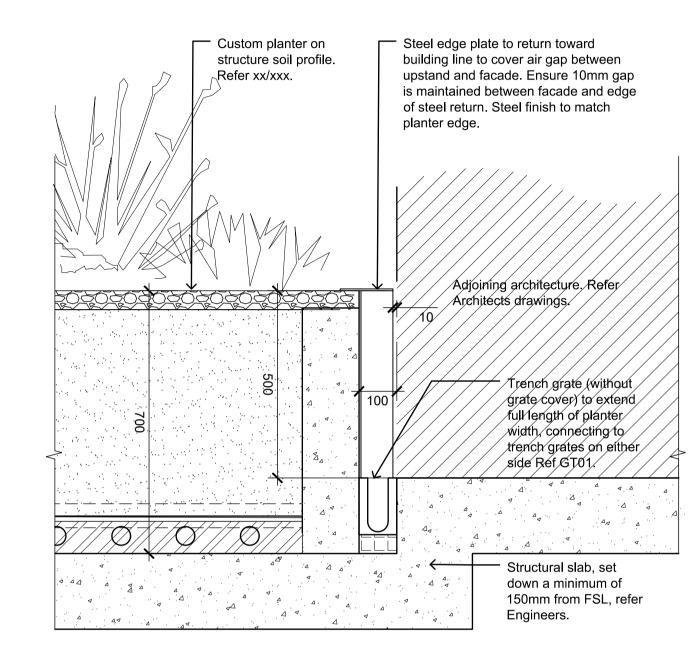



07 RAISED PLANTER / BUILDING INTERFACE
SECTION Scale

ADVERTISED PLAN

	8
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_				T			
REV NO	DATE	DESCRIPTION	PROJECT INFORMATION	SHEET TITLE			
E1	05.08.24	FOR ENDORSEMENT	VICTORIA STREET DEVELOPMENT	DETAILS	- HARD D	ETAILS	
			342-348 VICTORIA STREET				
			BRUNSWICK, VIC 3029				
				DRAWN BY	PLOT DATE	SCALE @ A1	NORTH
				AY	05.08.2024	1:10 @ A1	
			ISSUE	APPROVED	PROJECT NO	SHEET NO.	REV NO
			FOR ENDORSEMENT	ВВ	2302	L601	E1



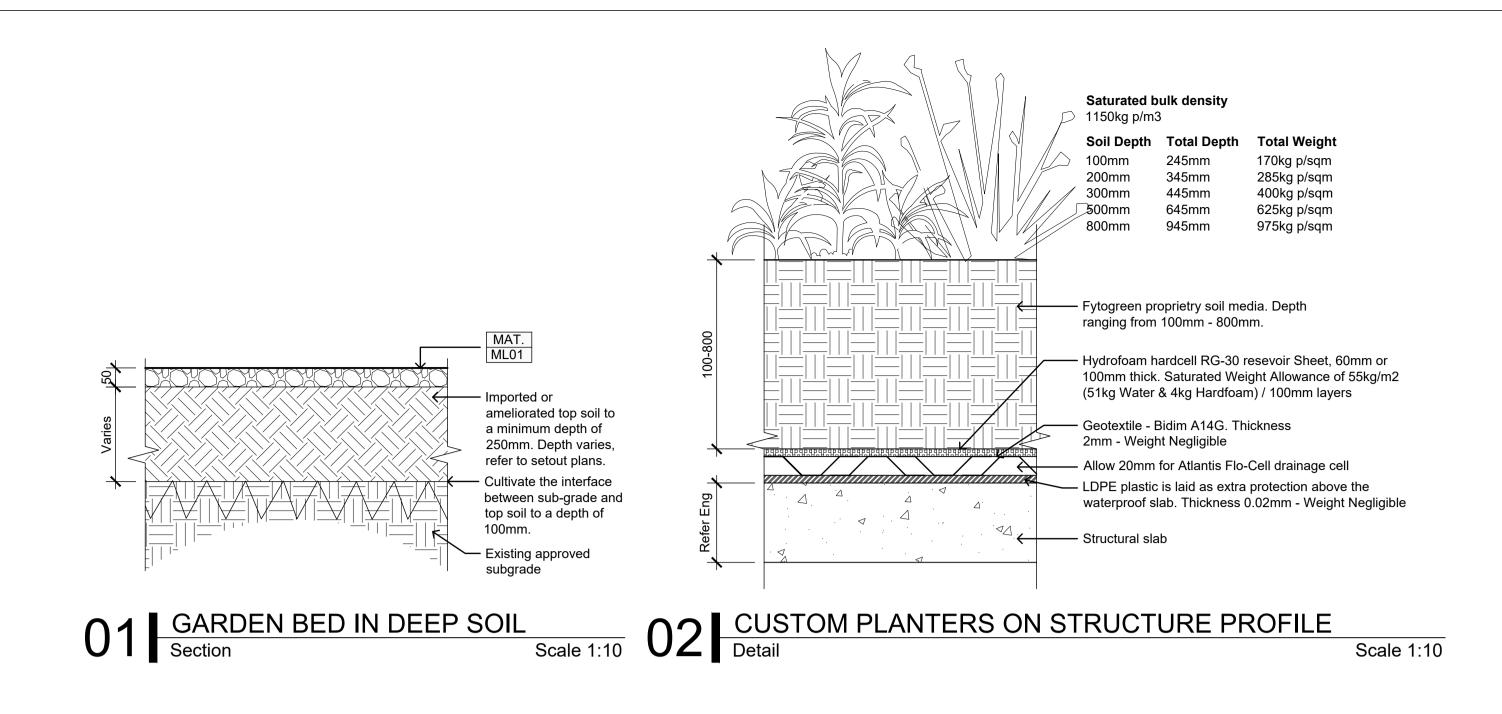
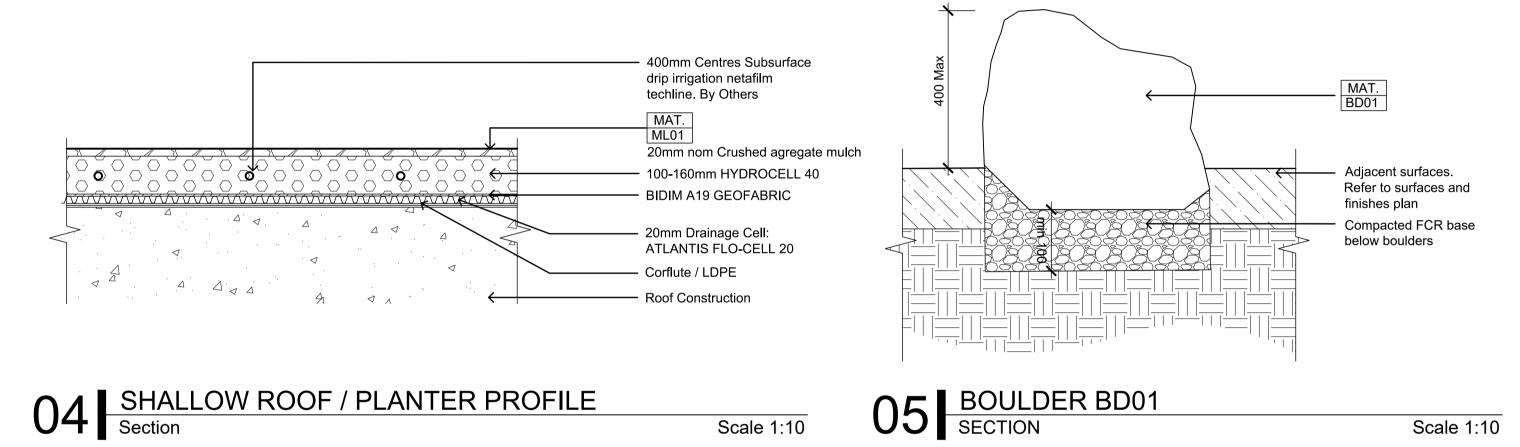
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20mm Mulch layer

Sheet, 30mm thick.

Hydraulic engineer.

← Structural slab

O3 GRC PLANTER PROFILE
Section

2mm - Weight Negligible

drawings.

- Proprietry GRC planter. refer Architects

- Fytogreen proprietry soil media. Depth

- Hydrofoam hardcell RG-30 resevoir

Geotextile - Bidim A34. Thickness

- Allow 20mm for Atlantis Flo-Cell drainage cell

Scale 1:10


Drain from planter outlet through slab. Refer


— Planter to be raised Min 10mm from slab.


ranging from 100mm - 800mm.

ADVERTISED PLAN


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	E1 05.08.24	E1 05.08.24	FOR ENDORSEMENT	VICTORIA STREET DEVELOPMENT	DETAILS	S - SOFT D	ETAILS	
				342-348 VICTORIA STREET				
				BRUNSWICK, VIC 3029				
					DRAWN BY	PLOT DATE	SCALE @ A1	NORTH
					AY	05.08.2024	1:10 @ A1	
				ISSUE	APPROVED	PROJECT NO	SHEET NO.	REV NO
			FOR ENDORSEMENT	ВВ	2302	L602	E1	

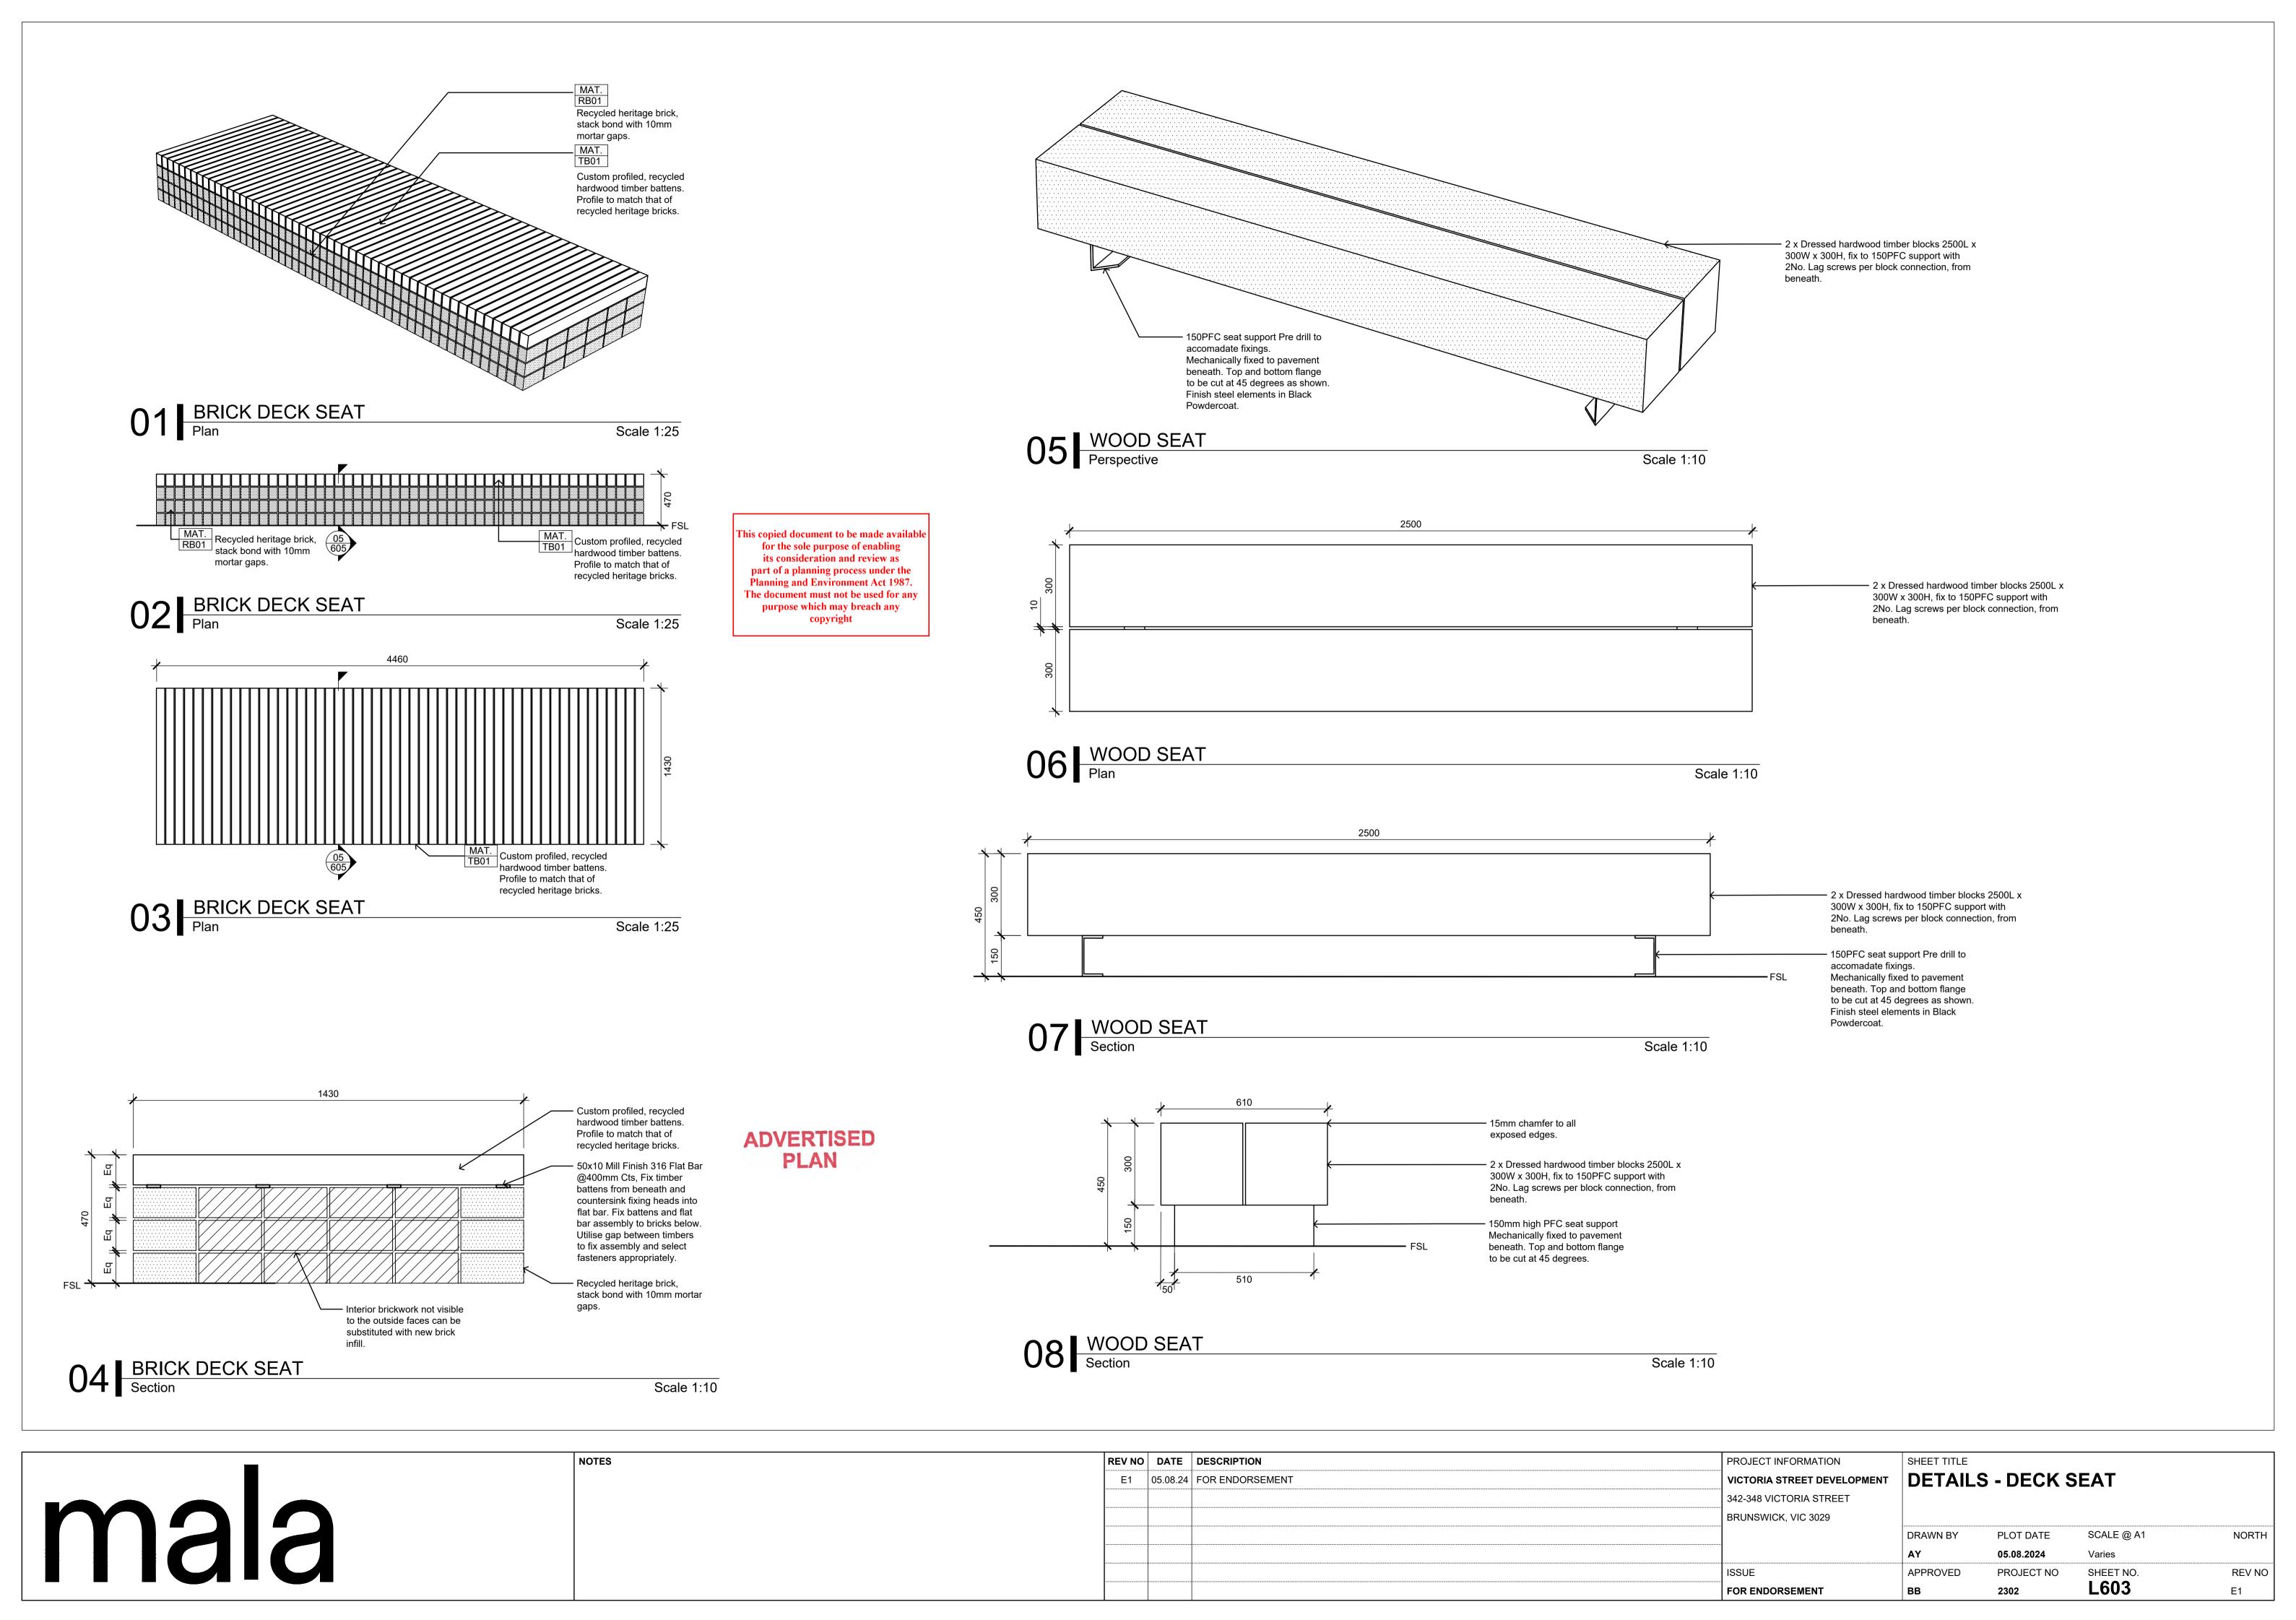

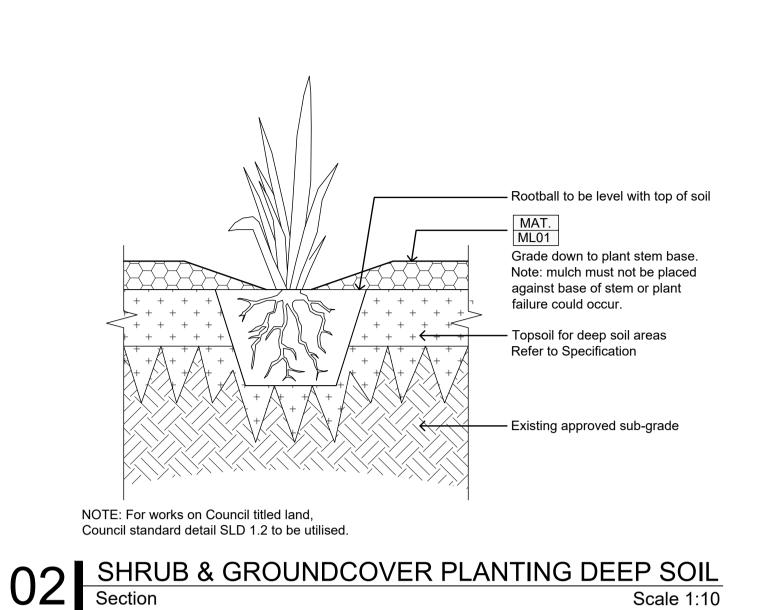

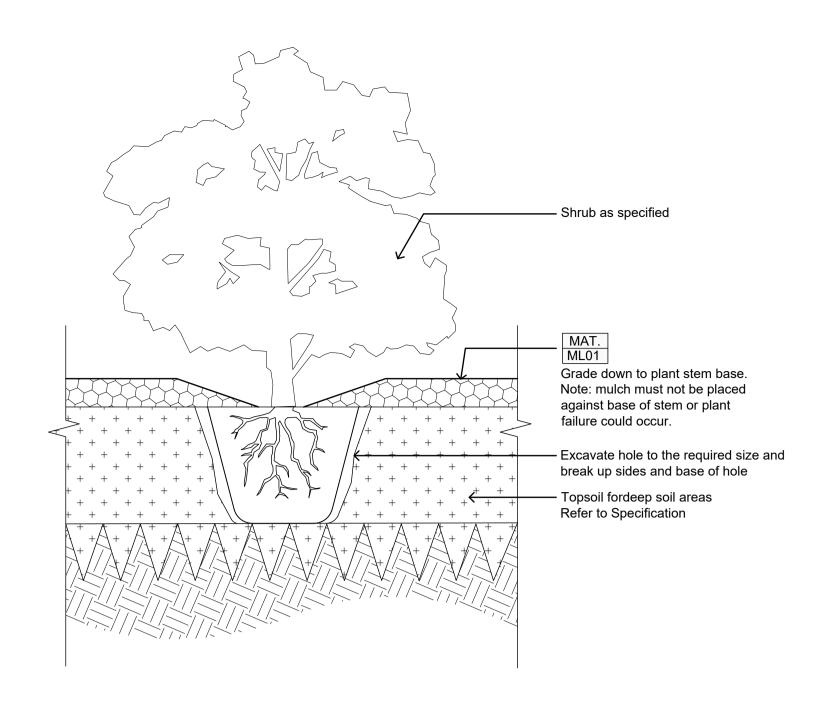

03 TYPICAL SHRUB PLANTING IN DEEP SOIL
Section Scale 1:10

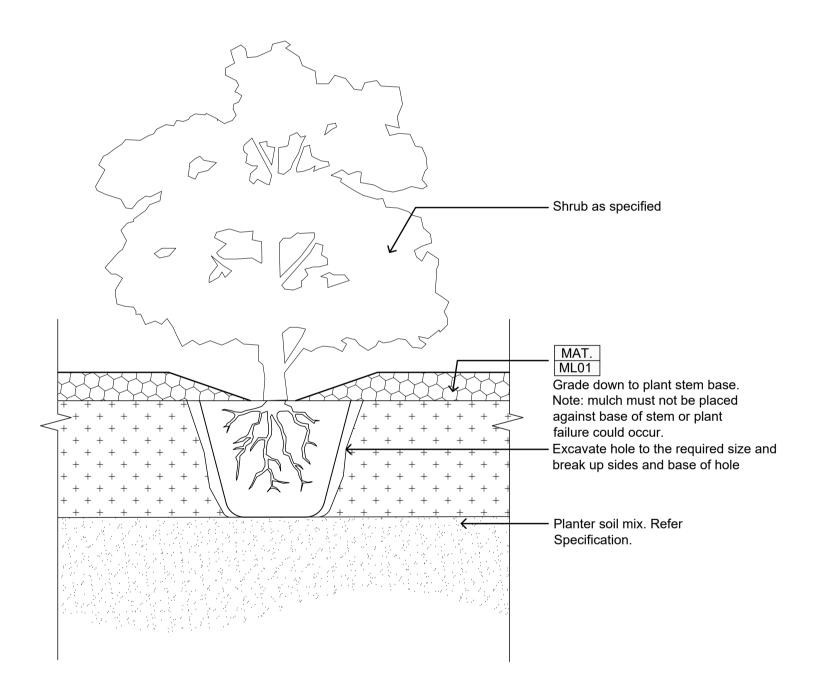

06 TYPICAL SHRUB PLANTING ON STRUCTURE
Scale 1:10

Rootball to be level with top of soil

MAT.
ML01

Grade down to plant stem base.
Note: mulch must not be placed against base of stem or plant failure could occur.

Planter soil mix. Refer Specification.


Planter soil mix. Refer Specification.

05 Section Scale 1:10

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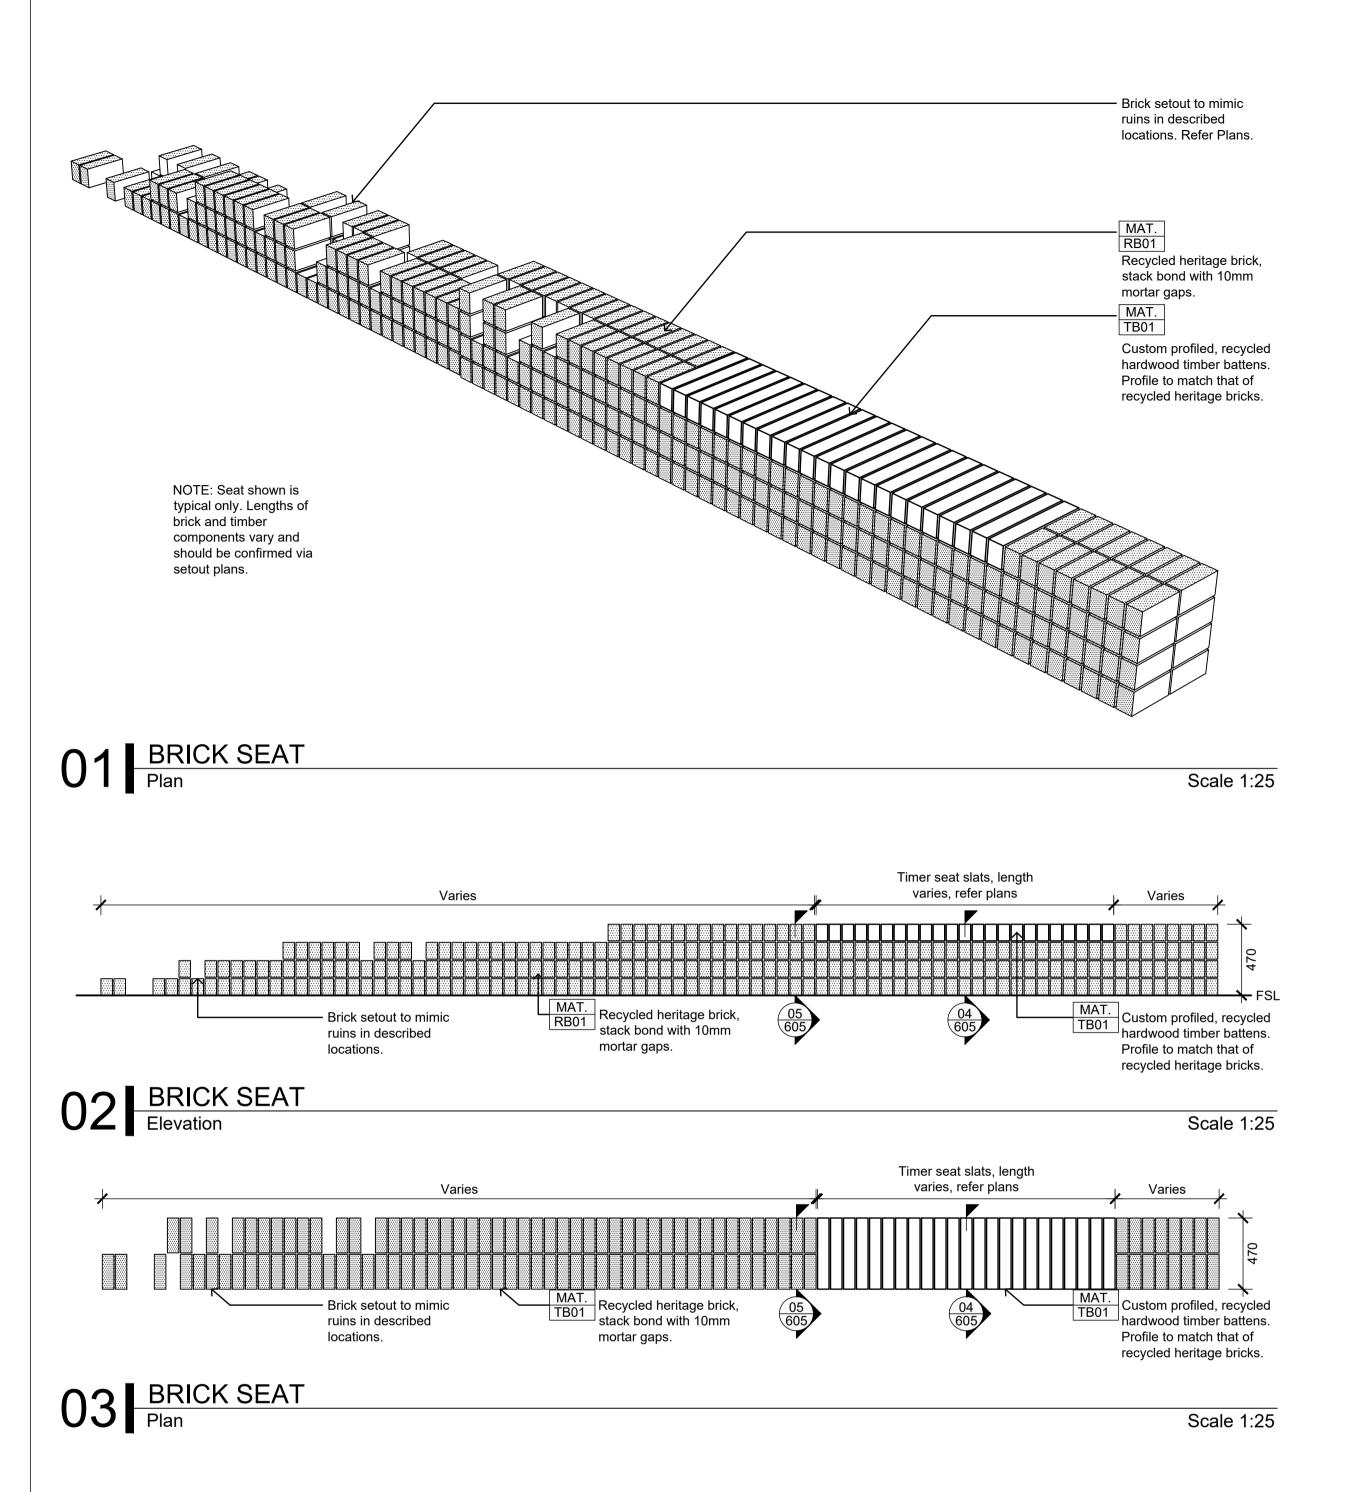
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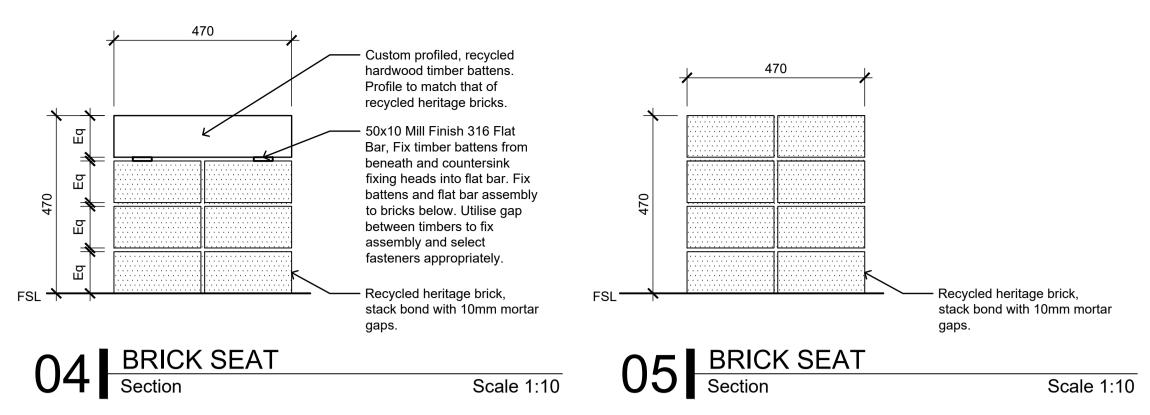
02 TREE PLANTING IN DEEP SOIL GARDEN
Scale 1:10

mala


SHEET TITLE REV NO DATE DESCRIPTION PROJECT INFORMATION **DETAILS - PLANTING** E1 05.08.24 FOR ENDORSEMENT **VICTORIA STREET DEVELOPMEN** 342-348 VICTORIA STREET BRUNSWICK, VIC 3029 DRAWN BY PLOT DATE SCALE @ A1 NORTH 05.08.2024 1:10@A1 ISSUE APPROVED PROJECT NO SHEET NO. **REV NO** L604 FOR ENDORSEMENT 2302 E1

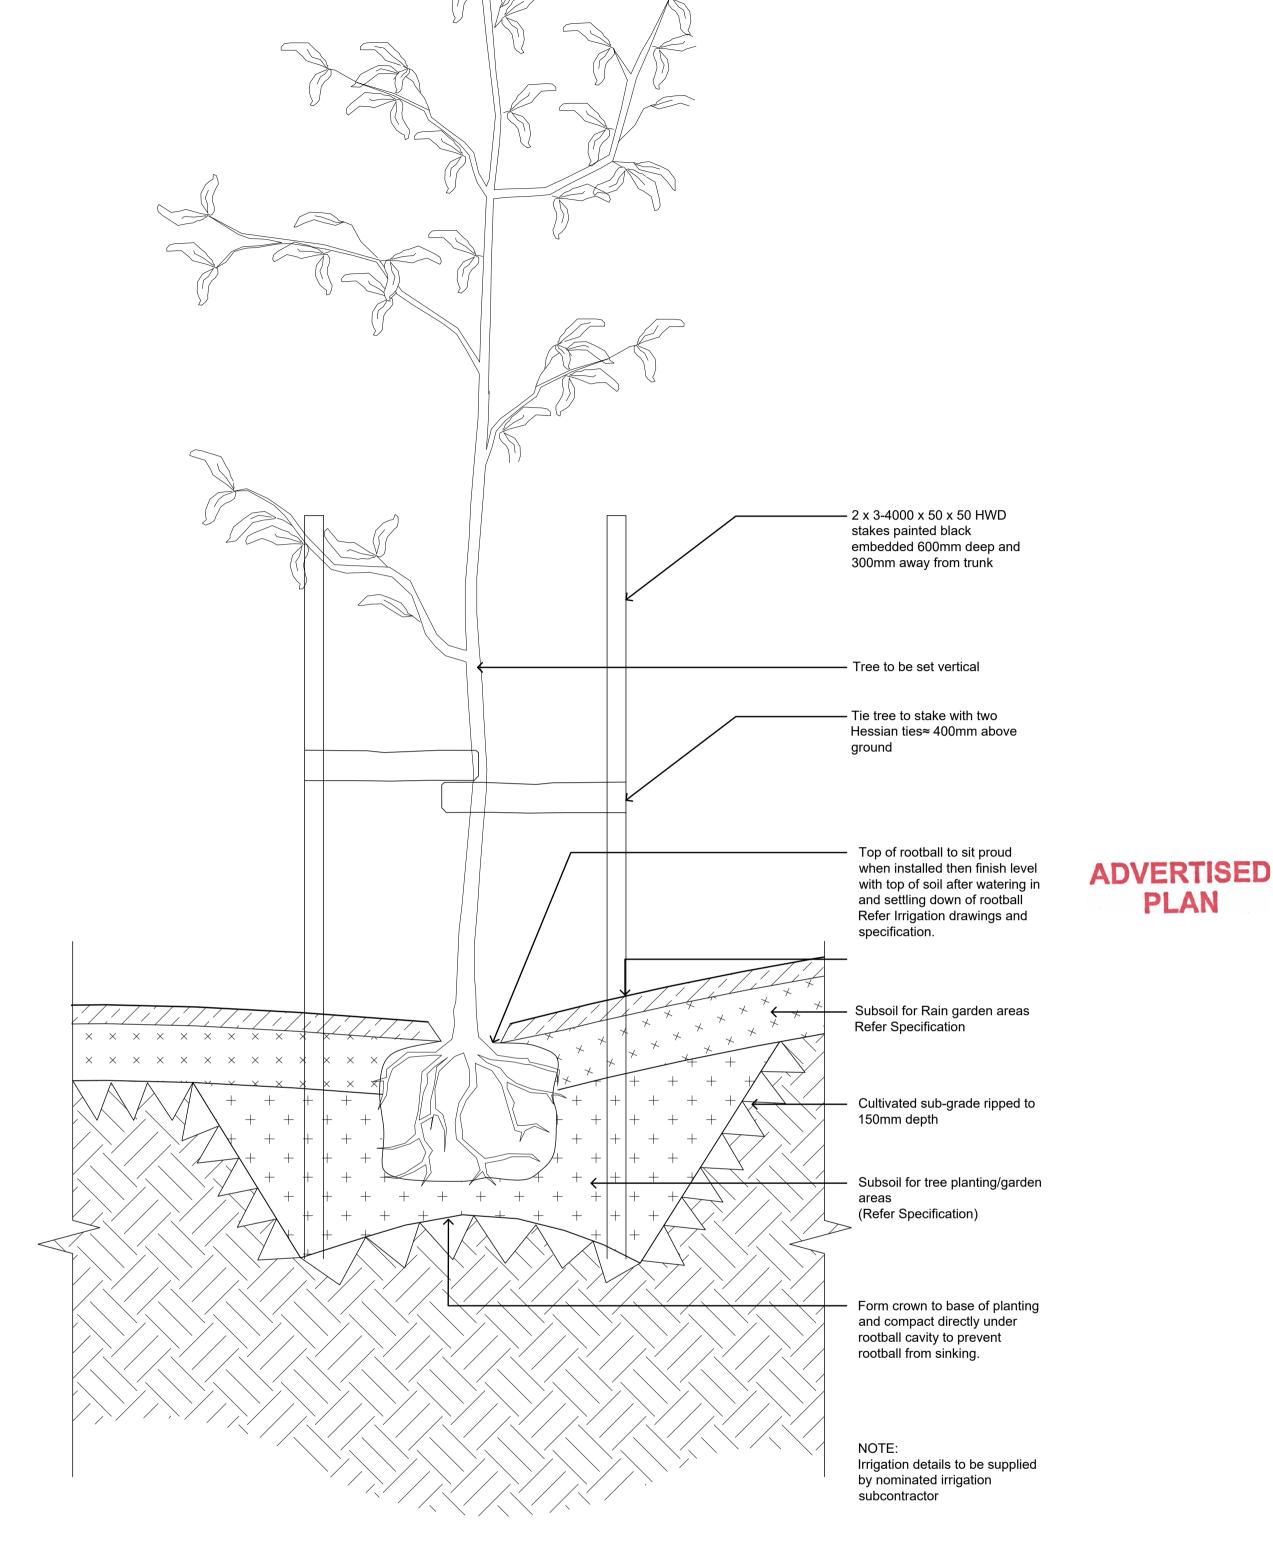



ADVERTISED PLAN





mala	NOTES	REV NO DATE DESCRIPTION	PROJECT INFORMATION	SHEET TITLE			
		E1 05.08.24 FOR ENDORSEMENT	VICTORIA STREET DEVELOPMENT	DETAILS	ETAILS - BRICK SEATS		
			342-348 VICTORIA STREET				
			BRUNSWICK, VIC 3029				
				DRAWN BY	PLOT DATE	SCALE @ A1	NORTH
				AY	05.08.2024	As Shown	
			ISSUE	APPROVED	PROJECT NO	SHEET NO.	REV NO
			FOR ENDORSEMENT	ВВ	2302	L614	E1

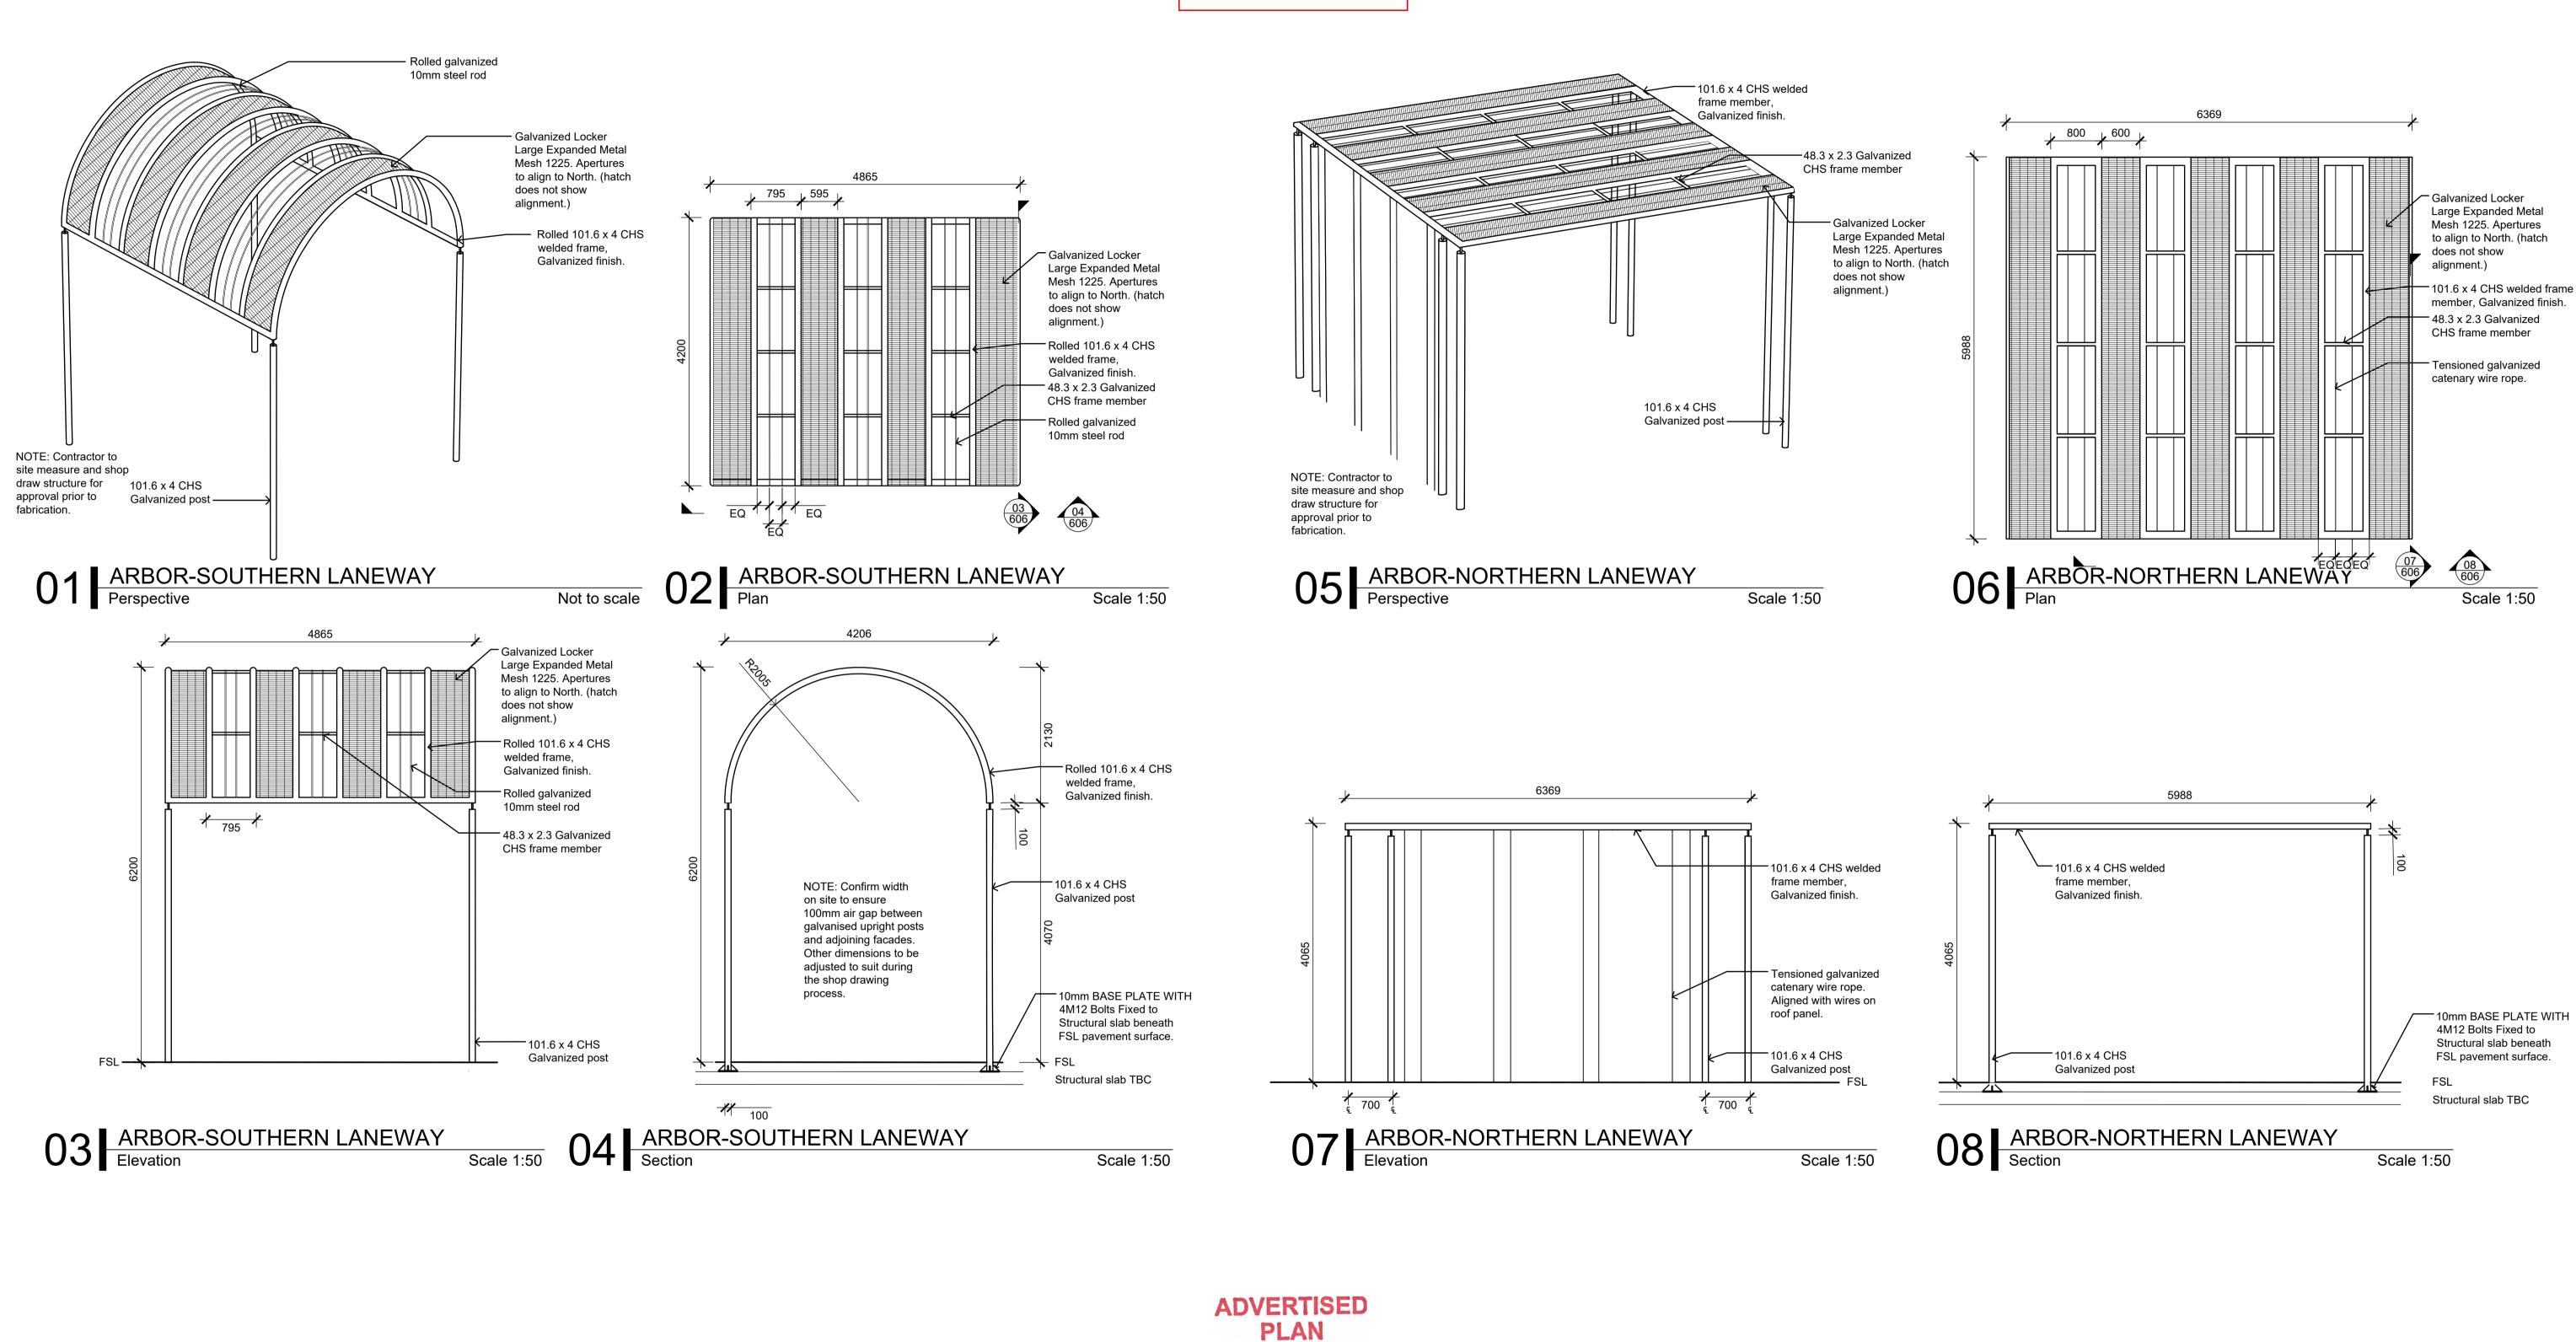


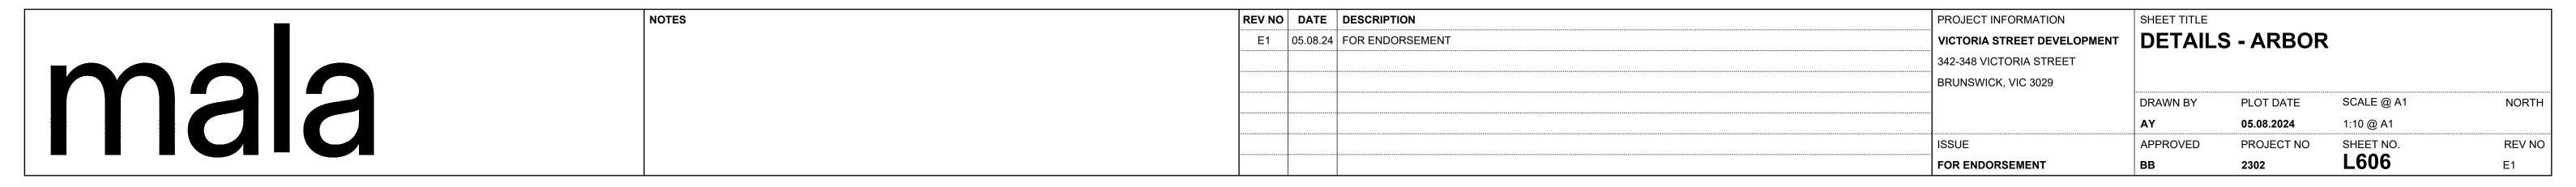

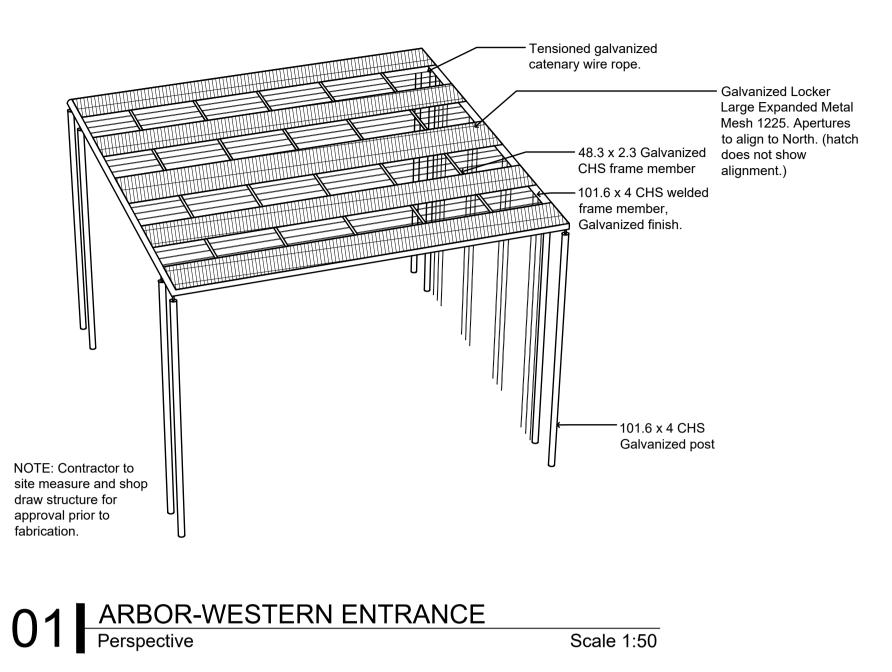

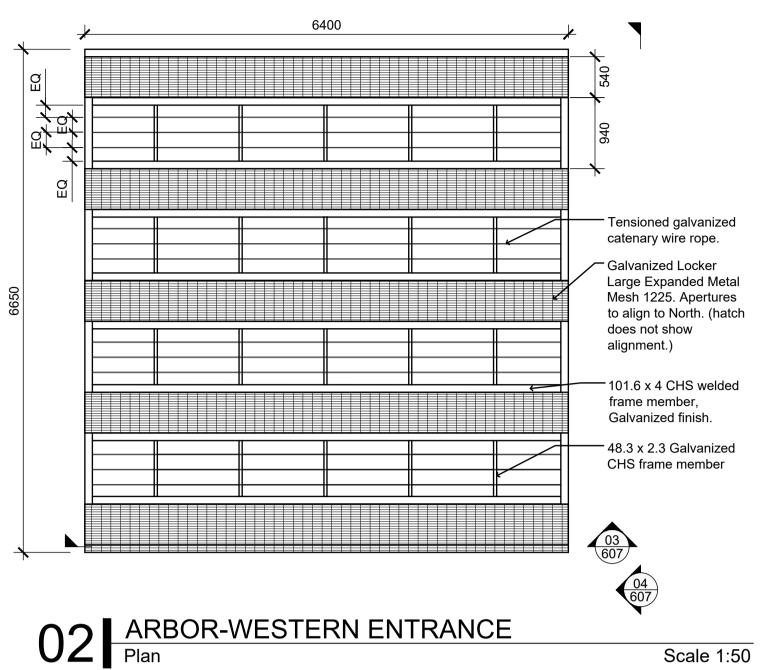

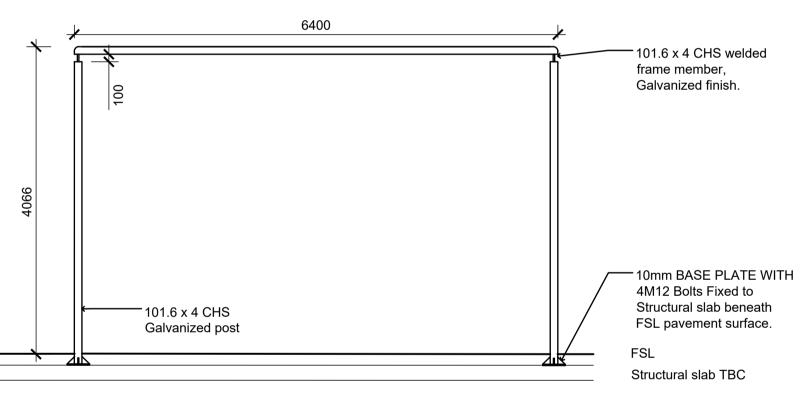

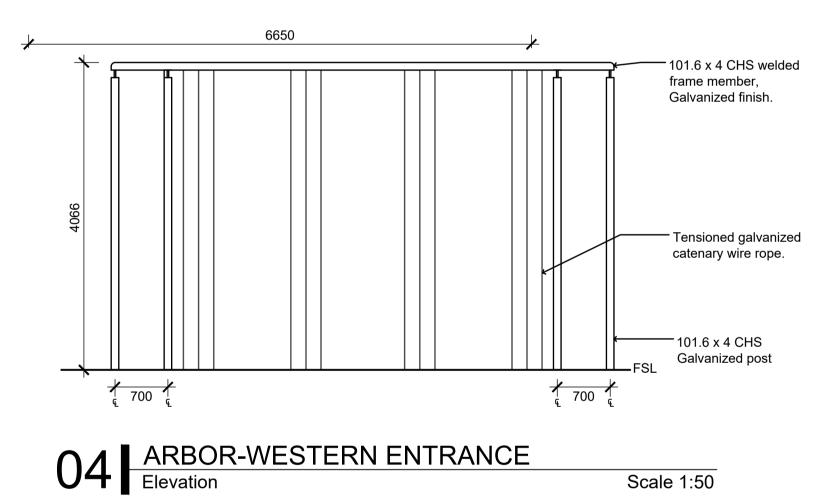

O3 ARBOR-WESTERN ENTRANCE
Section

Lievation

ADVERTISED PLAN

Scale 1:50

	NOTES	REV NO DATE DESCRIPTION E1 05.08.24 FOR ENDORSEMENT	PROJECT INFORMATION VICTORIA STREET DEVELOPMENT	SHEET TITLE DETAILS - ARBOR				
mala			342-348 VICTORIA STREET BRUNSWICK, VIC 3029					
				DRAWN BY	PLOT DATE 05.08.2024	SCALE @ A1 As Shown	NORTH	
			ISSUE FOR ENDORSEMENT	APPROVED BB	PROJECT NO 2302	SHEET NO. L607	REV NO E1	



PROJECT NO: 2302

VICTORIA ST BRUNSWICK

LANDSCAPE WORKS
MATERIAL AND ELEMENT SCHEDULE
L700

For Endorsement.
Not For Construction
August 2024



DOCUMENT HISTORY

Issue	Addendum	Revision	Date
For Endorsement		E1	05/08/2024

NOTES

a. This schedule shall be read in conjunction with the Drawings and Specification.



CONTENTS

٧	IATERIALS & ELEMENTS	4
	EDGING	4
	FURNITURE	4
	TIMBER	5
	RECYCLED BRICK	5
	DRAINAGE	6
	MULCH	6
	BOULDERS/NATURAL STONE	7
	PAVEMENTS	8



MATERIALS & ELEMENTS

EDGING

Code	EG-01	Rev	0		
Description	Steel Edging to Concrete Planter box walls				
Sample					
Material	Galvanised Steel				
Size	5.0mm thick, height varies				
Colour	Galvanised finish				
Finish	Galvanised finish				
Supplier	N/A				
Notes	a. All steel elements to be shop dra	awn ar	nd approved prior to fabrication.		
Details					

FURNITURE



Notes	Maintenance: Clean every 12 months
Details	Refer to Supplier and product sheets.

TIMBER

Code	TB-01	Rev	0		
Description	Timber Battens		-1	<u>I</u>	ı
Sample					
Material	Recycled Hardwood				
Size	Length varies, profile to match recycled brick profile. (size to be confirmed against sourced brick).				
Colour	Oiled natural finish.				
Supplier					
Notes					
Details					

RECYCLED BRICK

Code	RB-01 Rev 0					
Description	Recycled brick					
Sample		This copied document to be made available for the sole purpose of enabling its consideration and review as part of a planning process under the Planning and Environment Act 1987. The document must not be used for any purpose which may breach any copyright				
Material	Recycled heritage brick					
Size	As supplied					
Colour	Red brick					
Supplier						
Notes	Colour to match that of heritage chimney and concrete aggregate	Colour to match that of heritage chimney and concrete aggregate in PVO2				
Details						




DRAINAGE Rev Code GT-01 Description KlassikDrain Iron Galvanised InterceptFN02 Sample This copied document to be made available for the sole purpose of enabling its consideration and review as part of a planning process under the Planning and Environment Act 1987. The document must not be used for any purpose which may breach any copyright con Material Galvanised Iron Size 5.0mm thick, height varies Colour Galvanised finish Finish Galvanised finish

MULCH

Supplier

Notes Details ACO https://www.acodrain.com.au/

Refer to details xx/xxx

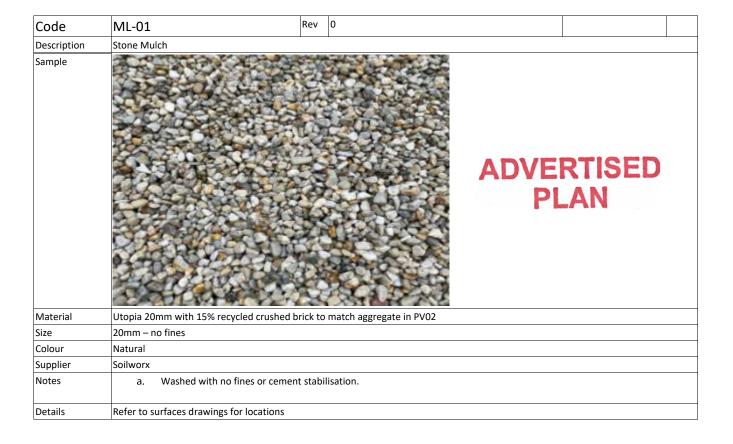

BOULDERS/NATURAL STONE

Code	BD-01	Rev 00			
Description	Large Rock Boulders				
Sample		This copied document to be made availal for the sole purpose of enabling its consideration and review as part of a planning process under the Planning and Environment Act 1987. The document must not be used for any purpose which may breach any copyright			
Material	Basalt				
Size	Varies, nom. H 300-1000				
Colour	Natural				
Finish	Natural				
Supplier	locally sourced rock.				
Notes	a. To be installed/embedded seb. Refer to Engineer for sub-basc. All exposed, sharp edges to b	se/footing detail			
Details					


Code	BD-02	Rev	00			
Description	Bluestone stepp	Bluestone steppers				
Sample						
Material	Basalt					
Size	Varies, nom. 30	Varies, nom. 30mmTHK, minimum diameter 400mm, maximum diameter 700mm.				
Colour	Natural					
Finish	Flame finished					
Supplier	Canterbury Stor	Canterbury Stone, https://www.canterburystone.com.au/bluestone-steppers-melbourne/				
Notes	a. To b					
	b. Layo	ut to be approved by Landscape	Architect prior to final installation			
Details				·		



PAVEMENTS

Code	PV01				
Description	Mentone pre-mix – Home tech external				
Sample	This copied document to be made available for the sole purpose of enabling its consideration and review as part of a planning process under the Planning and Environment Act 1987. The document must not be used for any purpose which may breach any copyright				
Material	In situ concrete				
Size	n/a				
Colour	Home tech external				
Finish	Medium sandblast				
Supplier	Mentone pre-mix				
Notes	a. Samples of concrete with sandblast finish to be provided and approved prior to installation.b. Concrete to be min 100mm thk and include reenforcing as per engineers specifications.				
Details	Refer to detail 01, 02/L601				

ADVERTISED PLAN

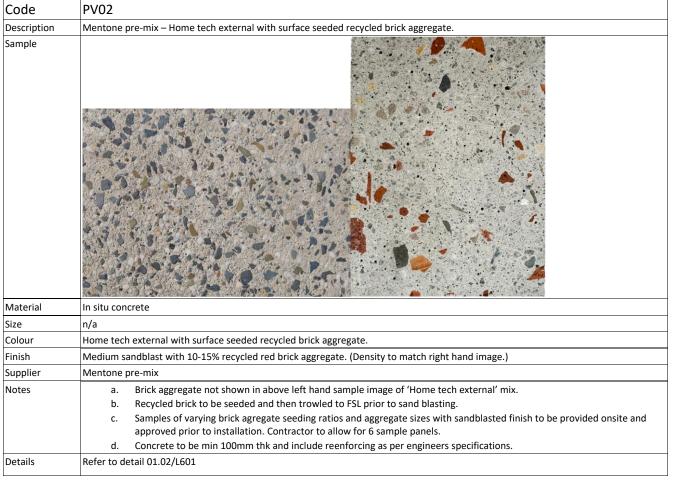

-COMMUNAL LEVEL IRRIGATION SUPPLY TO BE TAKEN FROM EACH RESPECTIVE BUILDING RAINWATER REUSE SERVICE USED FOR WC FLUSHING, TO BE PROVIDED BY HYDRAULICS. THE PLUMBING CONTRACTOR SHALL PROVIDE THE 25MM ISOLATION VALVE AT THESE LOCATIONS. **BUILDING 2** ROOF -19 BUILDING 4 LEVEL 10 — **BUILDING 1** LEVEL 09 -LEVEL 08 -**BUILDING 3** LEVEL 07 — LEVEL 06 — LEVEL 05 — LEVEL 04 — LEVEL 03 — LEVEL 02 —— 9 10 13 14 LEVEL 01 — GROUND FLOOR -HYDRAULICS SCOPE OF WORKS (TYPICAL) - PIPEWORKS **MVFS W**FS AND CIVIL PENETRATIONS WITH IN THE BUILDINGS. BASEMENT 01 — - IRRIGATION SCOPE - IRRIGATION SCOPE OF WORKS (TYPICAL). OF WORKS (TYPICAL). PRESSURE ZONE 1 PRESSURE ZONE 2 -(PROVIDED BY HYDRAULICS). (PROVIDED BY HYDRAULICS). IRRIGATION SUPPLY FROM BUILDING **IRRIGATION SUPPLY FROM BUILDING 1** 3 & 4 "DIRTY" RAINWATER TANK. & 2 "DIRTY" RAINWATER TANK.

IRRIGATION SCHEDULE

SYMBOL

MANUFACTURER/MODEL/DESCRIPTION

RAIN BIRD 100-PEB 25MM 25MM SOLENOID VALVE.

INSTALLED IN ACCESS SHAFT OF EACH BUILDING IN A CUPBOARD OF EACH LEVEL AS SHOWN ON THE SCHEMATIC.

RAIN BIRD PEB MASTER VALVE 40MM 40 MM MASTER VALVE ASSEMBLY.

FS

CREATIVE SENSOR TECHNOLOGY ELF-T10-N02 ENHANCED LOW FLOW SENSOR WITH 2-WIRE FREQUENCY, 25MM MALE BSP THREADED CONNECTION, FLOW RANGE

BETWEEN .76 LPM-76 LPM.

ADVERTISED PLAN

HYDRAULICS SCOPE OF WORKS:-

- THE ACTUAL DESIGN AND ROUTING OF THE LATERAL PIPING WITHIN THE BUILDING SHALL BE COMPLETED BY HYDRAULIC CONSULTANT & INSTALLED BY THE PLUMBING CONTRACTOR.
- THE PROVISIONS WITHIN EACH PLANTER SHALL HAVE AN AT LEAST APPROPRIATE SIZED ISOLATION VALVE (PROVIDED BY HYDRAULICS) FOR THE IRRIGATION CONTRACTOR TO COMMENCE IRRIGATION WORKS.
- ALL PIPING THROUGH BUILDING TO EXTERIOR AND THROUGH BUILDING TO UPPER FLOORS VIA CIVIL PENETRATIONS SHALL BE PROVIDED BY THE HYDRAULICS.
- ALL IRRIGATION CABLE INCLUDING ELECTRICAL CONDUIT FROM THE CONTROLLER LOCATION TO THE INDIVIDUAL VALVES ALONG THE IRRIGATION MAINLINE ROUTE.
- FINAL LOCATIONS TBC BY HYDRAULIC CONTRACTOR.
- 250KPA IS THE PRESSURE REQUIREMENTS AT EACH ISOLATION VALVE AT EACH LEVEL FOR THE IRRIGATION ZONES.
- THE IRRIGATION FLOW RATES REQUIRED AS PER THE VALVE SCHEDULE.

IRRIGATION SCOPE OF WORKS:-

- MASTER VALVE & FLOW SENSOR ASSEMBLY IN THE PLANT ROOMS OF BUILDING 3&4 AND BUILDING 1&2 FOR GROUND FLOOR & LEVEL 01.
- SOLENOID VALVES INSTALLED IN THE PROVIDED SERVICES CUPBOARD.
- DOWNSTREAM OF ISOLATION VALVES WITHIN THE SOFT LANDSCAPE. IRRIGATION CONTROLLERS WITHIN THE PLANT ROOMS/SERVICES CUPBOARD & ON COMMUNAL LEVELS.

THESE DRAWINGS ARE TO BE READ IN CONJUNCTION WITH ALL LANDSCAPE PLANS AND TECHNICAL SPECIFICATION AND OTHER CONSULTANTS DRAWINGS. CHECK AND VERIFY ALL DIMENSIONS AND SITE OF ANY DISCREPANCIES FOR CLARIFICATIONS BEFORE PROCEEDING. UNLESS NOTED OTHERWISE THIS DRAWING IS NOT FOR CONSTRUCTION. THIS DRAWING REMAINS THE PROPERTY OF SMART WATER CORPORATION P/L AND MUST NOT BE COPIED WITHOUT PRIOR CONSENT.

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ISSUE DATE **AMENDMENT** VB BD P1 06.02.24 PRELIMINARY ISSUE CONDITIONS PRIOR TO COMMENCEMENT OF ANY WORKS. DO NOT SCALE | P2 | 14.02.24 | PRELIMINARY ISSUE UPDATED VB BD VB BD T1 | 14.03.24 | TENDER ISSUE VB BD T2 24.05.24 TENDER ISSUE UPDATED T3 11.07.24 TENDER ISSUE UPDATED VB BD THE LOCATION OF THE UNDERGROUND T4 08.08.24 TENDER ISSUE UPDATED VB BD SERVICES ARE SHOWN AS A GUIDE ONLY. THE EXACT LOCATION OF YOU DIG ONLY. THE EXACT LOCATION OF SERVICES SHOULD BE PROVEN ON SITE www.byda.com.au

BEFORE EXCAVATION AND DRILLING
PRIOR TO THE COMMENCEMENT WORK.





U3, 23A COOK ROAD, MITCHAM, VIC 3132

P: 03 9754 0900

VICTORIA STREET DEVELOPMENT

PROJECT ADDRESS 342-348 VICTORIA STREET, BRUNSWICK VIC 3056

ASSEMBLE LANDSCAPE ARCHITECT

LEVEL 1/11 AMSTERDAM STREET,

MALA STUDIO


RICHMOND, VIC 3121


DRAWING TITLE **TENDER ISSUE** IRRIGATION SCHEMATIC PLAN DRAWING SCALE BAR JOB NO. SHEET SIZE Α1 3344

DRAWING NO.

3344-VSB-SCH-SW-IR-01

ISSUE

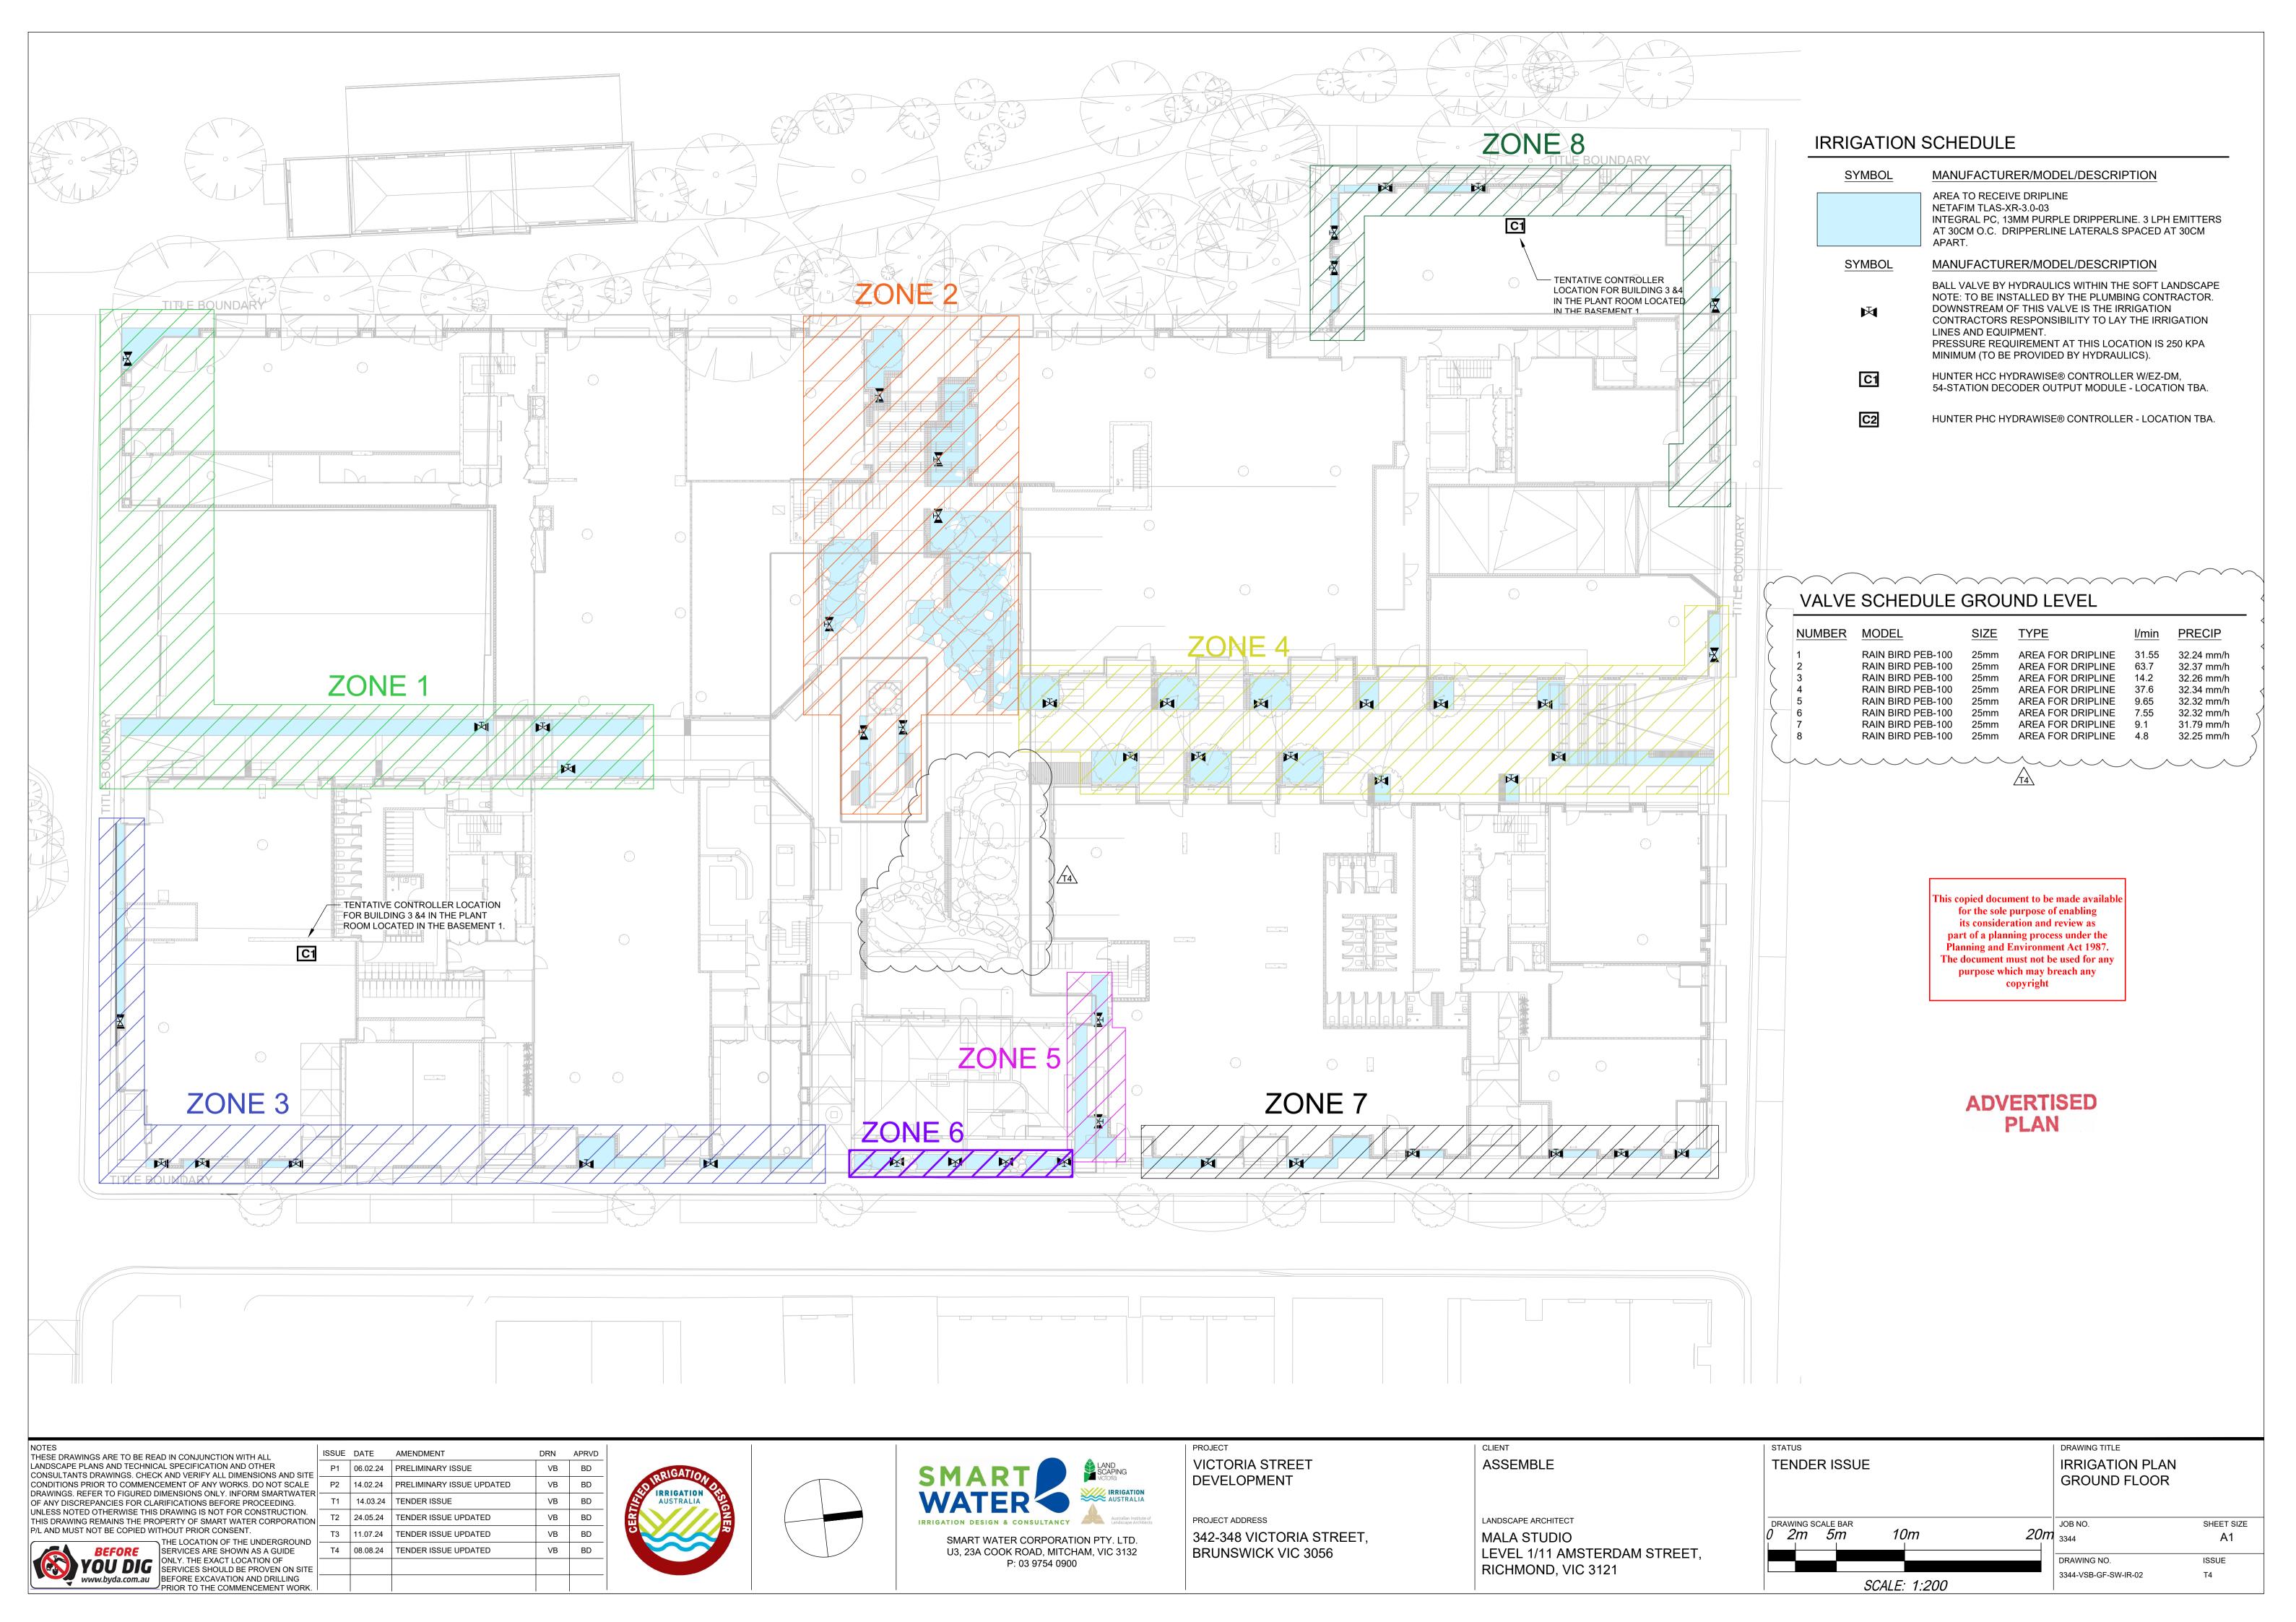

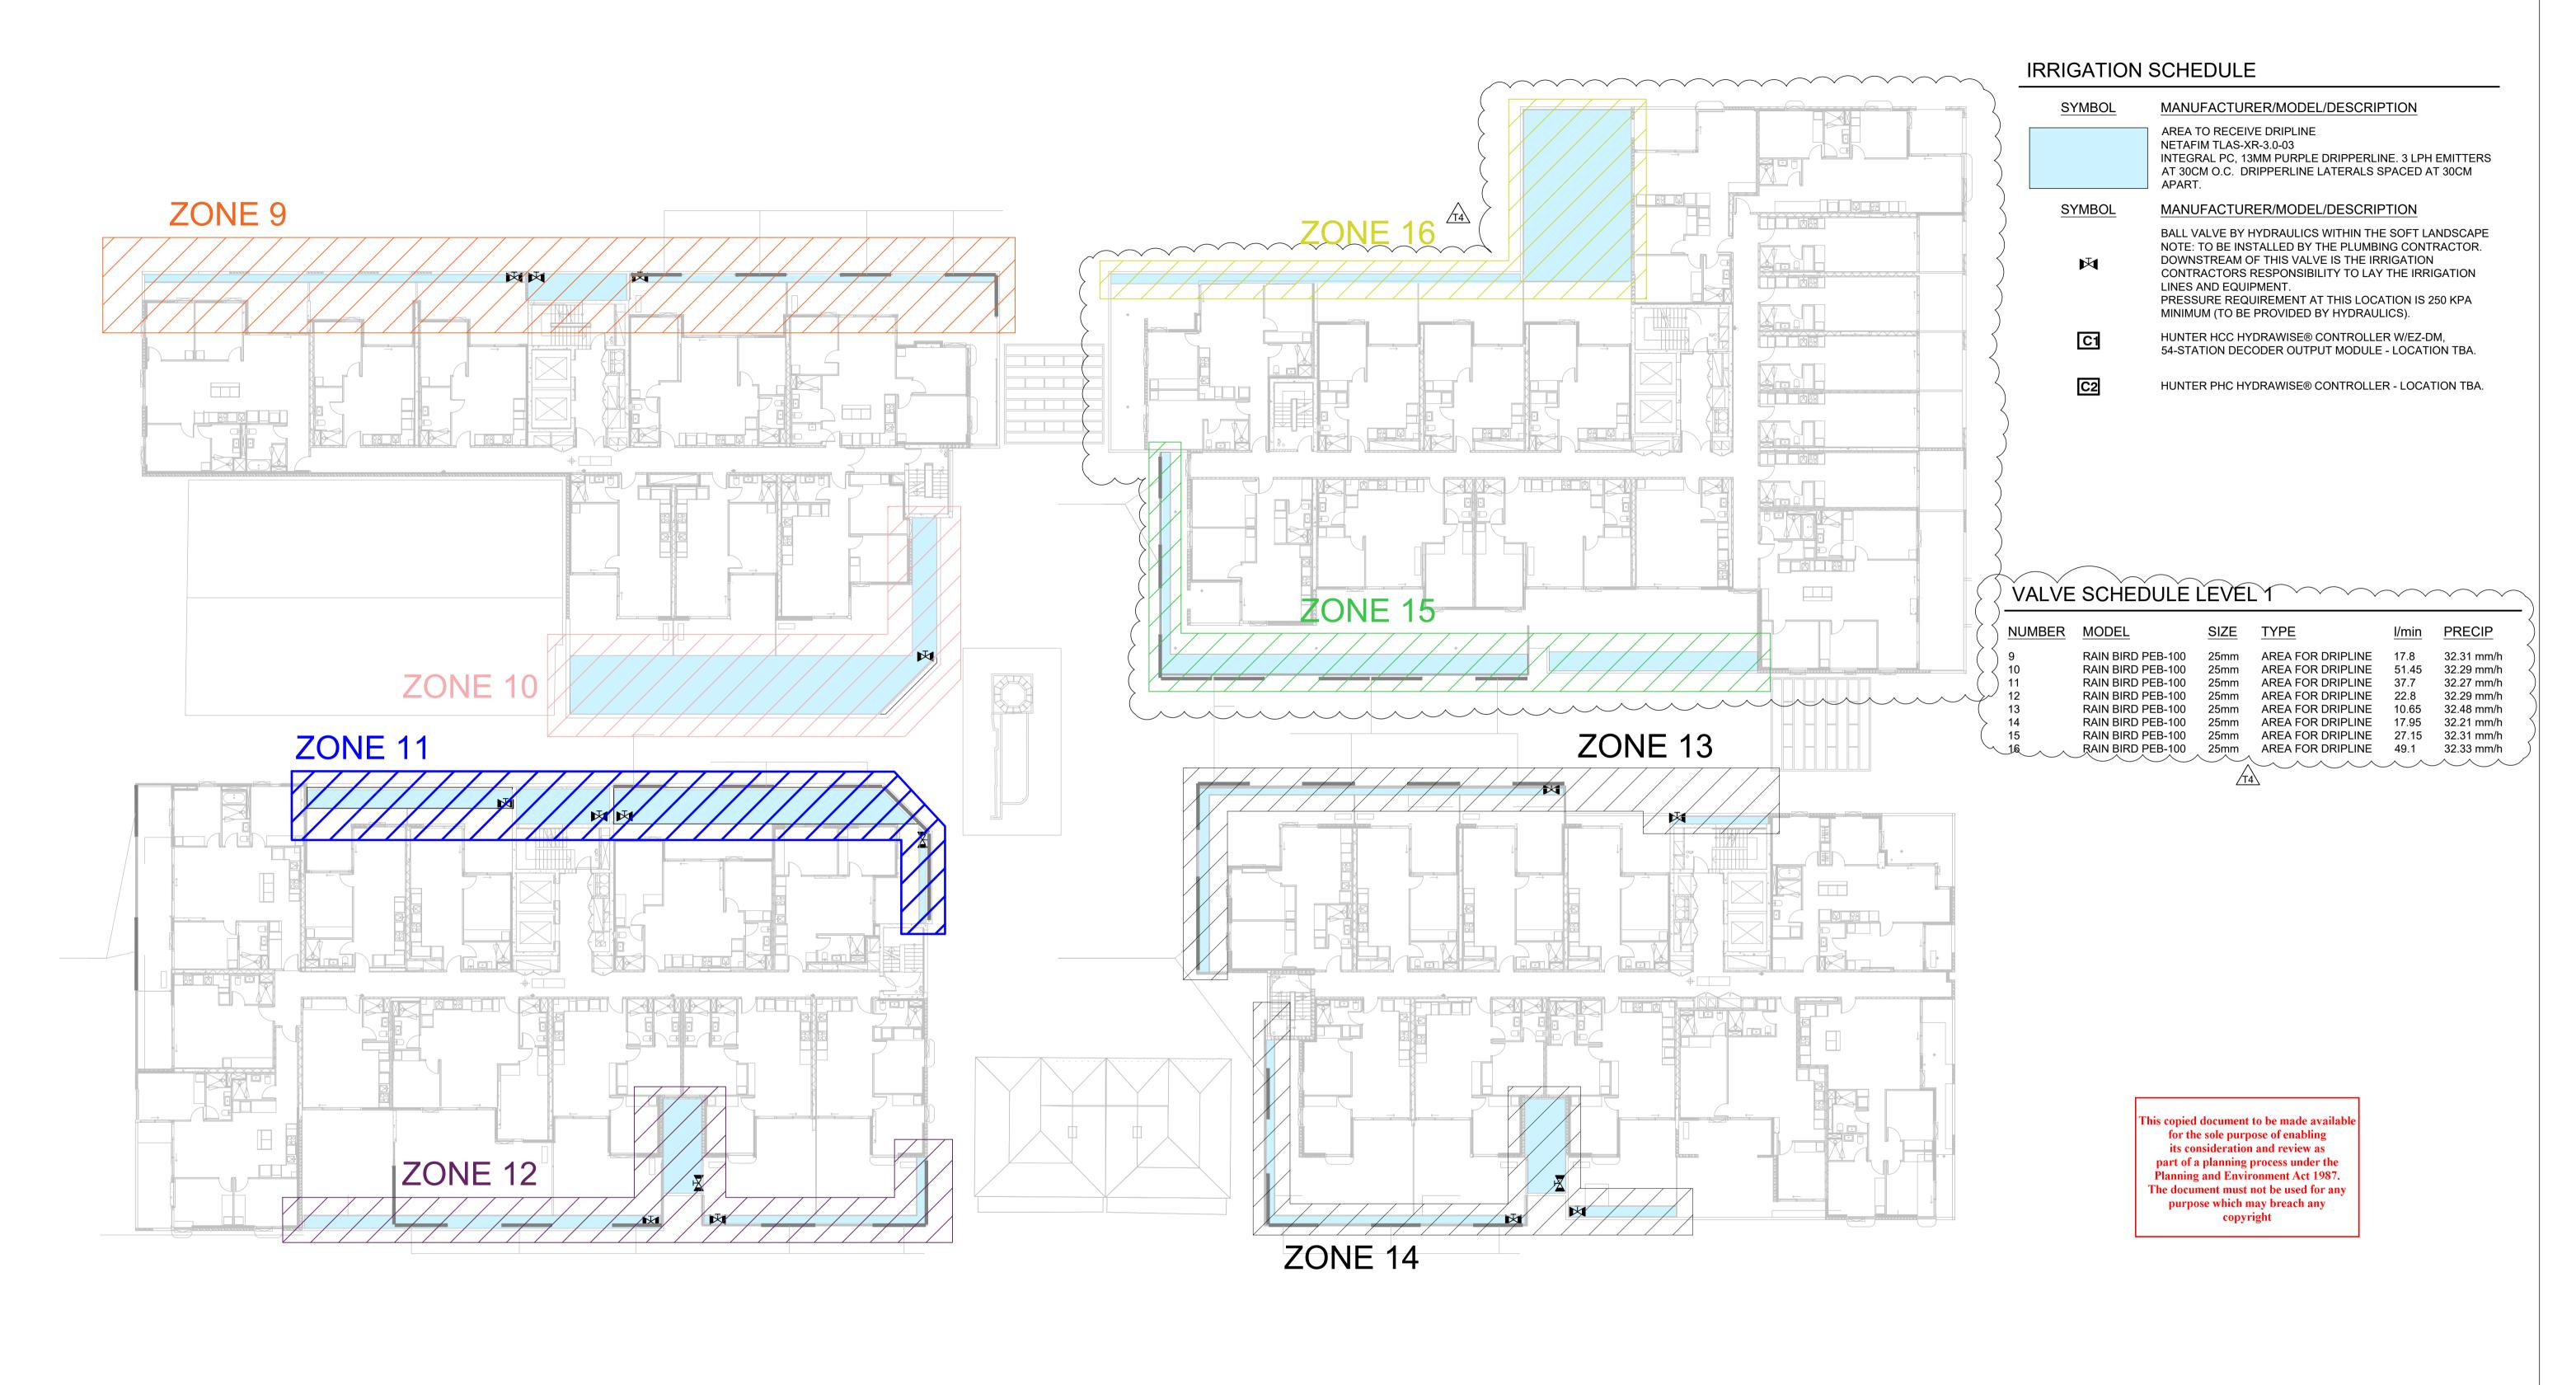

ADVERTISED PLAN

NOTES
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ISSUE DATE AMENDMENT


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P2 14.02.24 PRELIMINARY ISSUE UPDATED

T1 14.03.24 TENDER ISSUE UPDATED


T3 11.07.24 TENDER ISSUE UPDATED

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AND MUST NOT BE COPIED WITHOUT PRIOR CONSENT.

THE LOCATION OF THE UNDERGROUND SERVICES ARE SHOWN AS A GUIDE ONLY. THE EXACT LOCATION OF SERVICES SHOULD BE PROVEN ON SITE BEFORE EXCAVATION AND DRILLING PRIOR TO THE COMMENCEMENT WORK.

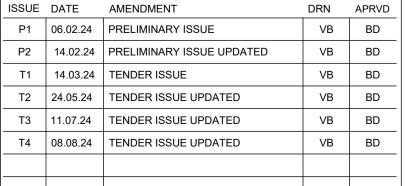



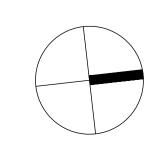



U3, 23A COOK ROAD, MITCHAM, VIC 3132

P: 03 9754 0900

VICTORIA STREET DEVELOPMENT

PROJECT ADDRESS

342-348 VICTORIA STREET,
BRUNSWICK VIC 3056

CLIENT
ASSEMBLE
LANDSCAPE ARCHITECT
MALA STUDIO


LEVEL 1/11 AMSTERDAM STREET,


RICHMOND, VIC 3121


STATUS	DRAWING TITLE	
TENDER ISSUE	IRRIGATION PLAN LEVEL 01	
DRAWING SCALE BAR 0 2m 5m 10m 20r	JOB NO. 3344	SHEET SIZE A1
	DRAWING NO.	ISSUE
SCALE: 1:200	3344-VSB-L01-SW-IR-03	T4

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IRRIGATION SCHEDULE

SYMBOL MANUFACTURER/MODEL/DESCRIPTION

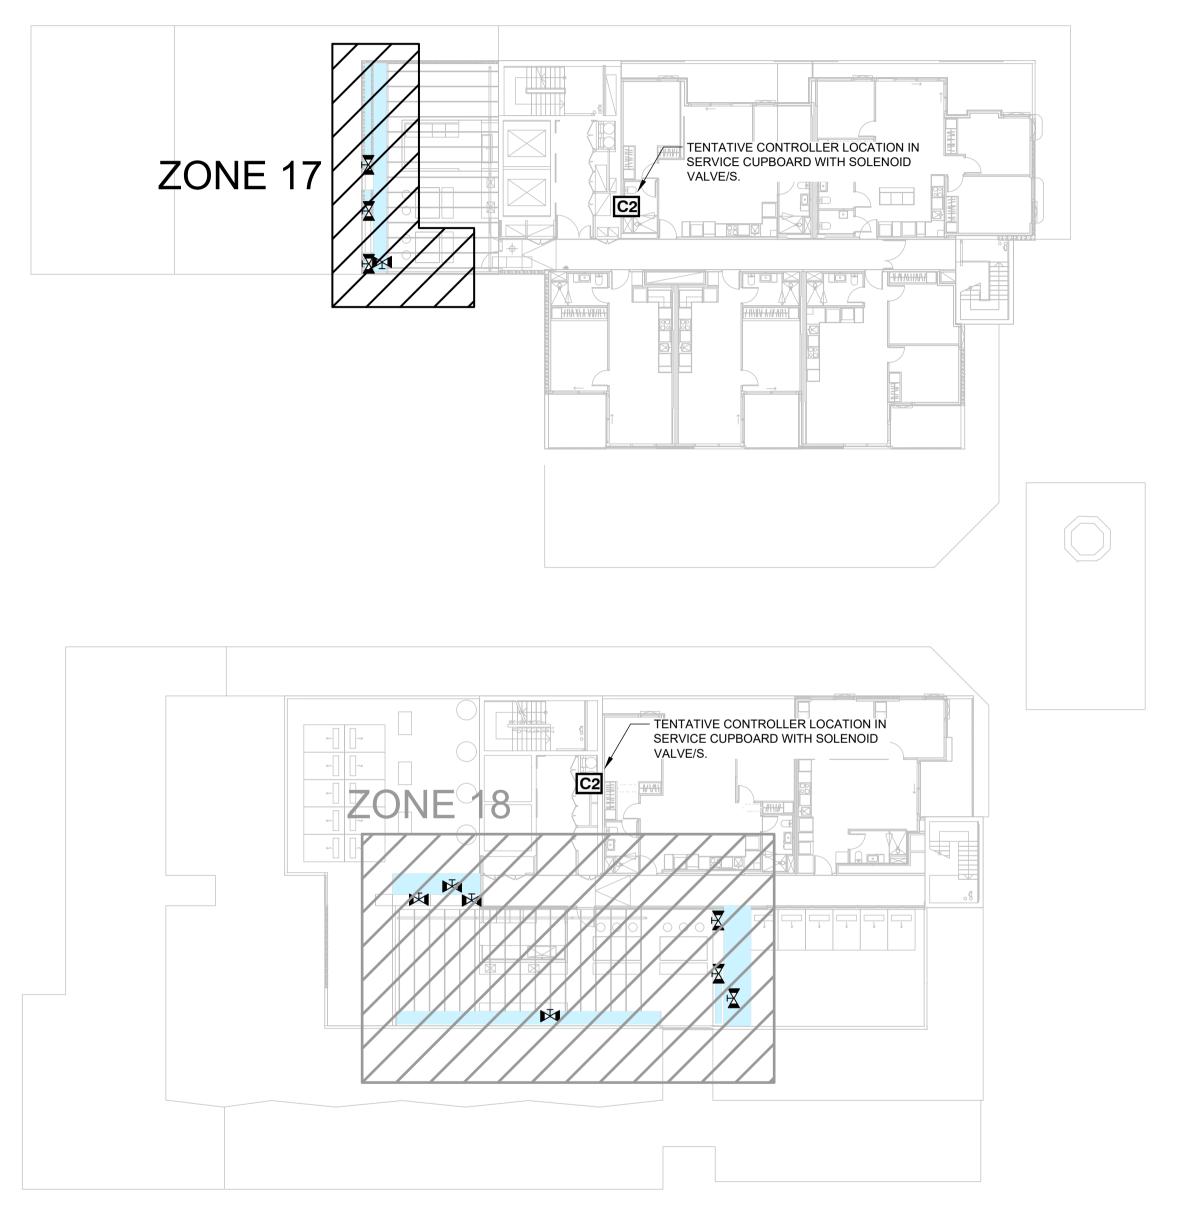AREA TO RECEIVE DRIPLINE
NETAFIM TLAS-XR-3.0-03
INTEGRAL PC, 13MM PURPLE

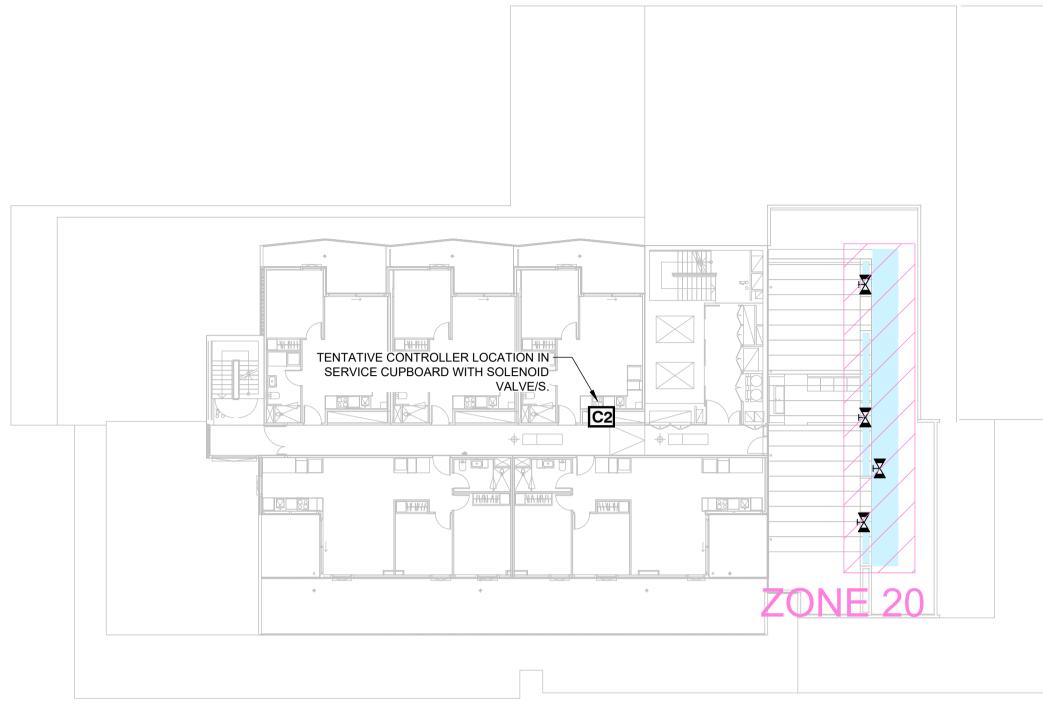NETAFIM TLAS-XR-3.0-03 INTEGRAL PC, 13MM PURPLE DRIPPERLINE. 3 LPH EMITTERS AT 30CM O.C. DRIPPERLINE LATERALS SPACED AT 30CM APART.

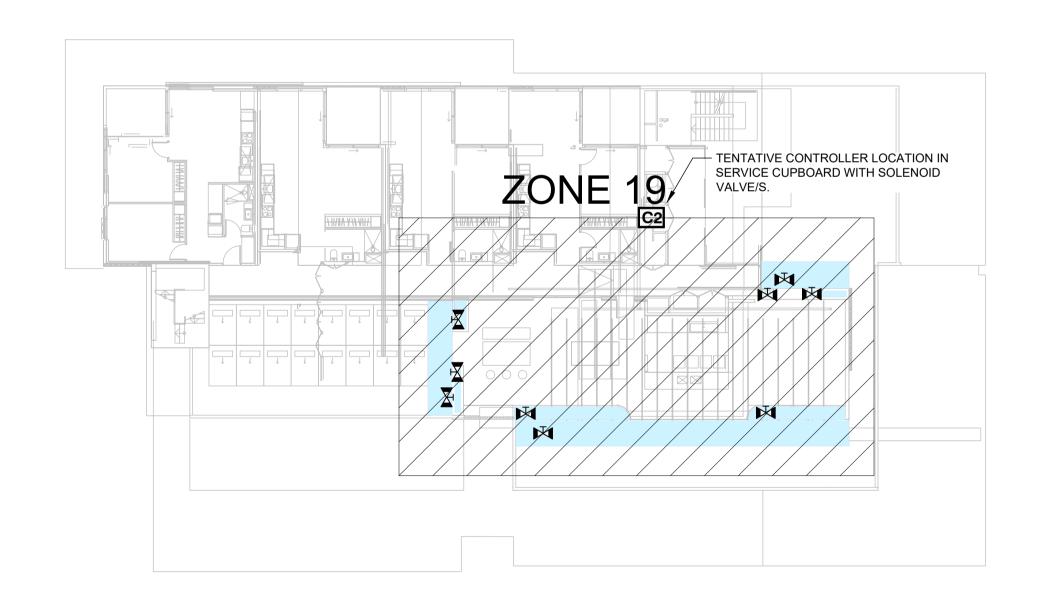SYMBOL MANUFACTURER/MODEL/DESCRIPTION

BALL VALVE BY HYDRAULICS WITHIN THE SOFT LANDSCAPE NOTE: TO BE INSTALLED BY THE PLUMBING CONTRACTOR. DOWNSTREAM OF THIS VALVE IS THE IRRIGATION CONTRACTORS RESPONSIBILITY TO LAY THE IRRIGATION LINES AND EQUIPMENT.

PRESSURE REQUIREMENT AT THIS LOCATION IS 250 KPA MINIMUM (TO BE PROVIDED BY HYDRAULICS).

HUNTER HCC HYDRAWISE® CONTROLLER W/EZ-DM, 54-STATION DECODER OUTPUT MODULE - LOCATION TBA.

HUNTER PHC HYDRAWISE® CONTROLLER - LOCATION TBA.

VALVE SCHEDULE ROOFTOP

NUMBER	MODEL	SIZE	TYPE	<u>l/min</u>	PRECIP
17 18 19 20	RAIN BIRD PEB-100 RAIN BIRD PEB-100 RAIN BIRD PEB-100 RAIN BIRD PEB-100	25mm 25mm 25mm 25mm	AREA FOR DRIPLINE AREA FOR DRIPLINE AREA FOR DRIPLINE AREA FOR DRIPLINE	5.3 13.6 25.35 14.4	33.54 mm/h 33.13 mm/h 32.26 mm/h 32.7 mm/h
^ ^ ^ ^		\			^ ^

ADVERTISED PLAN

NOTES
THESE DRAWINGS ARE TO BE READ IN CONJUNCTION WITH ALL
LANDSCAPE PLANS AND TECHNICAL SPECIFICATION AND OTHER
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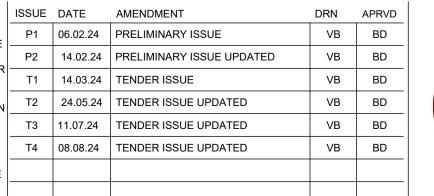
ISSUE DATE AMENDMENT

P1 06.02.24 PRELIMINARY ISSUE
P2 14.02.24 PRELIMINARY ISSUE UPDATED


T1 14.03.24 TENDER ISSUE UPDATED

T2 24.05.24 TENDER ISSUE UPDATED







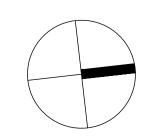



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ASSEMBLE

LANDSCAPE ARCHITECT

MALA STUDIO

LEVEL 1/11 AMSTERDAM STREET,

RICHMOND, VIC 3121

STATUS	DRAWING TITLE
TENDER ISSUE	IRRIGATION PLAN ROOFTOP
DRAWING SCALE BAR 0 2m 5m 10m 20i	JOB NO. SHEET SIZE A1
	DRAWING NO. ISSUE
SCALE: 1:200	3344-VSB-RT-SW-IR-04 T4