GENERAL NOTES (NCC 2019 BCA Vol 2)

- ALL MATERIALS AND WORK PRACTICES SHALL COMPLY WITH, BUT NOT LIMITED TO THE BUILDING REGULATIONS 2018, NATIONAL CONSTRUCTION CODE SERIES 2019, THE BUILDING CODE OF AUSTRALIA VOL 2 AND ALL RELEVANT CURRENT AUSTRALIAN STANDARDS (AS AMENDED) REFERRED TO
- UNLESS OTHERWISE SPECIFIED THE TERM BCA SHALL REFER TO NATIONAL
- ALL MATERIALS AND CONSTRUCTION PRACTICE SHALL MEET THE PERFORMANCE REQUIREMENTS OF THE BCA. WHERE A PERFORMANCE SOLUTION IS PROPOSED THEN, PRIOR TO IMPLEMENTATION OR INSTALLATION, IT FIRST MUST BE ASSESSED AND APPROVED BY THE RELEVANT BUILDING SURVEYOR AS MEETING THE PERFORMANCE REQUIREMENTS OF THE BCA. - GLAZING INCLUDING SAFETY GLAZING SHALL BE INSTALLED TO A SIZE, TYPE & (OTHER THAN TENSIONED WIRE BALUSTRADES) TO BE: THICKNESS SO AS TO COMPLY WITH;
 - BCA PART 3.6 FOR CLASS 1 AND 10 BUILDINGS WITHIN A DESIGN WIND SPEED OF NOT MORE THAN N3, AND
 - BCA VOL 1 PART B1.4 FOR CLASS 2 TO 9 BUILDINGS
- WATERPROOFING OF WET AREAS, BEING BATHROOMS, SHOWERS, SHOWER ROOMS, LAUNDRIES, SANITARY COMPARTMENTS AND THE LIKE SHALL BE PROVIDED IN ACCORDANCE WITH AS 3740-2010: WATERPROOFING OF DOMESTIC WET AREAS

SUSTAINABILITY MEASURES FOR NEW CLASS 1 BUILDINGS.

THESE DRAWINGS SHALL BE READ IN CONJUNCTION WITH ANY HOUSE ENERGY RATING (HERS) REPORT AND SHALL BE CONSTRUCTED IN ACCORDANCE WITH THE STAMPED PLANS ENDORSED BY THE ACCREDITED THERMAL PERFORMANCE ASSESSOR WITHOUT ALTERATION.

SITE BUSHFIRE ATTACK ASSESSMENT.

REFERENCE DOCUMENT AS 3959-2018 CONSTRUCTION OF BUILDINGS IN BUSHFIRE PRONE AREAS.

- THESE DRAWINGS SHALL BE READ IN CONJUNCTION WITH ALL RELEVANT STRUCTURAL AND ALL OTHER CONSULTANTS DRAWINGS/ DETAILS AND WITH ANY OTHER WRITTEN INSTRUCTIONS ISSUED IN THE COURSE OF THE CONTRACT.
- SITE PLAN MEASUREMENTS IN MILLIMETRES ALL OTHER MEASUREMENTS IN MILLIMETRES U.N.O.
- FIGURED DIMENSIONS TAKE PRECEDENCE OVER SCALED DIMENSIONS. - THE BUILDER SHALL TAKE ALL STEPS NECESSARY TO ENSURE THE STABILITY AND
- GENERAL WATER TIGHTNESS OF ALL NEW AND/OR EXISTING STRUCTURES DURING ALL WORKS. - THE BUILDER AND SUBCONTRACTORS SHALL CHECK AND VERIFY ALL
- DIMENSIONS, SETBACKS, LEVELS AND SPECIFICATIONS AND ALL OTHER RELEVANT DOCUMENTATION PRIOR TO THE COMMENCEMENT OF ANY WORKS. REPORT ALL DISCREPANCIES TO THIS OFFICE FOR CLARIFICATION

SITE CLASSIFICATION

SITE CLASSIFICATION AS CLASS:	Н
REFER TO SOIL REPORT NO:	TBC
BY:	TBC

STORMWATER

90mmØ (UPTO 250m2) OR 100mmØ (OVER 250m2) CLASS 6 UPVC STORMWATER LINE LAID TO A MINIMUM GRADE OF 1:100 AND CONNECTED TO THE LEGAL POINT OF STORMWATER DISCHARGE. PROVIDE INSPECTION OPENINGS AT 9000MM C/C AND AT EACH CHANGE OF DIRECTION. THE COVER TO UNDERGROUND STORMWATER DRAINS SHALL BE NOT LESS THAN

- 100MM UNDER SOIL
- 50MM UNDER PAVED OR CONCRETE AREAS
- 100MM UNDER UNREINFORCED CONCRETE OR PAVED DRIVEWAYS
- 75MM UNDER REINFORCED CONCRETE DRIVEWAYS

AUTHORITIES/CONSULTANTS

MUNICIPALITY NAME:	MONASH CITY COUNCIL
SEWAGE AUTHORITY:	YARRA VALLEY WATER
CONSULTING STRUCTURAL ENGINEER:	TBC
GEOTECHNICAL ENGINEER:	TBC
THERMAL PERFORMANCE ASSESSOR:	TBC
CONSULTING STRUCTURAL ENGINEER: GEOTECHNICAL ENGINEER:	TBC TBC

- STEP SIZES (OTHER THAN FOR SPIRAL STAIRS) TO BE:
- RISERS (R) 190MM MAXIMUM AND 115MM MINIMUM
- GOING (G) 355MM MAXIMUM AND 240MM MINIMUM
- 2R + 1G = 700MM MAXIMUM AND 550MM MINIMUM
- WITH LESS THAN 125MM MAXIMUM GAP BETWEEN OPEN TREADS - ALL TREADS, LANDINGS AND THE LIKE TO HAVE A SLIP-RESISTANCE
- CONSTRUCTION CODE SERIES 2019 BUILDING CODE OF AUSTRALIA VOLUME 2 CLASSIFICATION OF P3 OR R10 FOR DRY SURFACE CONDITIONS AND P4 OR R11 FOR WET SURFACE CONDITIONS, OR A NOSING STRIP WITH A SLIP-RESISTANCE CLASSIFIATION OF P3 FOR DRY SURFACE CONDITIONS AND P4 FOR WET SURFACE CONDITIONS.
 - PROVIDE BARRIERS WHERE CHANGE IN LEVEL EXCEEDS 1000MM ABOVE THE SURFACE BENEATH LANDINGS, RAMPS AND/OR TREADS. BARRIERS
 - 1000MM MIN. ABOVE FINISHED SURFACE LEVEL OF BALCONIES, LANDINGS OR THE LIKE, AND
 - 865MM MIN. ABOVE FINISHED SURFACE LEVEL OF STAIR NOSING OR
 - VERTICAL WITH LESS THAN 125MM GAP BETWEEN, AND
 - ANY HORIZONTAL ELEMENT WITHIN THE BALUSTRADE BETWEEN 150MM AND 760MM ABOVE THE FLOOR MUST NOT FACILITATE CLIMBING WHERE CHANGES IN LEVEL EXCEEDS 4000MM ABOVE THE SURFACE BENEATH LANDINGS, RAMPS AND/OR TREADS.
 - -WIRE BARRIER CONSTRUCTION TO COMPLY WITH NCC 2019 BCA PART 3.9.2.3 FOR CLASS 1 AND 10 BUILDINGS AND NCC 2019 BCA VOLUME 1 PART D2.16 FOR OTHER CLASSES OF BUILDINGS.
 - TOP OF HAND RAILS TO BE 865MM MINIMUM ABOVE STAIR NOSING AND FLOOR SURFACE OF RAMPS.
 - WINDOW SIZES NOMINATED ARE NOMINAL ONLY, ACTUAL SIZE MAY VARY ACCORDING TO MANUFACTURER. WINDOWS TO BE FLASHED ALL AROUND.
 - WHERE THE BUILDING (EXCLUDES A DETACHED CLASS 10) IS LOCATED IN A TERMITE PRONE AREA THE AREA TO UNDERSIDE OF BUILDING AND PERIMETER IS TO BE PROVIDED WITH A TERMITE MANAGEMENT SYSTEM.
 - CONCRETE STUMPS: UP TO 1400MM LONG TO BE 100MM X 100MM (1 NO. H.D. WIRE) 1401MM TO 1800MM LONG TO BE 100MM X 100MM (2 NO. H.D. WIRES) 1801MM TO 3000MM LONG TO BE 125MM X 125MM (2 NO. H.D. WIRES
 - 100MM X 100MM STUMPS EXCEEDING 1200MM ABOVE GROUND LEVEL TO BE BRACED WHERE NO PERIMETER BASE BRICKWORK PROVIDED.
 - BUILDINGS IN MARINE OR OTHER EXPOSURE ENVIRONMENTS SHALL HAVE MASONRY UNITS, MORTAR AND ALL BUILT IN COMPONENTS AND THE LIKE COMPLYING WITH THE DURABILITY REQUIREMENTS OF TABLE 4.1 OF AS4773.1-2015 MASONRY IN SMALL BUILDINGS PART 1:DESIGN
 - EXTERNAL WALL TO VE PROVIDED WITH AS 4200.1 COMPLIANT VAPOUR PERMEABLE MEMBRANES INSTALLED IN ACCORDANCE WITH AS 4200.2 - ALL STORMWATER TO BE TAKEN TO THE LEGAL POINT OF DISCHARGE TO THE RELEVANT AUTHORITIES APPROVAL.
 - INSTALLATION OF ALL SERVICES SHALL COMPLY WITH THE RESPECTIVE SUPPLY AUTHORITY REQUIREMENTS.
 - EXHAUST SYSTEMS INSTALLED IN A KITCHEN, BATHROOM, SANITARY COMPARTMENT OR LAUNDRY MUST HAVE A MINIMUM FLOW RATE OF 25 L/S FOR A BATHROOM OR SANITARY COMPARTMENT AND 40 L/S FOR A KITCHEN OR LAUNDRY AND MUST BE DISCHARGED DIRECTLY OR VIA A SHAFT OR DUCT TO OUTDOOR AIR.
 - THE BUILDER AND SUBCONTRACTOR SHALL ENSURE THAT ALL STORMWATER DRAINS, SEWER PIPES AND THE LIKE ARE LOCATED AT A SUFFICIENT DISTANCE FROM ANY BUILDINGS FOOTING AND/OR SLAB EDGE BEAMS SO AS TO PREVENT GENERAL MOISTURE PENETRATION, DAMPNESS, WEAKENING AND UNDERMINING OF ANY BUILDING AND ITS FOOTING SYSTEM.
 - THESE PLANS HAVE BEEN PREPARED FOR THE EXCLUSIVE USE BY THE CLIENT OF HARGREAVES DESIGN GROUP ('THE DESIGNER') FOR THE PURPOSE EXPRESSLY NOTIFIED TO THE DESIGNER. ANY OTHER PERSON WHO USES OR RELIES ON THESE PLANS WITHOUT THE DESIGNER'S WRITTEN CONSENT DOES SO AT THEIR OWN RISK AND NO RESPONSIBILITY IS ACCEPTED BY THE DESIGNER FOR SUCH USE AND/ OR RELIANCE. - A BUILDING PERMIT IS REQUIRED PRIOR TO THE COMMENCEMENT OF THESE WORKS. THE RELEASE OF THESE DOCUMENTS IS CONDITIONAL TO

- THE CLIENT AND/OR THE CLIENT'S BUILDER SHALL NOT MODIFY OR AMEND THE PLANS WITHOUT THE KNOWLEDGE AND CONSENT OF HARGREAVES DESIGN GROUP EXCEPT WHERE A REGISTERED BUILDING SURVEYOR MAKES MINOR NECESSARY CHANGES TO FACILITATE THE BUILDING PERMIT APPLICATION AND THAT SUCH CHANGES ARE PROMPTLY REPORTED BACK TO HARGREAVES DESIGN GROUP.
- THE APPROVAL BY THIS OFFICE OF A SUBSTITUTE MATERIAL, WORK PRACTICE, VARIATION OR THE LIKE IS NOT AN AUTHORISATION FOR ITS USE OR A CONTRACT VARIATION. ALL VARIATIONS MUST BE ACCEPTED BY ALL PARTIES TO THE AGREEMENT AND WHERE APPLICABLE THE RELEVANT BUILDING SURVEYOR PRIOR TO IMPLEMENTING ANY VARIATION.

THESE DRAWINGS SHALL BE READ IN CONJUNCTION WITH ALL RELEVANT STRUCTURAL AND ALL OTHER CONSULTANTS DRAWINGS/DETAILS AND WITH ANY OTHER WRITTEN INSTRUCTIONS ISSUED IN THE COURSE OF THE CONTRACT. ALL MEASUREMENTS IN MILLIMETRES UNLESS NOTED **OTHERWISE**

FIGURED DIMENSIONS TAKE PRECEDENCE OVER SCALED DIMENSIONS.

THE BUILDER SHALL TAKE ALL STEPS NECESSARY TO ENSURE THE STABILITY AND GENERAL WATER TIGHTNESS OF ALL NEW AND/OR EXISTING STRUCTURES DURING ALL WORKS. THE BUILDER AND SUBCONTRACTORS SHALL CHECK AND VERIFY ALL DIMENSIONS, SETBACKS, LEVELS AND SPECIFICATIONS AND ALL OTHER RELEVANT DOCUMENTATION PRIOR TO THE COMMENCEMENT OF ANY WORKS. REPORT ALL DISCREPANCIES TO THIS OFFICE FOR CLARIFICATION.

INSTALLATION OF ALL SERVICES SHALL COMPLY WITH THE RESPECTIVE SUPPLY AUTHORITY REQUIREMENTS.

BUSHFIRE ATTACK LEVEL:-(BAL)

TBC

ALL HOMES TO COMPLY WITH AS 3959-2018 (BAL)

WIND SPEED ASSESSMENT:

MAXIMUM DESIGN GUST


TBC

IMPORTANT NOTE:

THE WIND SPEED CALCULATION IS TAKEN FROM THE JOB SPECIFIC SOIL REPORT (FRONT PAGE)

STANDARD HOMES ARE DESIGNED TO SUIT A MINIMUM WIND GUST SPEED OF 33 m/s

ADVERTISED

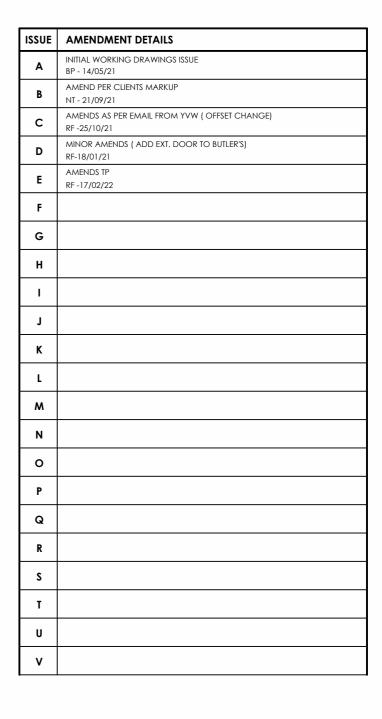







proposed: **EXTENSION**

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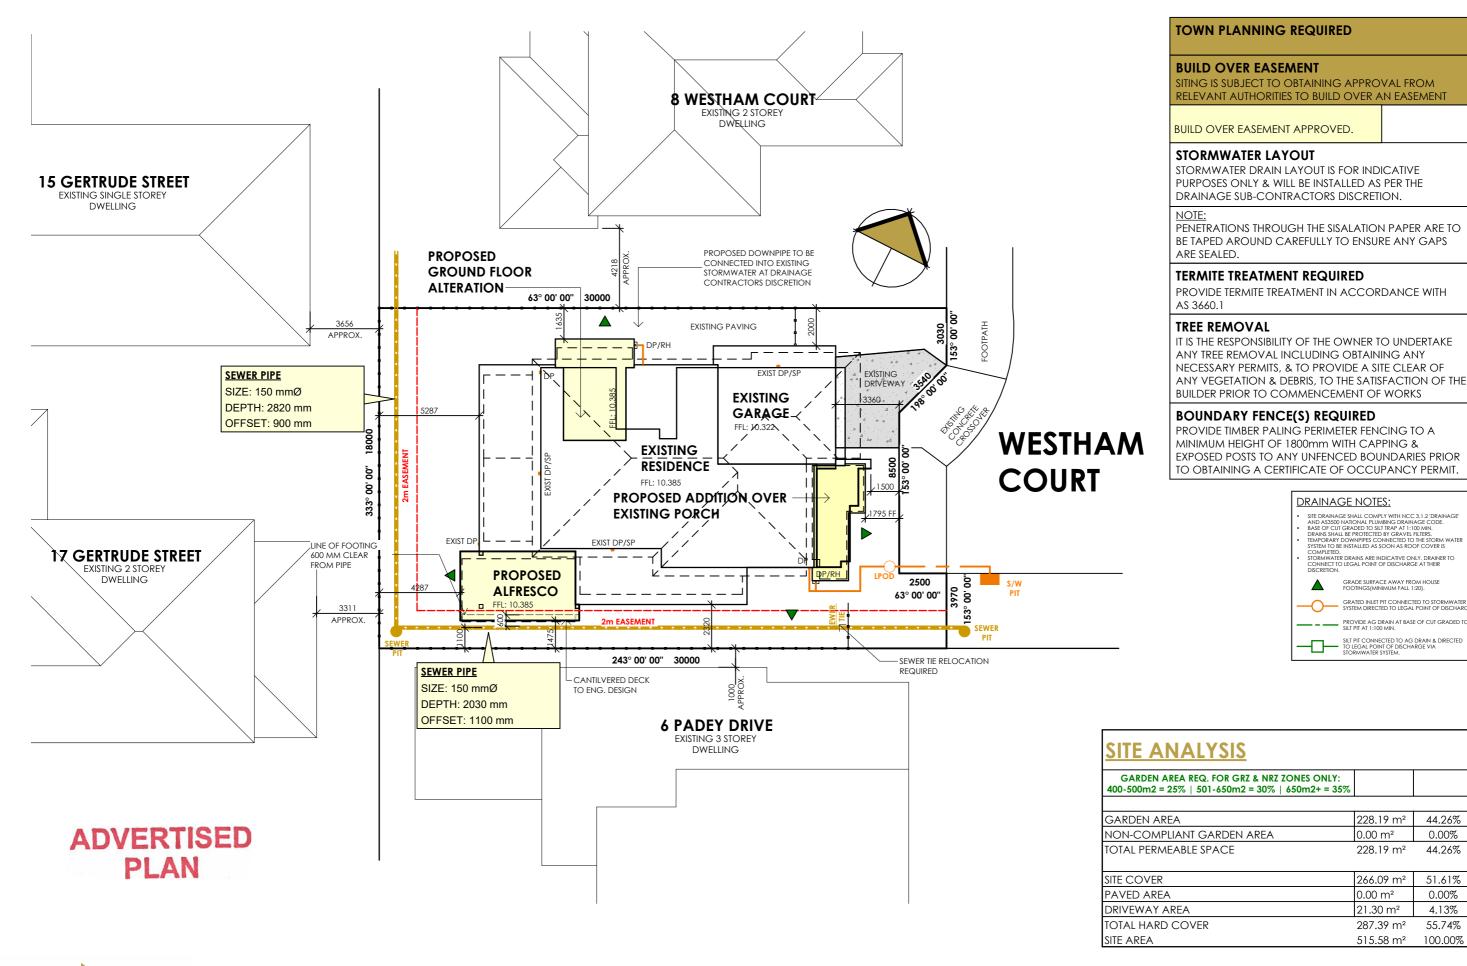
THE OWNER OBTAINING THE REQUIRED BUILDING PERMIT.

for: CINDY & CHEN TAN

address: 7 WESTHAM COURT MULGRAVE, 3170

drawing: **GENERAL NOTES**

iob no.: 21-04085 date: 14/05/21 scale: sheet: 1 of 17 issue: **E** date: 17/02/22 drawn: BP





proposed: **EXTENSION**

for: CINDY & CHEN TAN drawing: SITE PLAN

address: 7 WESTHAM COURT **MULGRAVE, 3170**

job no.: 21-04085

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44.26%

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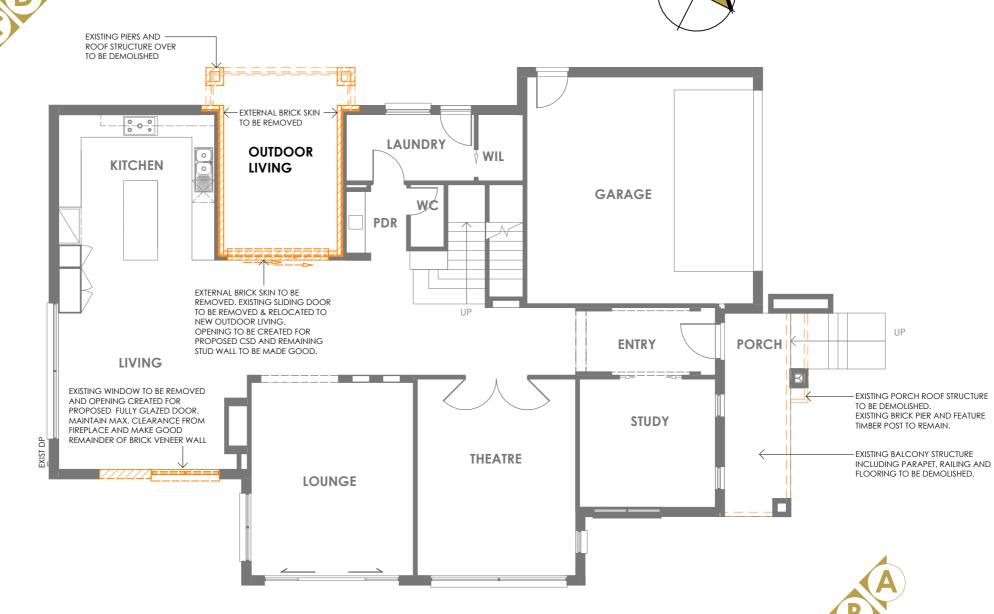
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55.74%

100.00%





EXISTING AREAS TABLE			
AREAS	(m²)	(sq)	
GROUND FLOOR	165.90 m ²	17.86	
FIRST FLOOR	154.81 m ²	16.66	
SUB TOTAL EXISTING:	320.71 m²	34.52	
GARAGE	39.18 m ²	4.22	
PORCH	11.45 m²	1.23	
OUTDOOR LIVING	15.94 m ²	1.72	
BALCONY	10.53 m ²	1.13	
TOTAL OTHER (EXISTING)	77.10 m ²	8.30	
EXISTING	397.80 m ²	42.82	



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proposed: **EXTENSION**

for: CINDY & CHEN TAN

address: 7 WESTHAM COURT


drawing: **EXISTING/DEMO GROUND FL.**

MULGRAVE, 3170

job no.: **21-04085**

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EXISTING AREAS TABLE AREAS (m²)(sq) GROUND FLOOR 165.90 m² 17.86 FIRST FLOOR 154.81 m² 16.66 SUB TOTAL EXISTING: 320.71 m² 34.52 GARAGE 39.18 m² 4.22 PORCH 11.45 m² 1.23 OUTDOOR LIVING 15.94 m² 1.72 BALCONY 10.53 m² 1.13 TOTAL OTHER (EXISTING) 8.30 77.10 m² EXISTING 397.80 m² 42.82

ADVERTISED PLAN

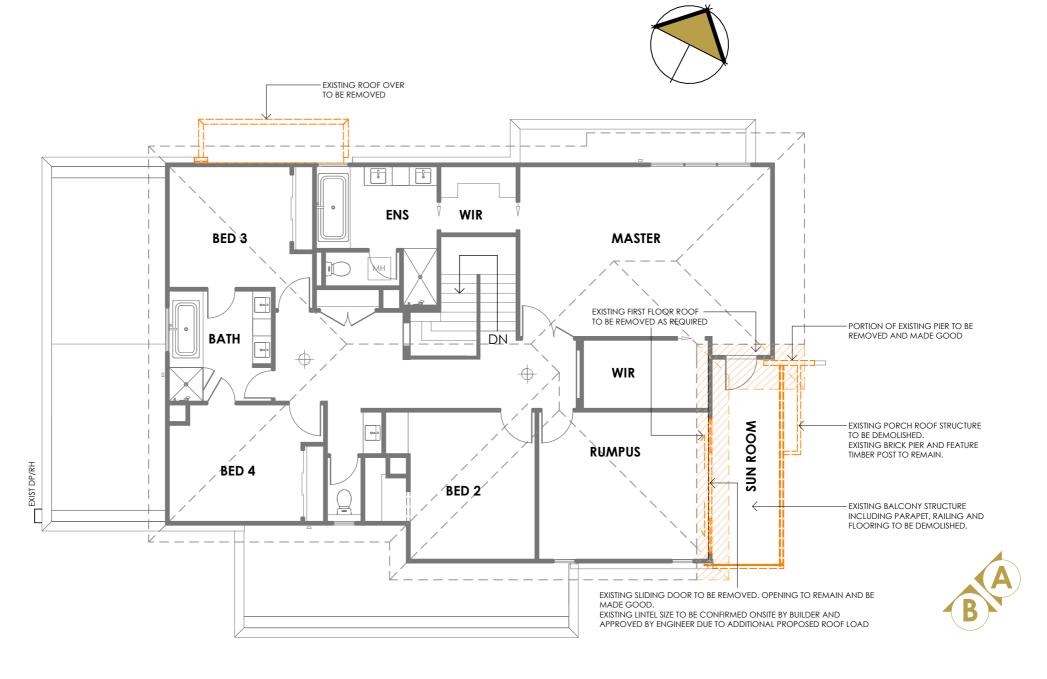

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date: 14/05/21 scale: 1:100

proposed: **EXTENSION**

for: CINDY & CHEN TAN
drawing: EXISTING/DEMO FIRST FL.

drawn: BP

address: 7 WESTHAM COURT MULGRAVE, 3170


sheet: **4** of **17**


issue: **E** date: **17/02/22**



- WRITTEN DIMENSIONS ALWAYS TAKE PREFERENCE OVER SCALE BUILDER MAY ADJUST GARAGE DOOR HEIGHT ON SITE AS REQ UNLESS OTHERWISE INDICATED ALL WALL DIMENSIONS ARE: * EXTERNAL 240mm = 110 BRICK, 40 CAVITY, 90 STUD

- Ф

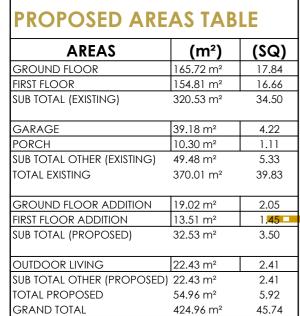

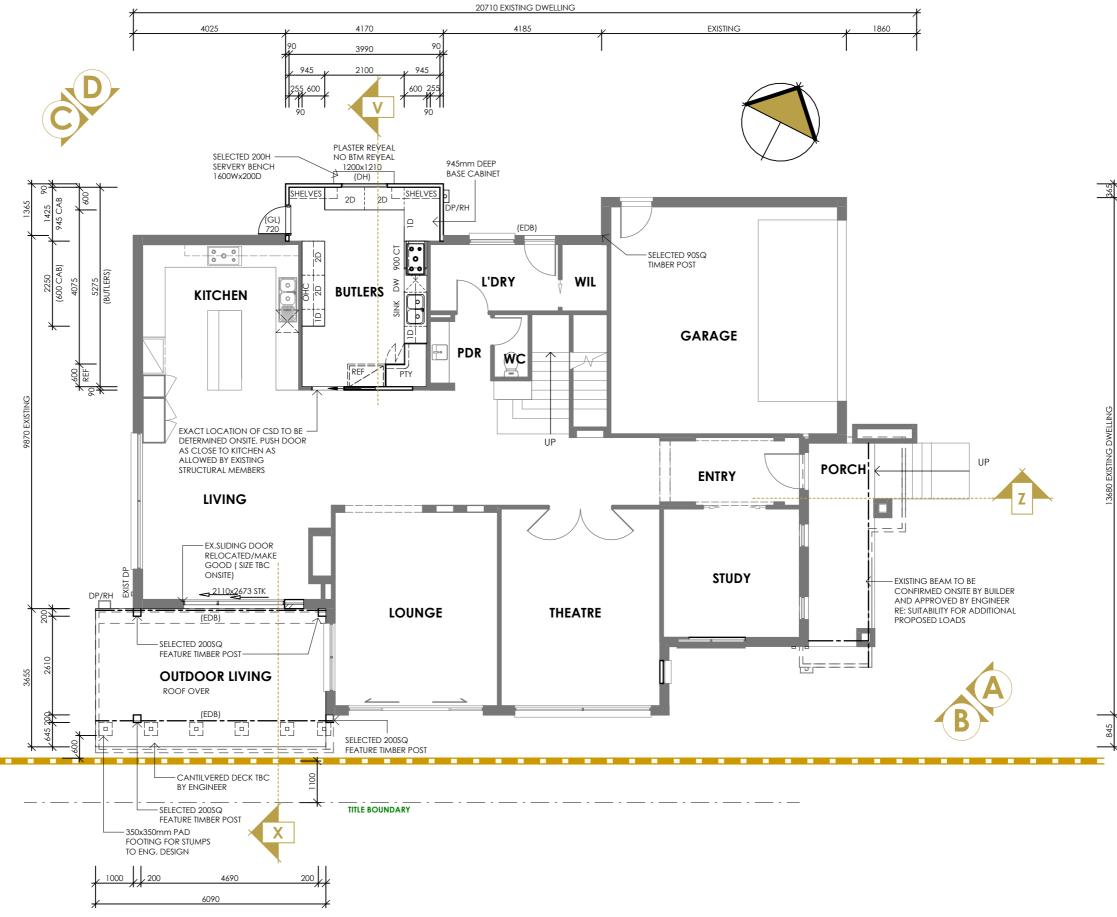



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for: CINDY & CHEN TAN

address: 7 WESTHAM COURT

MULGRAVE, 3170

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proposed: **EXTENSION**

SHALL REMAIN THE PROPERTY OF HARGREAVES DESIGN GROUP

date: 14/05/21 scale: 1:100

drawing: PROPOSED GROUND FL.


sheet: **5** of **17**


date: 17/02/22 issue: **E**



- WRITTEN DIMENSIONS ALWAYS TAKE PREFERENCE OVER SCALE BUILDER MAY ADJUST GARAGE DOOR HEIGHT ON SITE AS REQI UNLESS OTHERWISE INDICATED ALL WALL DIMENSIONS ARE: * EXTERNAL 240mm = 110 BRICK, 40 CAVITY, 90 STUD

- Ф

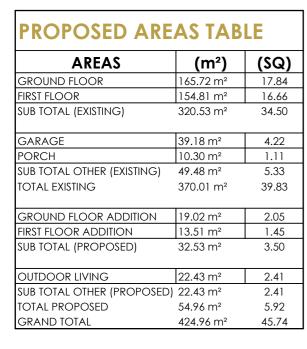

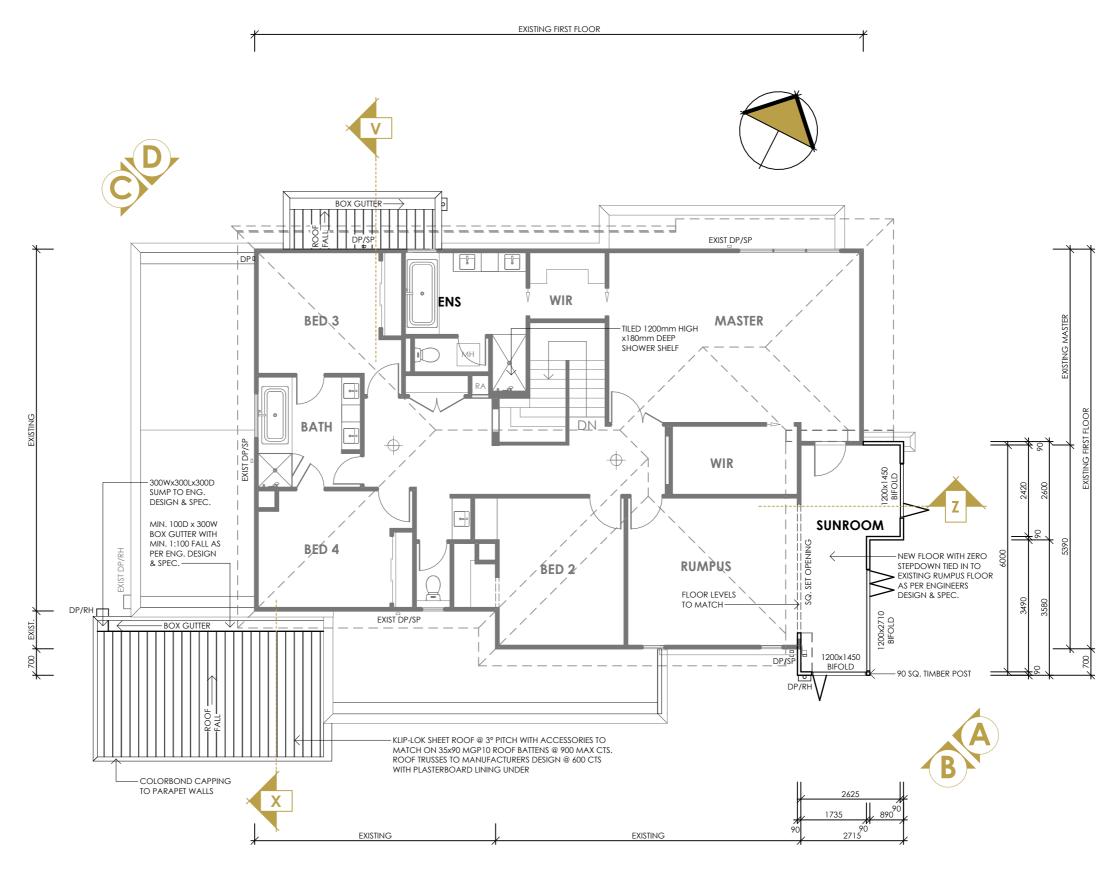



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proposed: **EXTENSION**

for: CINDY & CHEN TAN drawing: PROPOSED FIRST FL.

drawn: BP


address: 7 WESTHAM COURT MULGRAVE, 3170

sheet: 6 of 17

date: 14/05/21 scale: 1:100

issue: **E**

job no.: **21-04085** date: 17/02/22

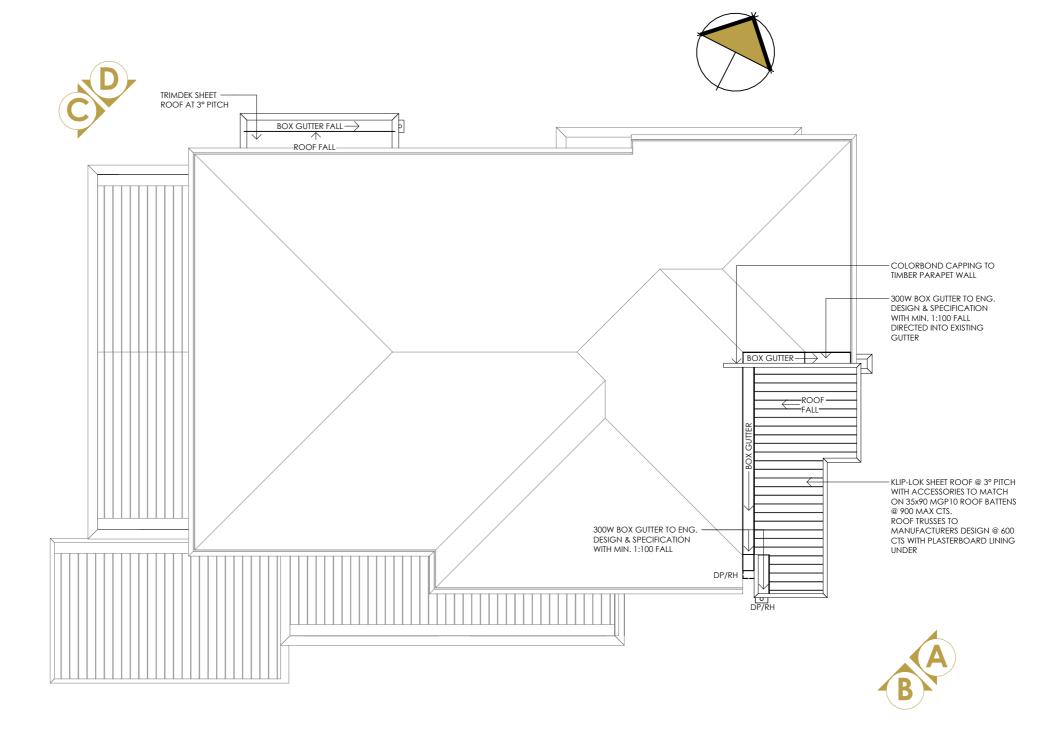






proposed: **EXTENSION**

for: CINDY & CHEN TAN drawing: PROPOSED FIRST ROOF

address: 7 WESTHAM COURT MULGRAVE, 3170

job no.: **21-04085** date: 14/05/21 scale: 1:100 sheet: **7** of **17** date: 17/02/22

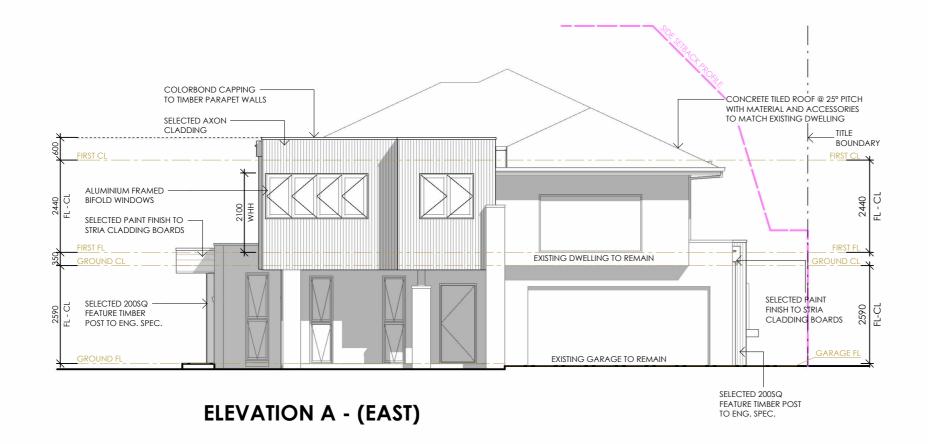





ELEVATION B - (SOUTH)

EXTERNAL DOOR THRESHOLDS:

THRESHOLDS OF EXTERNAL DOORS TO BE NO GREATER THAN 230MM ABOVE THE ADJOINING SURFACE



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proposed: **EXTENSION**

for: CINDY & CHEN TAN drawing: PROPOSED ELEVATIONS address: 7 WESTHAM COURT


MULGRAVE, 3170


sheet: **8** of **17**

date: 14/05/21 scale: 1:100

issue: **E**

date: 17/02/22

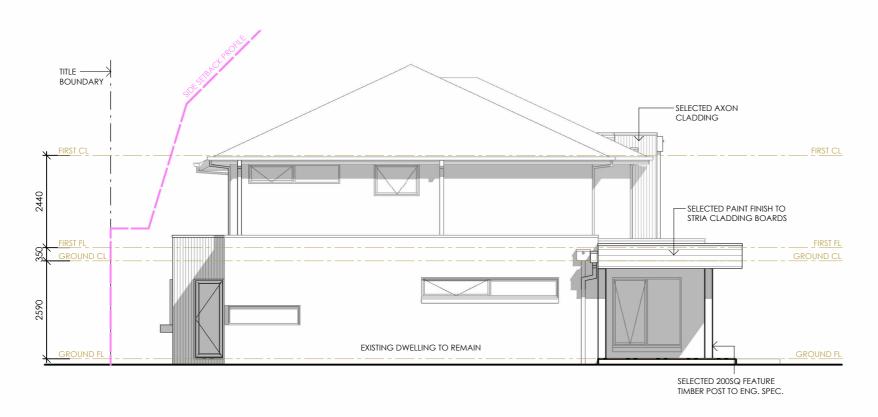

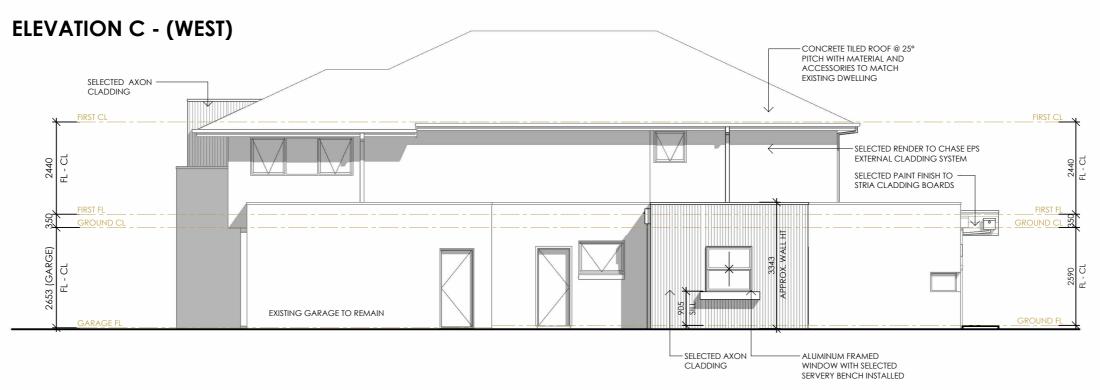

ELEVATION D - (NORTH)




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proposed: **EXTENSION**

for: CINDY & CHEN TAN
drawing: PROPOSED ELEVATIONS

address: 7 WESTHAM COURT MULGRAVE, 3170

sheet: 9 of 17 issue: E date: 17/02/22 job no.: 21-04085

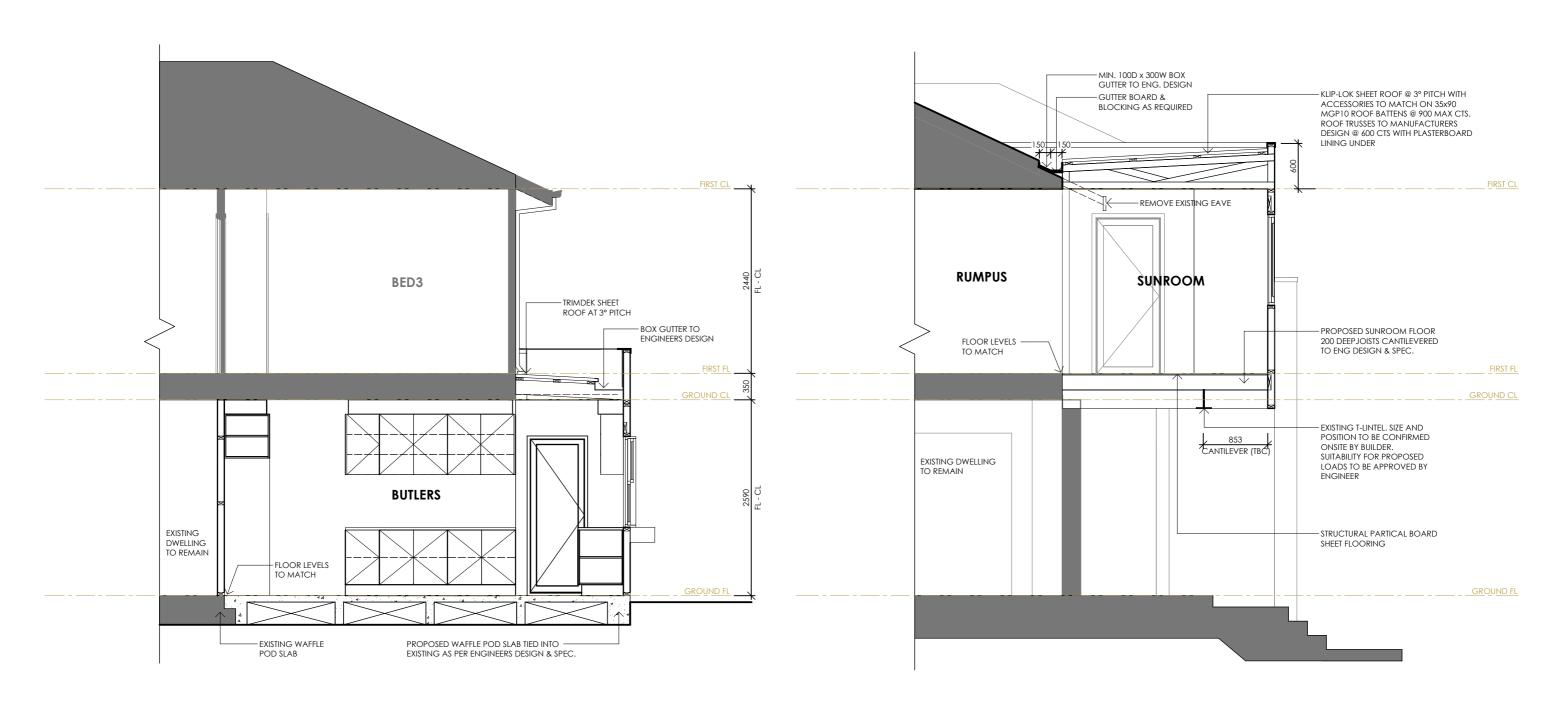

SECTION Z SECTION V



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proposed: **EXTENSION** for: CINDY & CHEN TAN

address: 7 WESTHAM COURT MULGRAVE, 3170

drawn: BP

drawing: **SECTIONS**

date: 14/05/21 scale: 1:50

sheet: 10 of 17

date: 17/02/22 issue: **E**

EXTERNAL LINTEL SCHEDULE


UPPER FLOOR LINTELS - BASED ON 500mm OF VENEER OVER

SPAN (UP TO)	SIZE	ANGLE
1200mm	75x75x8	MS ANGLE
2100mm	75x100x8	MS ANGLE
3000mm	100x100x8	MS ANGLE


LOWER FLOOR LINTELS - BASED ON 3000mm OF VENEER OVER

SPAN (UP TO)	SIZE	ANGLE	
1200mm	75x100x8	MS ANGLE	
2100mm	100x100x8	MS ANGLE	
3000mm	150x100x10	MS ANGLE	


FIRST DIMENSION VERTICAL, 120mm MIN. END BEARING TO LINTELS

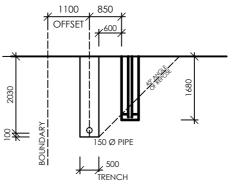

ANGLE OF REPOSE DETAIL

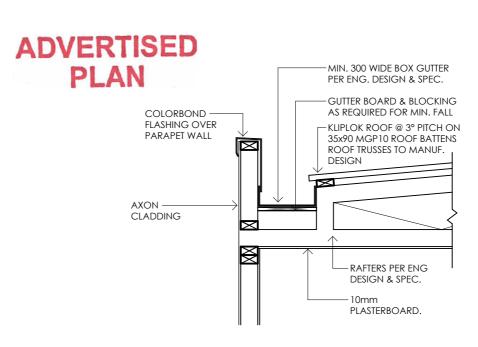

TYP. BOX GUTTER DETAIL

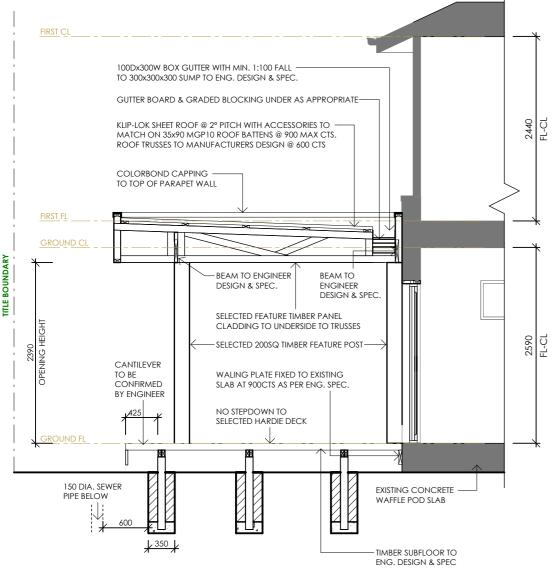

SECTION X

1:50

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proposed: **EXTENSION**

drawing: **SECTIONS**

address: 7 WESTHAM COURT MULGRAVE, 3170

date: 14/05/21 scale: As indicated drawn: BP

date: 17/02/22

job no.: 21-04085

TIMBER FRAMING SCHEDULE RLW: 7500 SINGLE STOREY OR UPPER STOREY LOADBEARING WALLS

2/90x35

90x35

90x45

2/90x45

200x35

2/200x35

2/300x35

* Sizes may be built up using vertical nail lamination

90x35

2/90x35

90x35

WAFFLE POD CONCRETE SLAB FLOOR

AS PER ENG LINTELS IN LOWER STOREY WALLS OF A TWO STOREY TO ENGINEERS DESIG

TIMBER FABRICATED AS PER MANUF. SPECIFICATIONS @ MAX 600 CTS

SIZE

SIZE

- TRUSSES @ 600 CTS

IN ACCORDANCE WITH AS 1684-2010

MGP10

MGP10

MGP10

MGP10

MGP10

MGP10

LVL15 1800

LVL15 2300

LVL15 3350

G SPAN CTRS

G SPAN CTRS

450

3100

CONCRETE TILED ROOF

WAFFLE POD CONCRETE SLAB FLOOR

MEMBER

Top plate Studs

Jamb studs 1

Jamb studs 2

Wall bracing

Noggings

intel 1

intel 2

intel 3

Porch Beam

MEMBER

Top plate

Jamb studs 1

Studs

TRUSSED ROOF


NON LOADBEARING WALLS

for: CINDY & CHEN TAN

sheet: 11 of 17

issue: **E**

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ADVERTISED

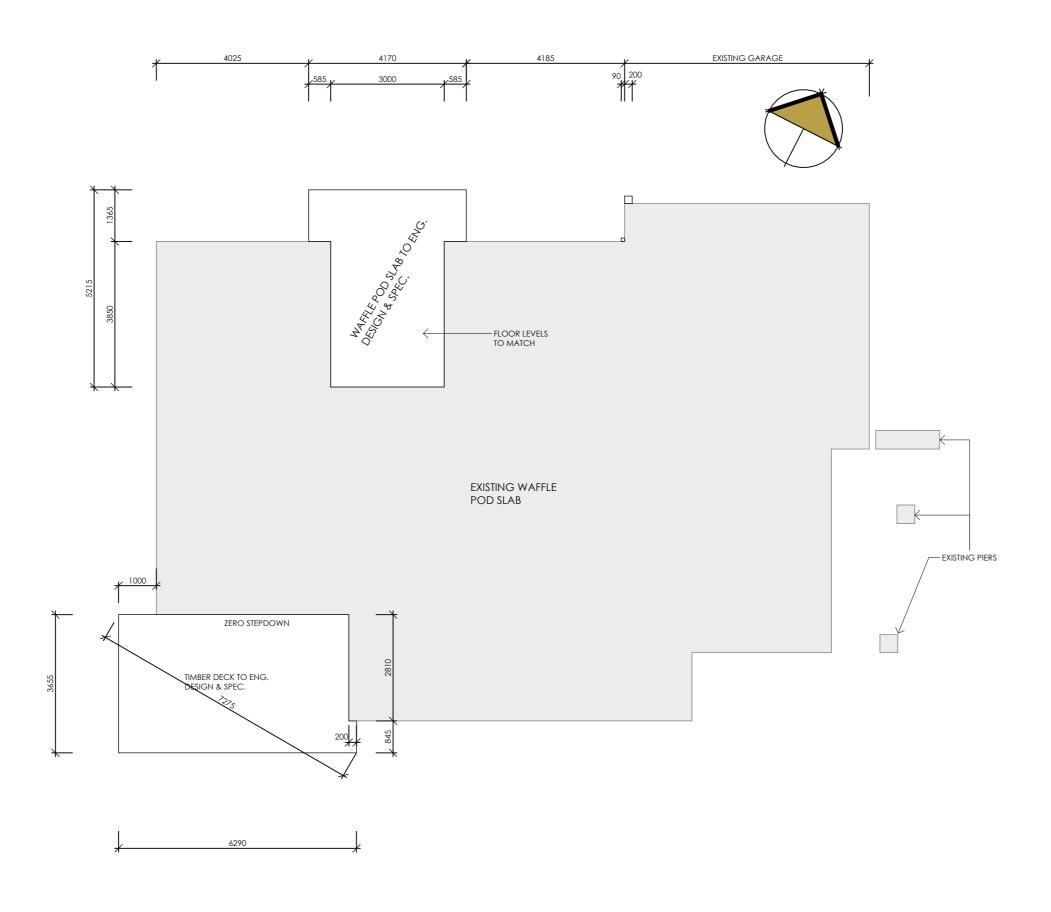PLAN


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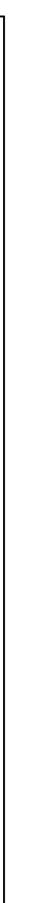
proposed: **EXTENSION**


for: CINDY & CHEN TAN drawing: **SETOUT PLAN**

address: 7 WESTHAM COURT MULGRAVE, 3170

> sheet: **12** of **17** date: 17/02/22



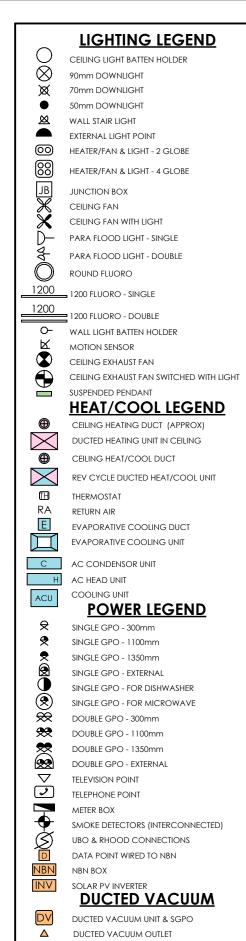

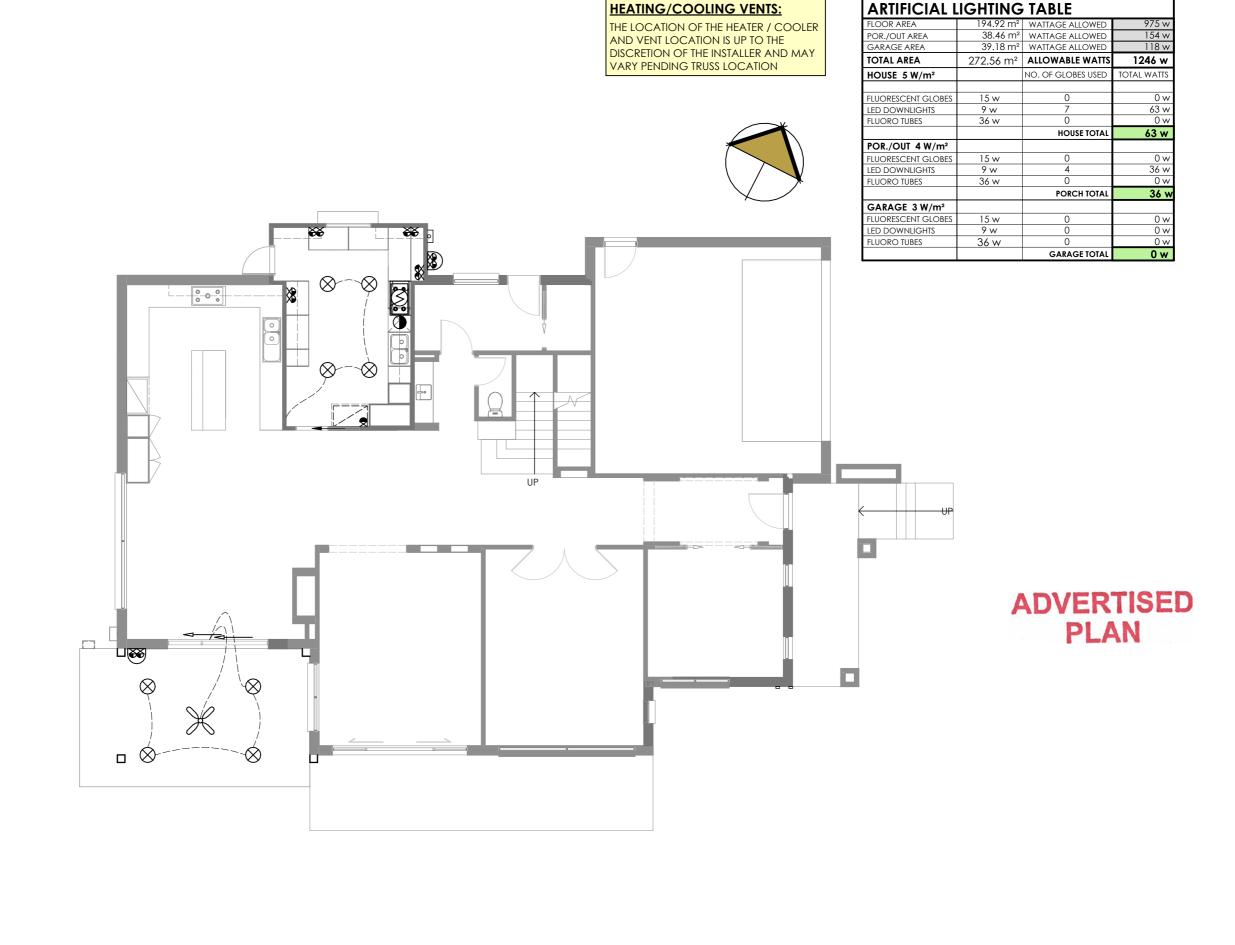



proposed: **EXTENSION**

for: CINDY & CHEN TAN

address: 7 WESTHAM COURT MULGRAVE, 3170


drawing: GROUND ELECTRICAL PLAN

date: 14/05/21 scale: 1:100 sheet: 13 of 17 issue: **E**

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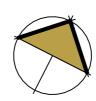
drawn: BP

date: 17/02/22



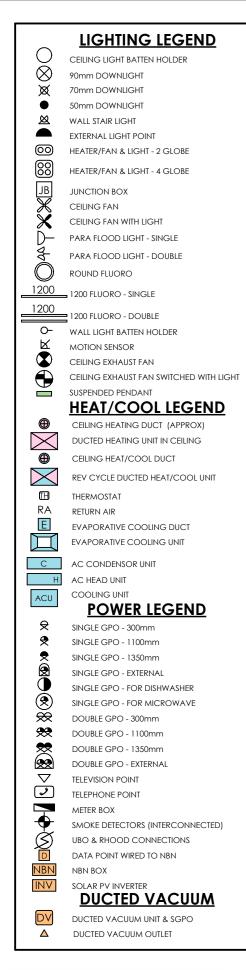

THE LOCATION OF THE HEATER / COOLER AND VENT LOCATION IS UP TO THE DISCRETION OF THE INSTALLER AND MAY VARY PENDING TRUSS LOCATION



ARTIFICIAL LIGHTING TABLE				
FLOOR AREA	175.19 m ²	WATTAGE ALLOWED	876 w	
POR./OUT AREA	0.00 m ²	WATTAGE ALLOWED	0 w	
GARAGE AREA	0.00 m ²	WATTAGE ALLOWED	0 w	
TOTAL AREA	175.19 m ²	ALLOWABLE WATTS	876 w	
HOUSE 5 W/m ²		NO. OF GLOBES USED	TOTAL WATTS	
FLUORESCENT GLOBES	15 w	0	0 w	
LED DOWNLIGHTS	9 w	7	63 w	
FLUORO TUBES	36 w	0	0 w	
		HOUSE TOTAL	63 w	
POR./OUT 4 W/m ²				
FLUORESCENT GLOBES	15 w	0	0 w	
LED DOWNLIGHTS	9 w	0	0 w	
FLUORO TUBES	36 w	0	0 w	
		PORCH TOTAL	0 w	
GARAGE 3 W/m ²				
FLUORESCENT GLOBES	15 w	0	0 w	
LED DOWNLIGHTS	9 w	0	0 w	
FLUORO TUBES	36 w	0	0 w	
·		GARAGE TOTAL	0 w	



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proposed: **EXTENSION**

for: CINDY & CHEN TAN drawing: FIRST ELECTRICAL PLAN address: 7 WESTHAM COURT MULGRAVE, 3170


drawn: BP

date: 14/05/21 scale: 1:100

sheet: **14** of **17**

issue: **E**

job no.: **21-04085** date: 17/02/22

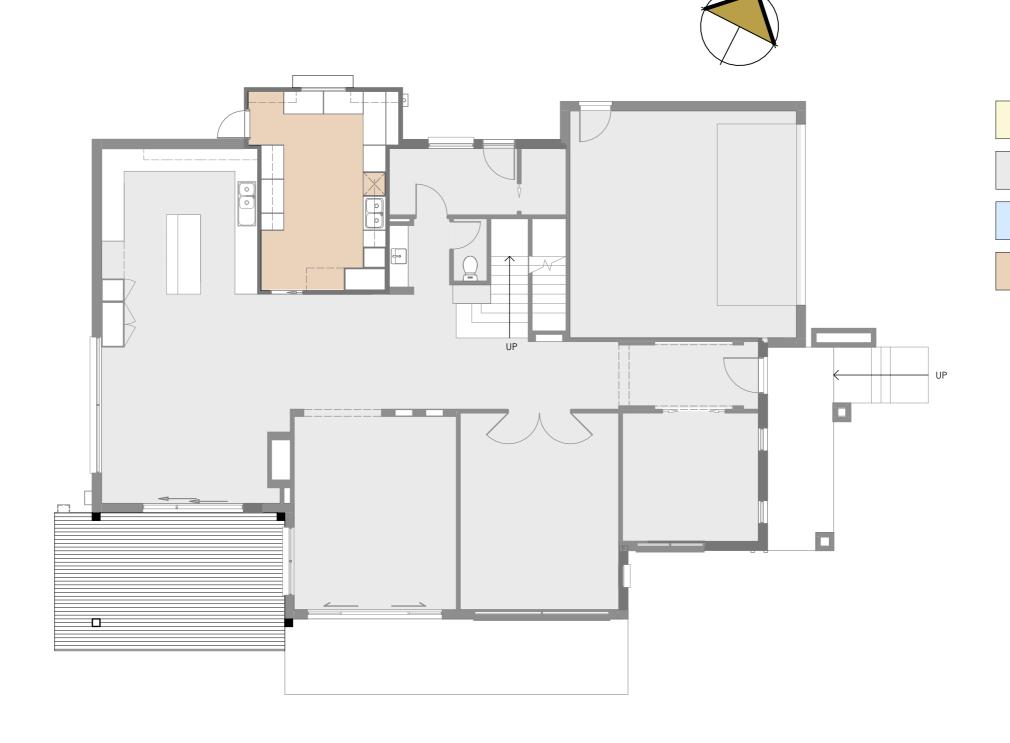



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proposed: **EXTENSION**

for: CINDY & CHEN TAN

address: 7 WESTHAM COURT

drawing: GROUND FLOOR COVERINGS

MULGRAVE, 3170

CARPET

EXISTING

TILES

job no.: **21-04085**

TIMBER







proposed: **EXTENSION**

for: CINDY & CHEN TAN drawing: FIRST FLOOR COVERINGS

address: 7 WESTHAM COURT MULGRAVE, 3170

sheet: **16** of **17**

date: 17/02/22

job no.: **21-04085**

CARPET

EXISTING

TILES

TIMBER

